
A9 Crubenmore to Kincraig

### The Proposed Scheme Part 2

Drawing No.	Drawing Type	Drawing Title	Projectwise Drawing Reference	Software
5.14	PROPOSED SCHEME PLAN	PLAN AND PROFILE chainage 40000 - 41500	A9P09-CFJ-EGN-M_ML400_ZZ-DR-EN-0005	CAD
5.15	PROPOSED SCHEME PLAN	PLAN AND PROFILE chainage 41500 - 43000	A9P09-CFJ-EGN-M_ML415_ZZ-DR-EN-0001	CAD
5.16	PROPOSED SCHEME PLAN	PLAN AND PROFILE chainage 43000 - 44500	A9P09-CFJ-EGN-M_ML430_ZZ-DR-EN-0001	CAD
5.17	PROPOSED SCHEME PLAN	PLAN AND PROFILE chainage 44500 - 46000	A9P09-CFJ-EGN-M_ML445_ZZ-DR-EN-0001	CAD
5.18	PROPOSED SCHEME PLAN	PLAN AND PROFILE chainage 46000 - 47500	A9P09-CFJ-EGN-M_ML460_ZZ-DR-EN-0001	CAD
5.19	PROPOSED SCHEME PLAN	PLAN AND PROFILE chainage 47500 - 49000	A9P09-CFJ-EGN-M_ML475_ZZ-DR-EN-0001	CAD
5.20	PROPOSED SCHEME PLAN	PLAN AND PROFILE chainage 49000 - 50500	A9P09-CFJ-EGN-M_ML490_ZZ-DR-EN-0001	CAD
5.21	PROPOSED SCHEME PLAN	PLAN AND PROFILE chainage 50500 - 52000	A9P09-CFJ-EGN-M_ML505_ZZ-DR-EN-0001	CAD
5.22	PROPOSED SCHEME PLAN	PLAN AND PROFILE chainage 52000 - 53500	A9P09-CFJ-EGN-M_ML520_ZZ-DR-EN-0001	CAD
5.23	PROPOSED SCHEME PLAN	PLAN AND PROFILE chainage 53500 - 55000	A9P09-CFJ-EGN-M_ML535_ZZ-DR-EN-0001	CAD
5.24	PROPOSED SCHEME PLAN	PLAN AND PROFILE chainage 55000 - 56500	A9P09-CFJ-EGN-M_ML550_ZZ-DR-EN-0004	CAD
5.25	PROPOSED SCHEME PLAN	PLAN AND PROFILE chainage 56500 - 56645	A9P09-CFJ-EGN-M_ML565_ZZ-DR-EN-0001	CAD

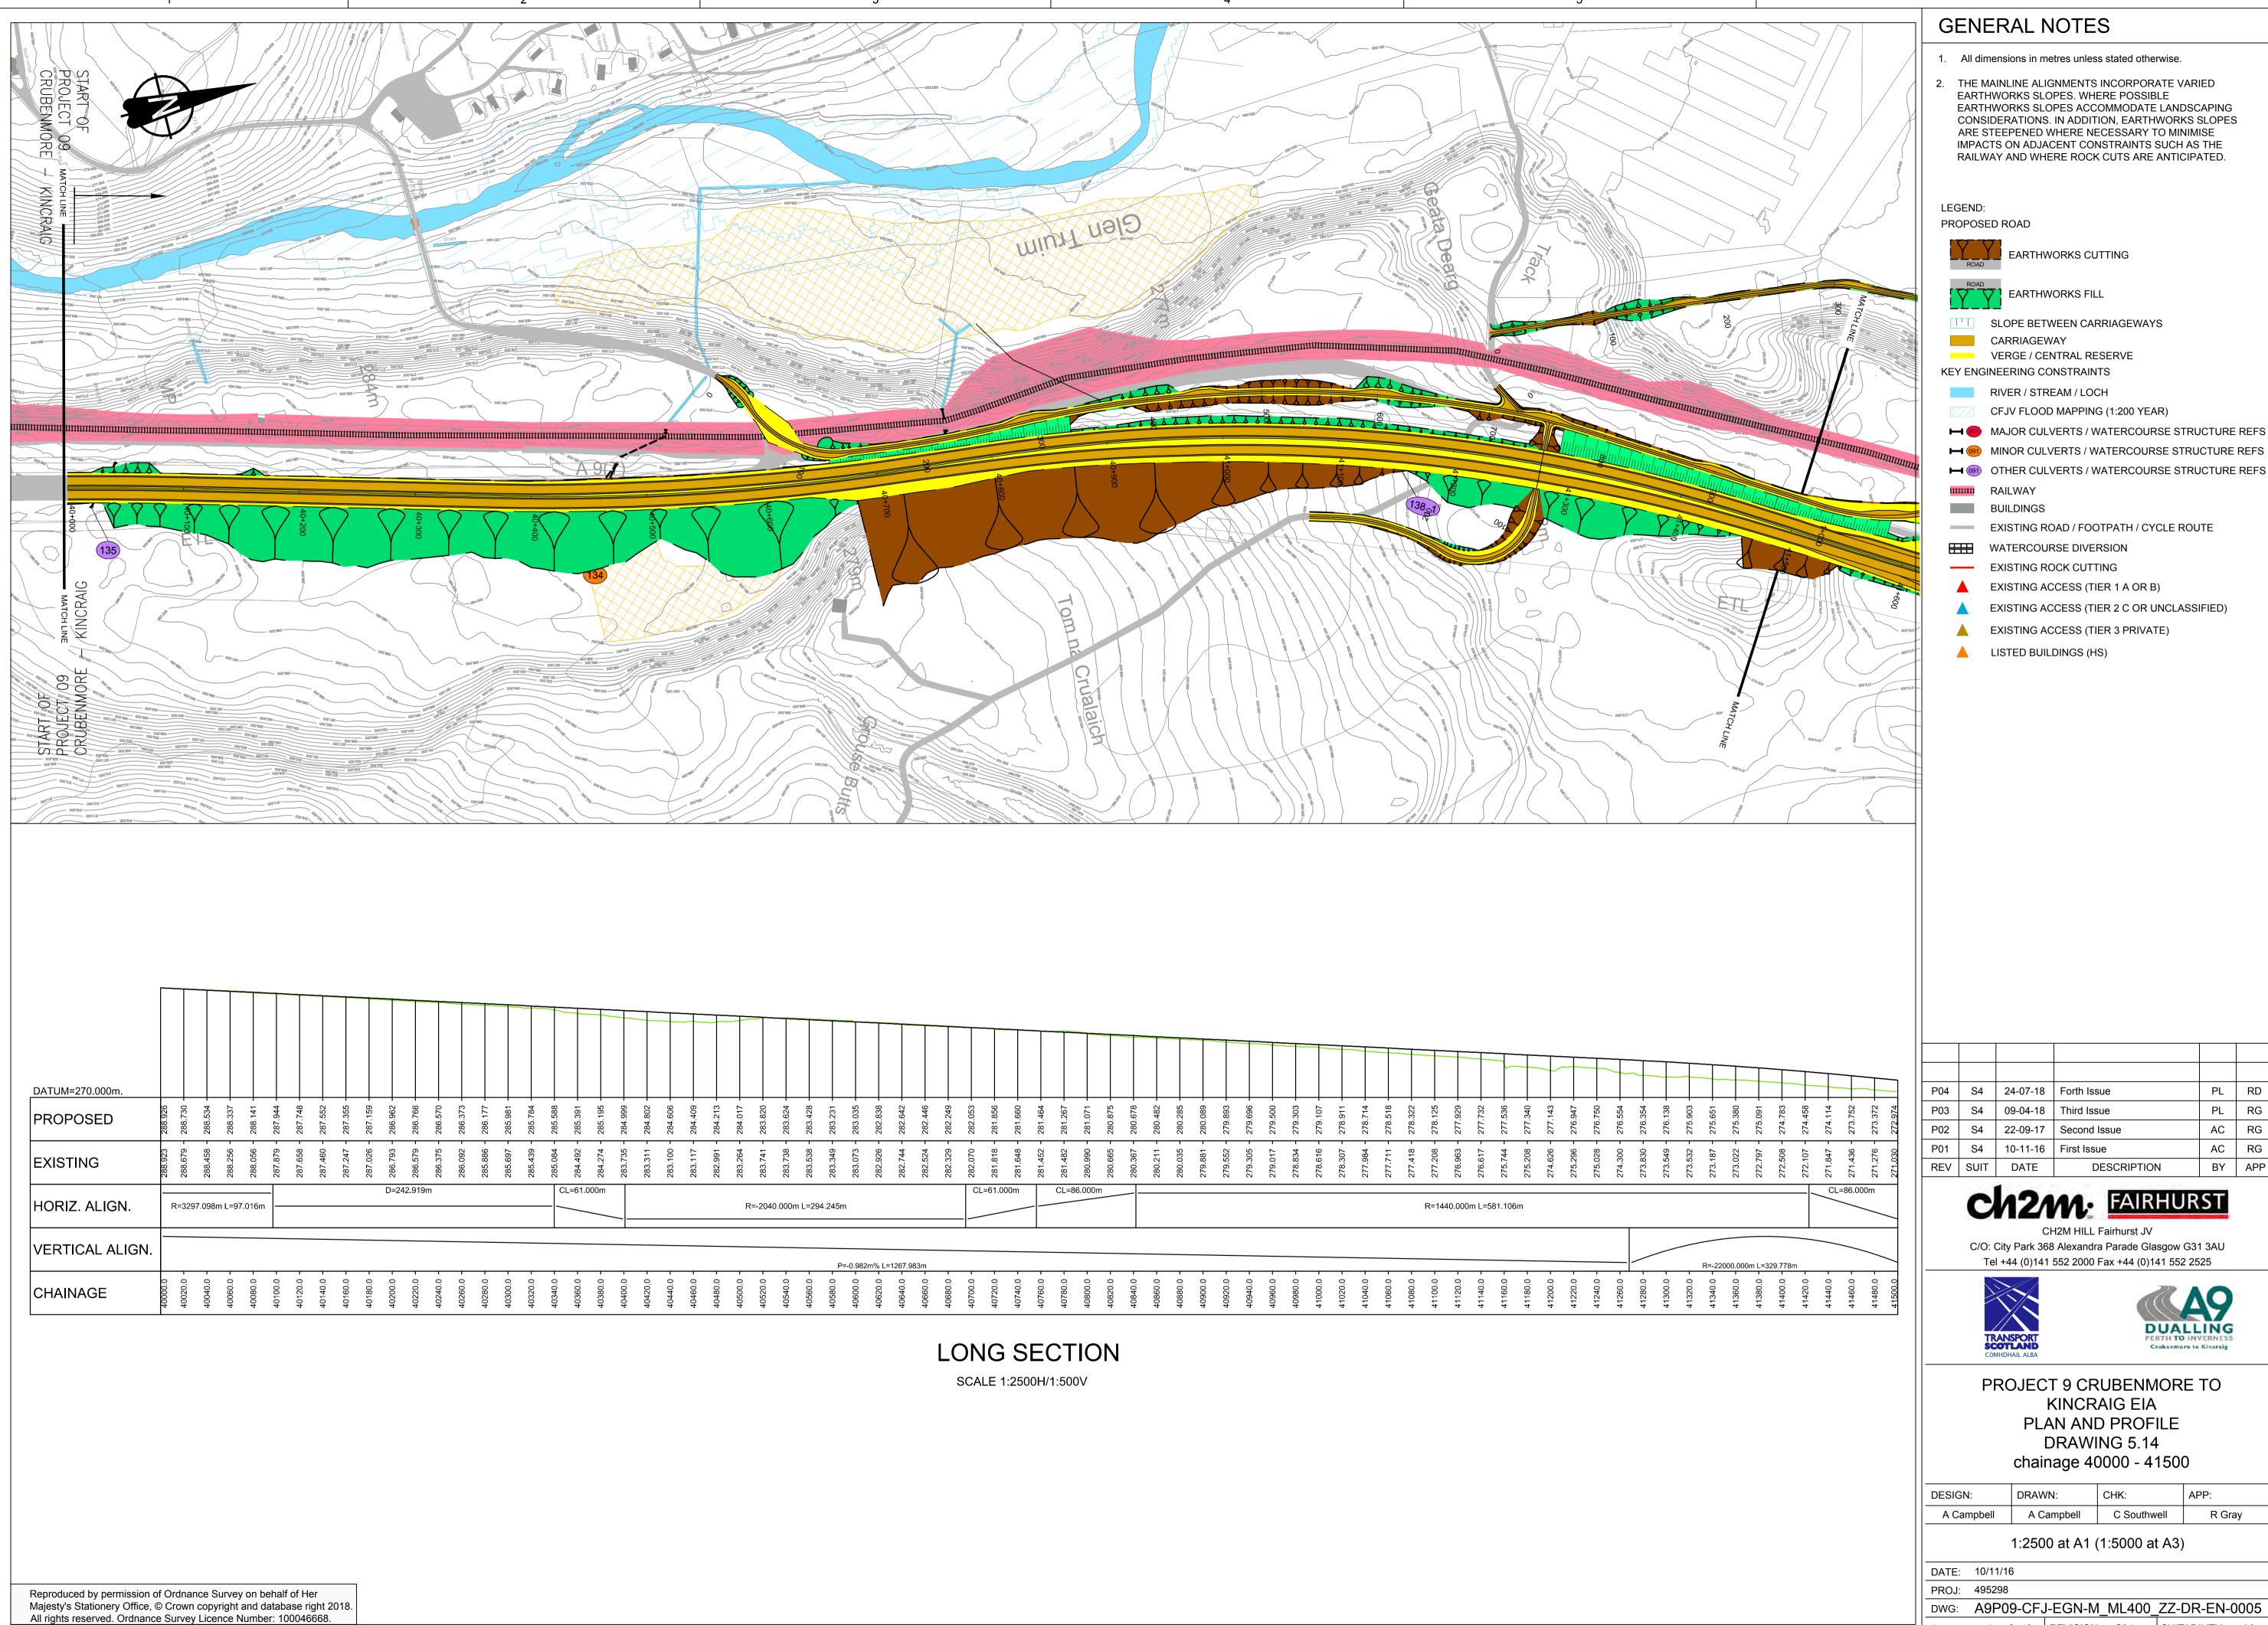



MAJOR CULVERTS / WATERCOURSE STRUCTURE REFS

→ (91) OTHER CULVERTS / WATERCOURSE STRUCTURE REFS

PL RD PL RG AC RG AC RG BY APP


C/O: City Park 368 Alexandra Parade Glasgow G31 3AU




PROJECT 9 CRUBENMORE TO

ESIGN:	DRAWN:	CHK:	APP:
A Campbell	A Campbell	C Southwell	R Gray
·	· · · · · · · · · · · · · · · · · · ·		

DWG: A9P09-CFJ-EGN-M\_ML400\_ZZ-DR-EN-0005 SHEET: 1 of 12 REVISION: C01 SUITABILITY: A3

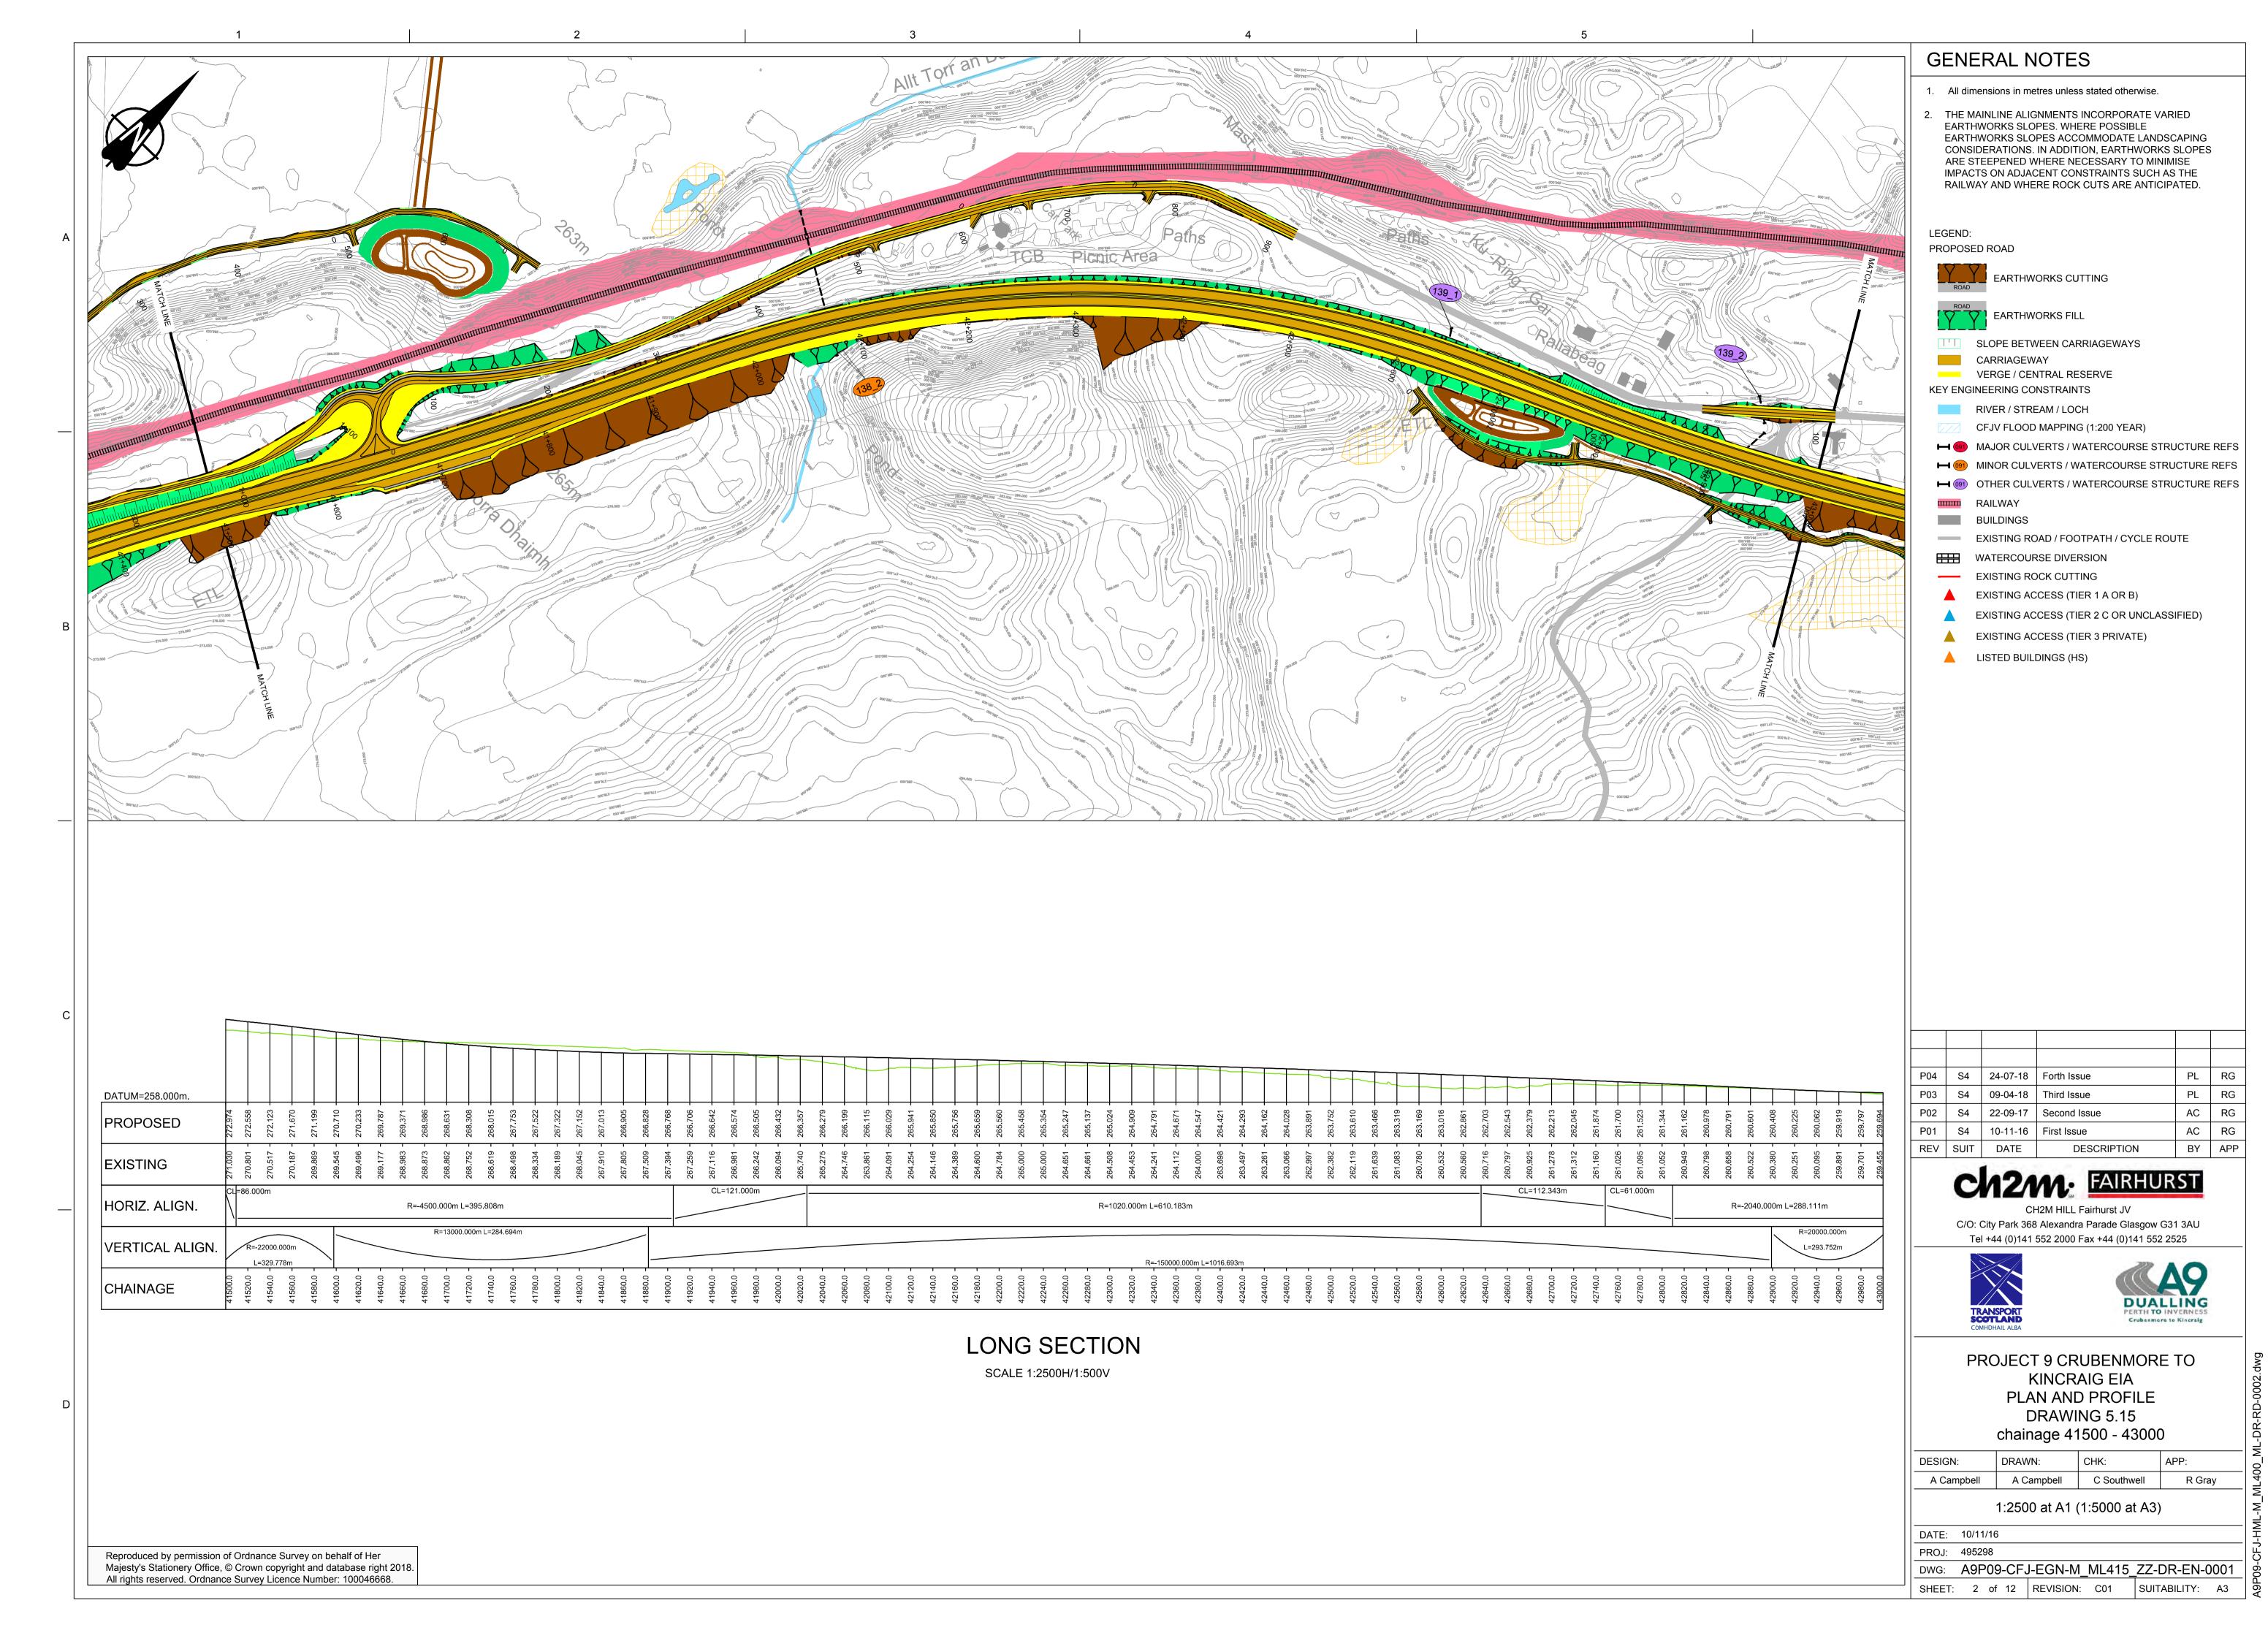

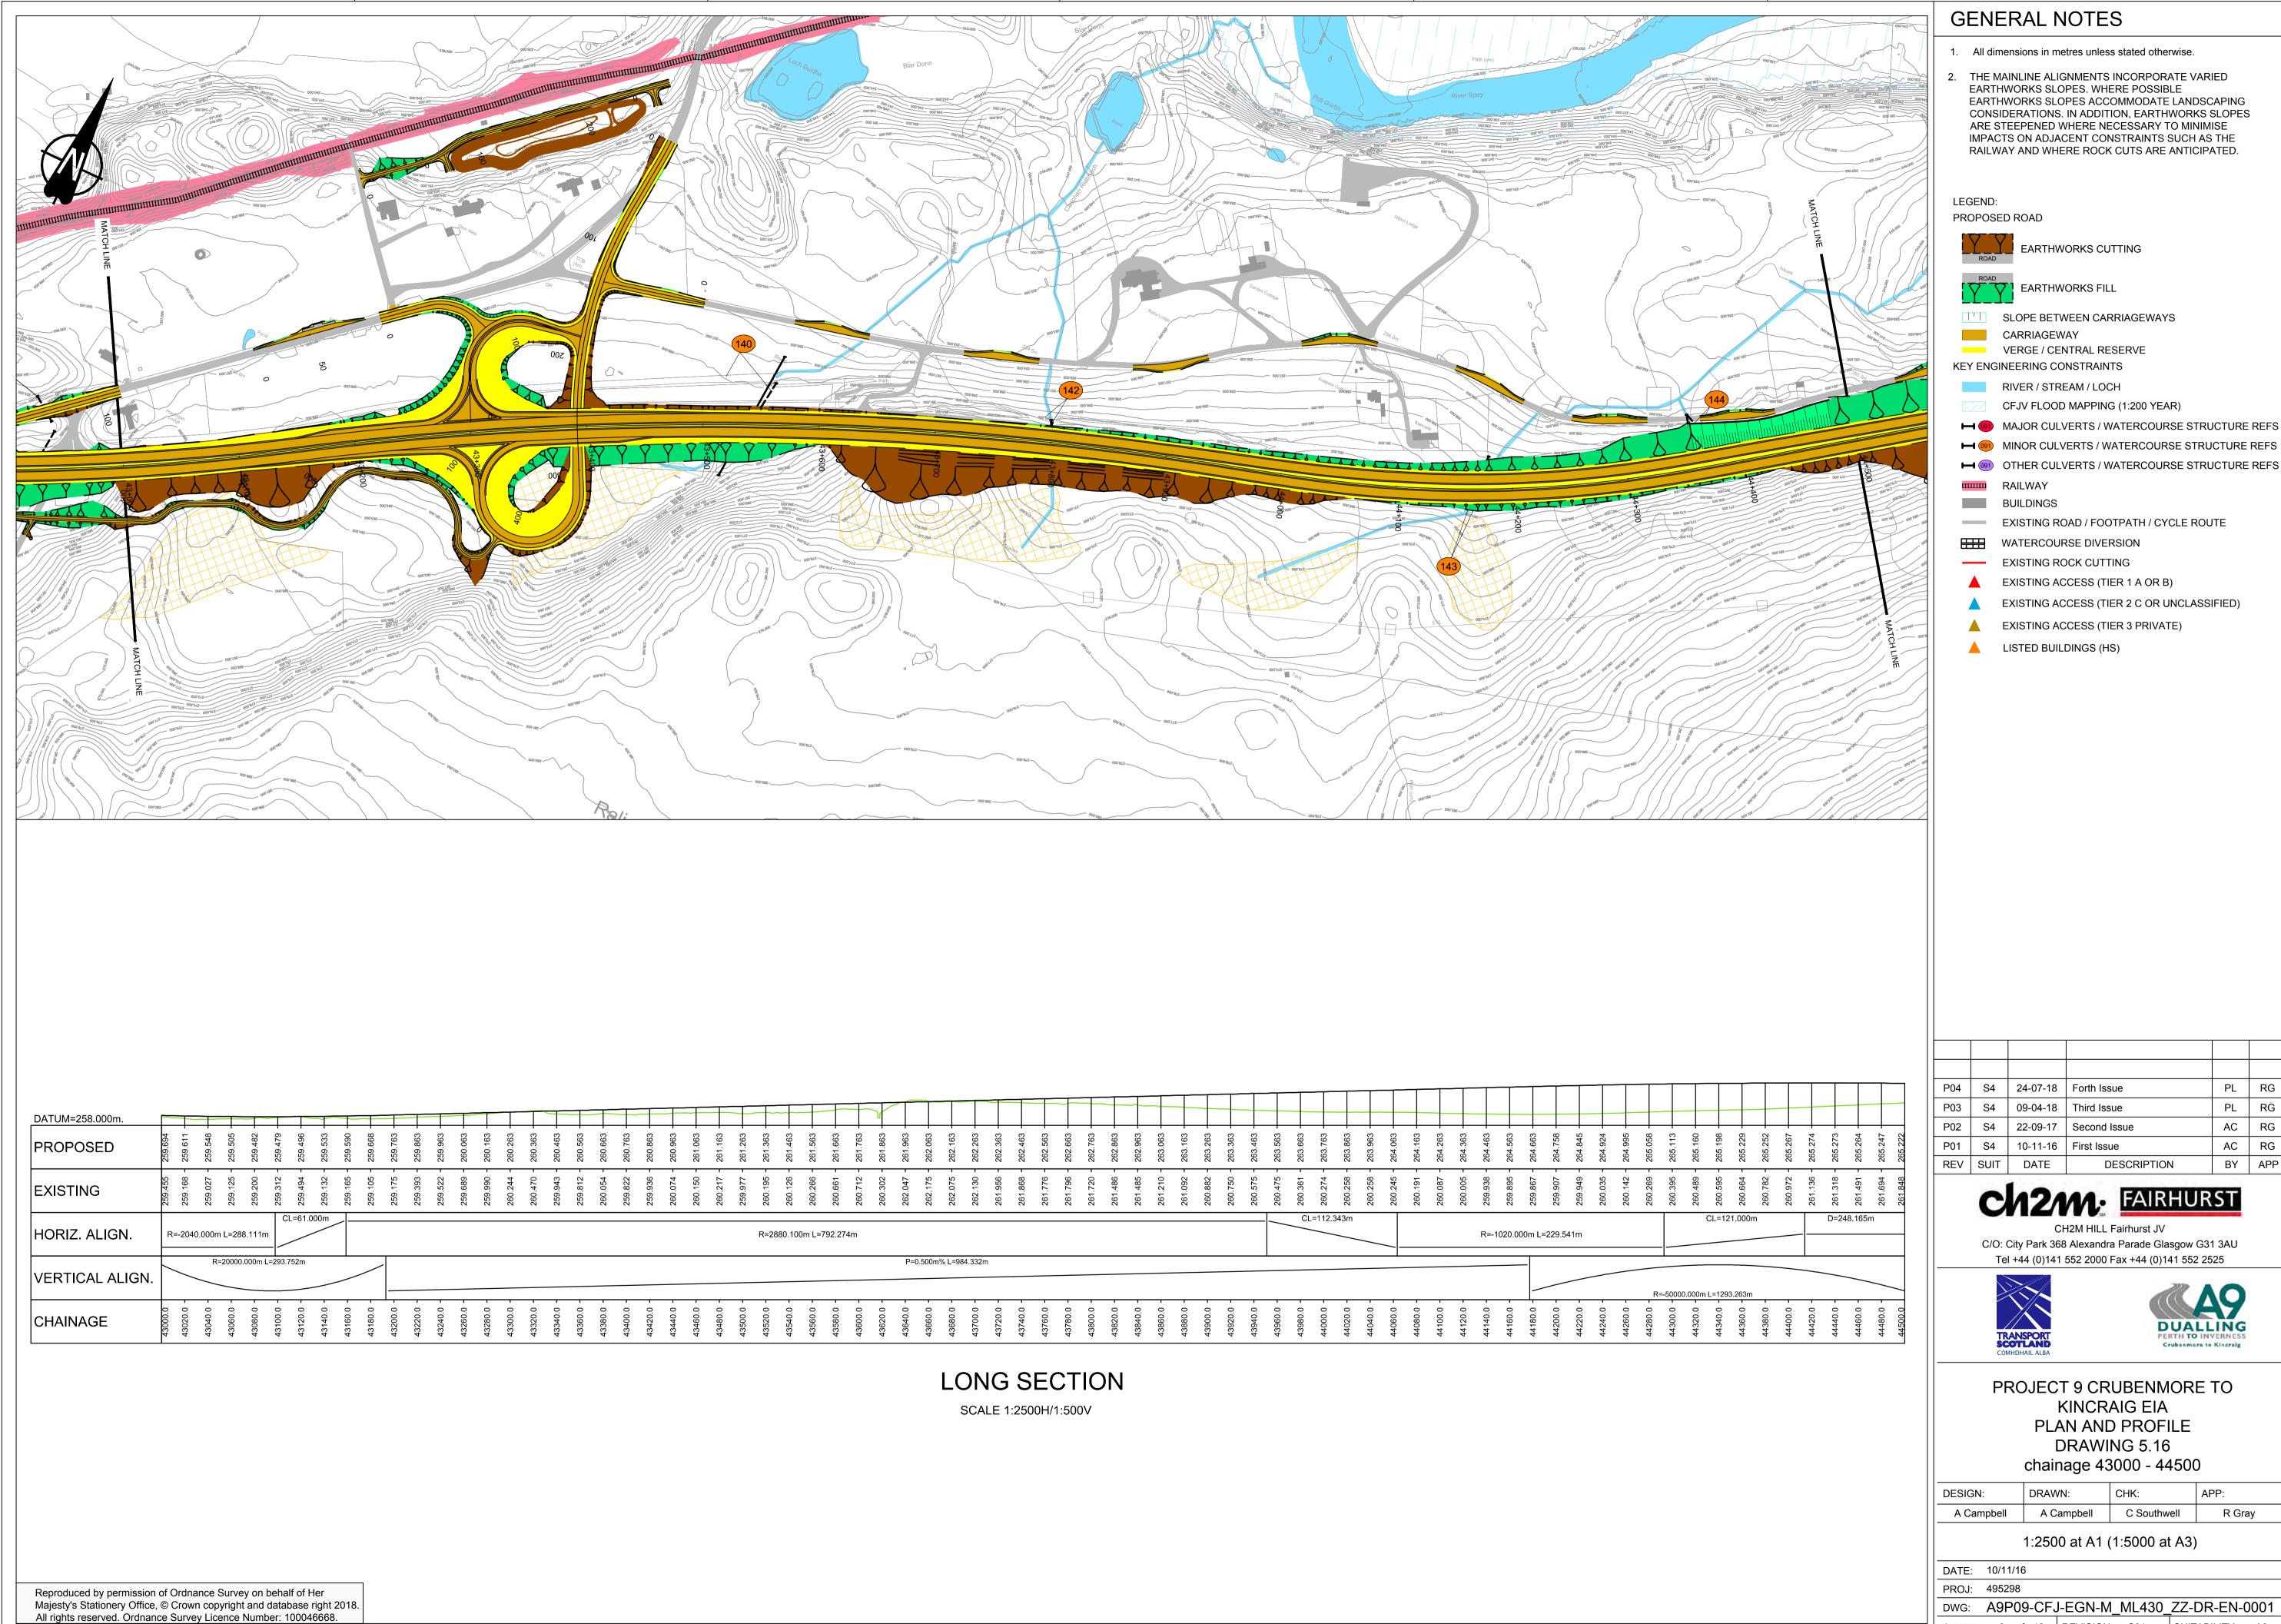

MAJOR CULVERTS / WATERCOURSE STRUCTURE REFS


→ (91) OTHER CULVERTS / WATERCOURSE STRUCTURE REFS

PL RG PL RG AC RG AC RG BY APP



DESIGN:	DRAWN:	CHK:	APP:
A Campbell	A Campbell	C Southwell	R Gray
A Campbell	A Campbell	C Southwell	R Gray

DWG: A9P09-CFJ-EGN-M\_ML430\_ZZ-DR-EN-0001 SHEET: 3 of 12 REVISION: C01 SUITABILITY: A3

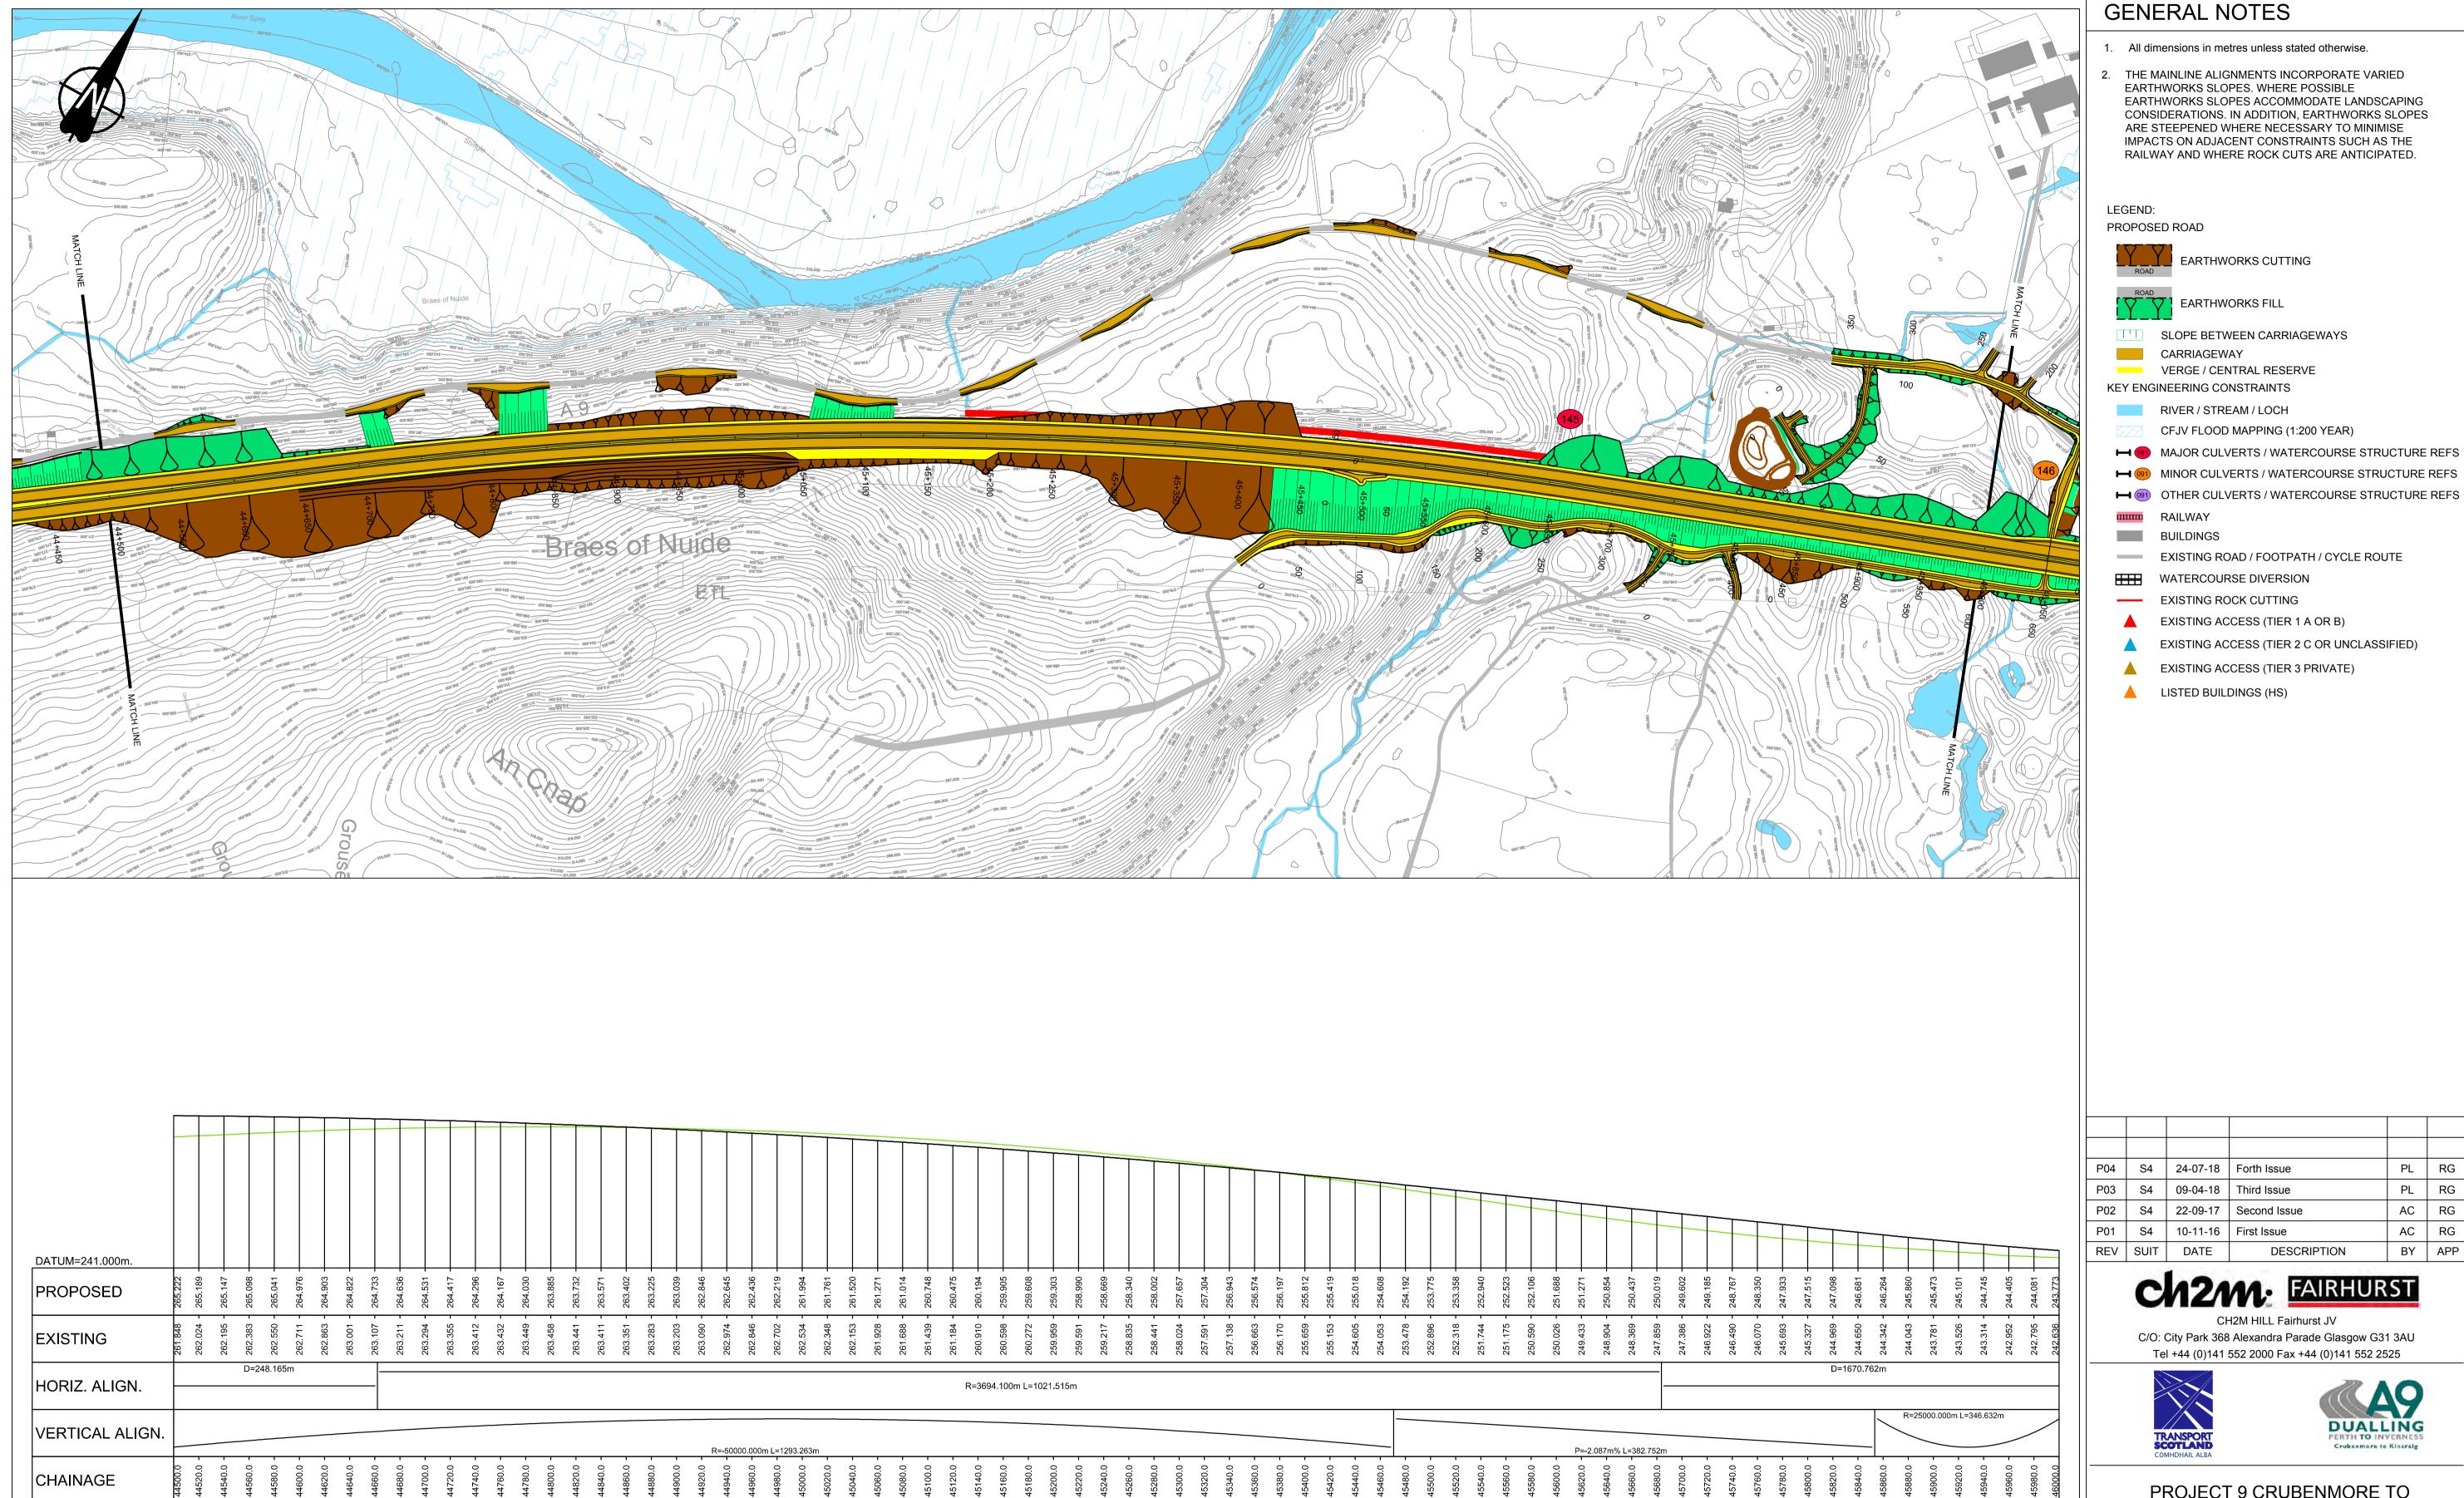

# LONG SECTION

SCALE 1:2500H/1:500V

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PROJECT 9 CRUBENMORE TO KINCRAIG EIA PLAN AND PROFILE

> DRAWING 5.17 chainage 44500 - 46000

DESIGN:	DRAWN:	CHK:	APP:
A Campbell	A Campbell	C Southwell	R Gray

1:2500 at A1 (1:5000 at A3)

DATE: 10/11/16

DWG: A9P09-CFJ-EGN-M\_ML445\_ZZ-DR-EN-0001 SHEET: 4 of 12 REVISION: C01 SUITABILITY: A3


PL RG

PL RG

AC RG

AC RG

BY APP

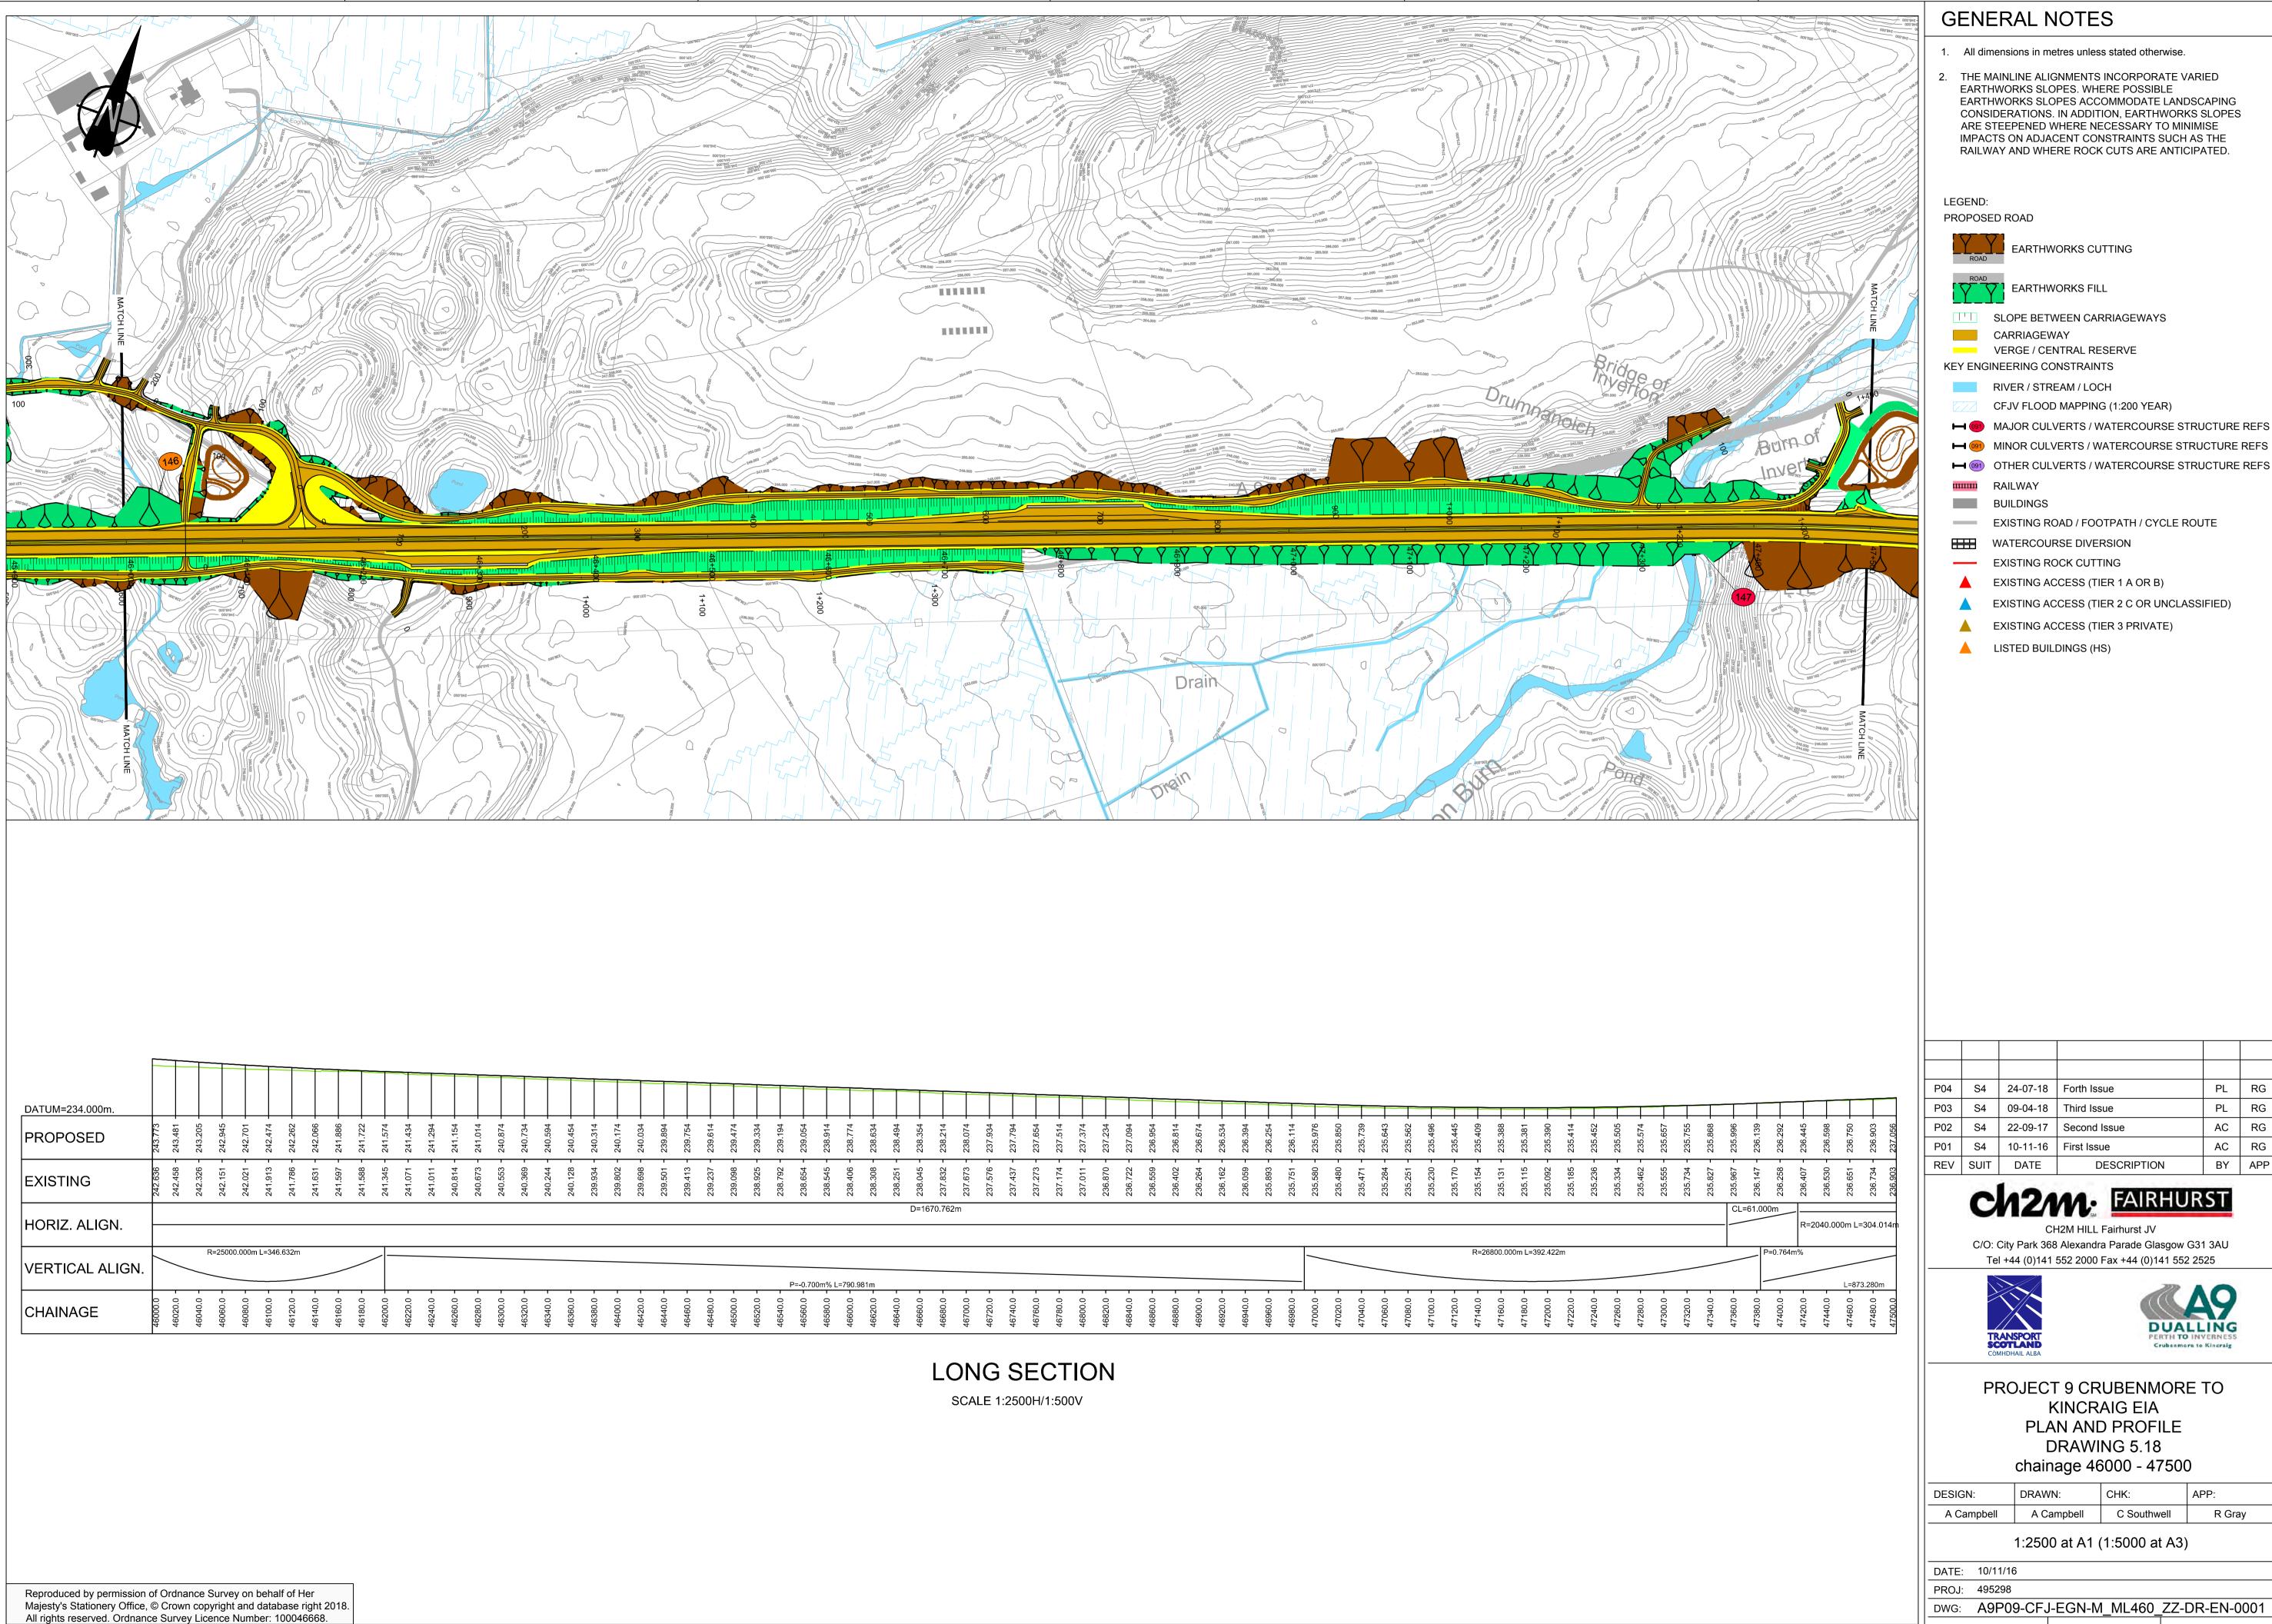

→ (91) OTHER CULVERTS / WATERCOURSE STRUCTURE REFS


PL RG PL RG AC RG AC RG BY APP

C/O: City Park 368 Alexandra Parade Glasgow G31 3AU



ESIGN:	DRAWN:	CHK:	APP:
A Campbell	A Campbell	C Southwell	R Gray

DWG: A9P09-CFJ-EGN-M\_ML460\_ZZ-DR-EN-0001 SHEET: 5 of 12 REVISION: C01 SUITABILITY: A3

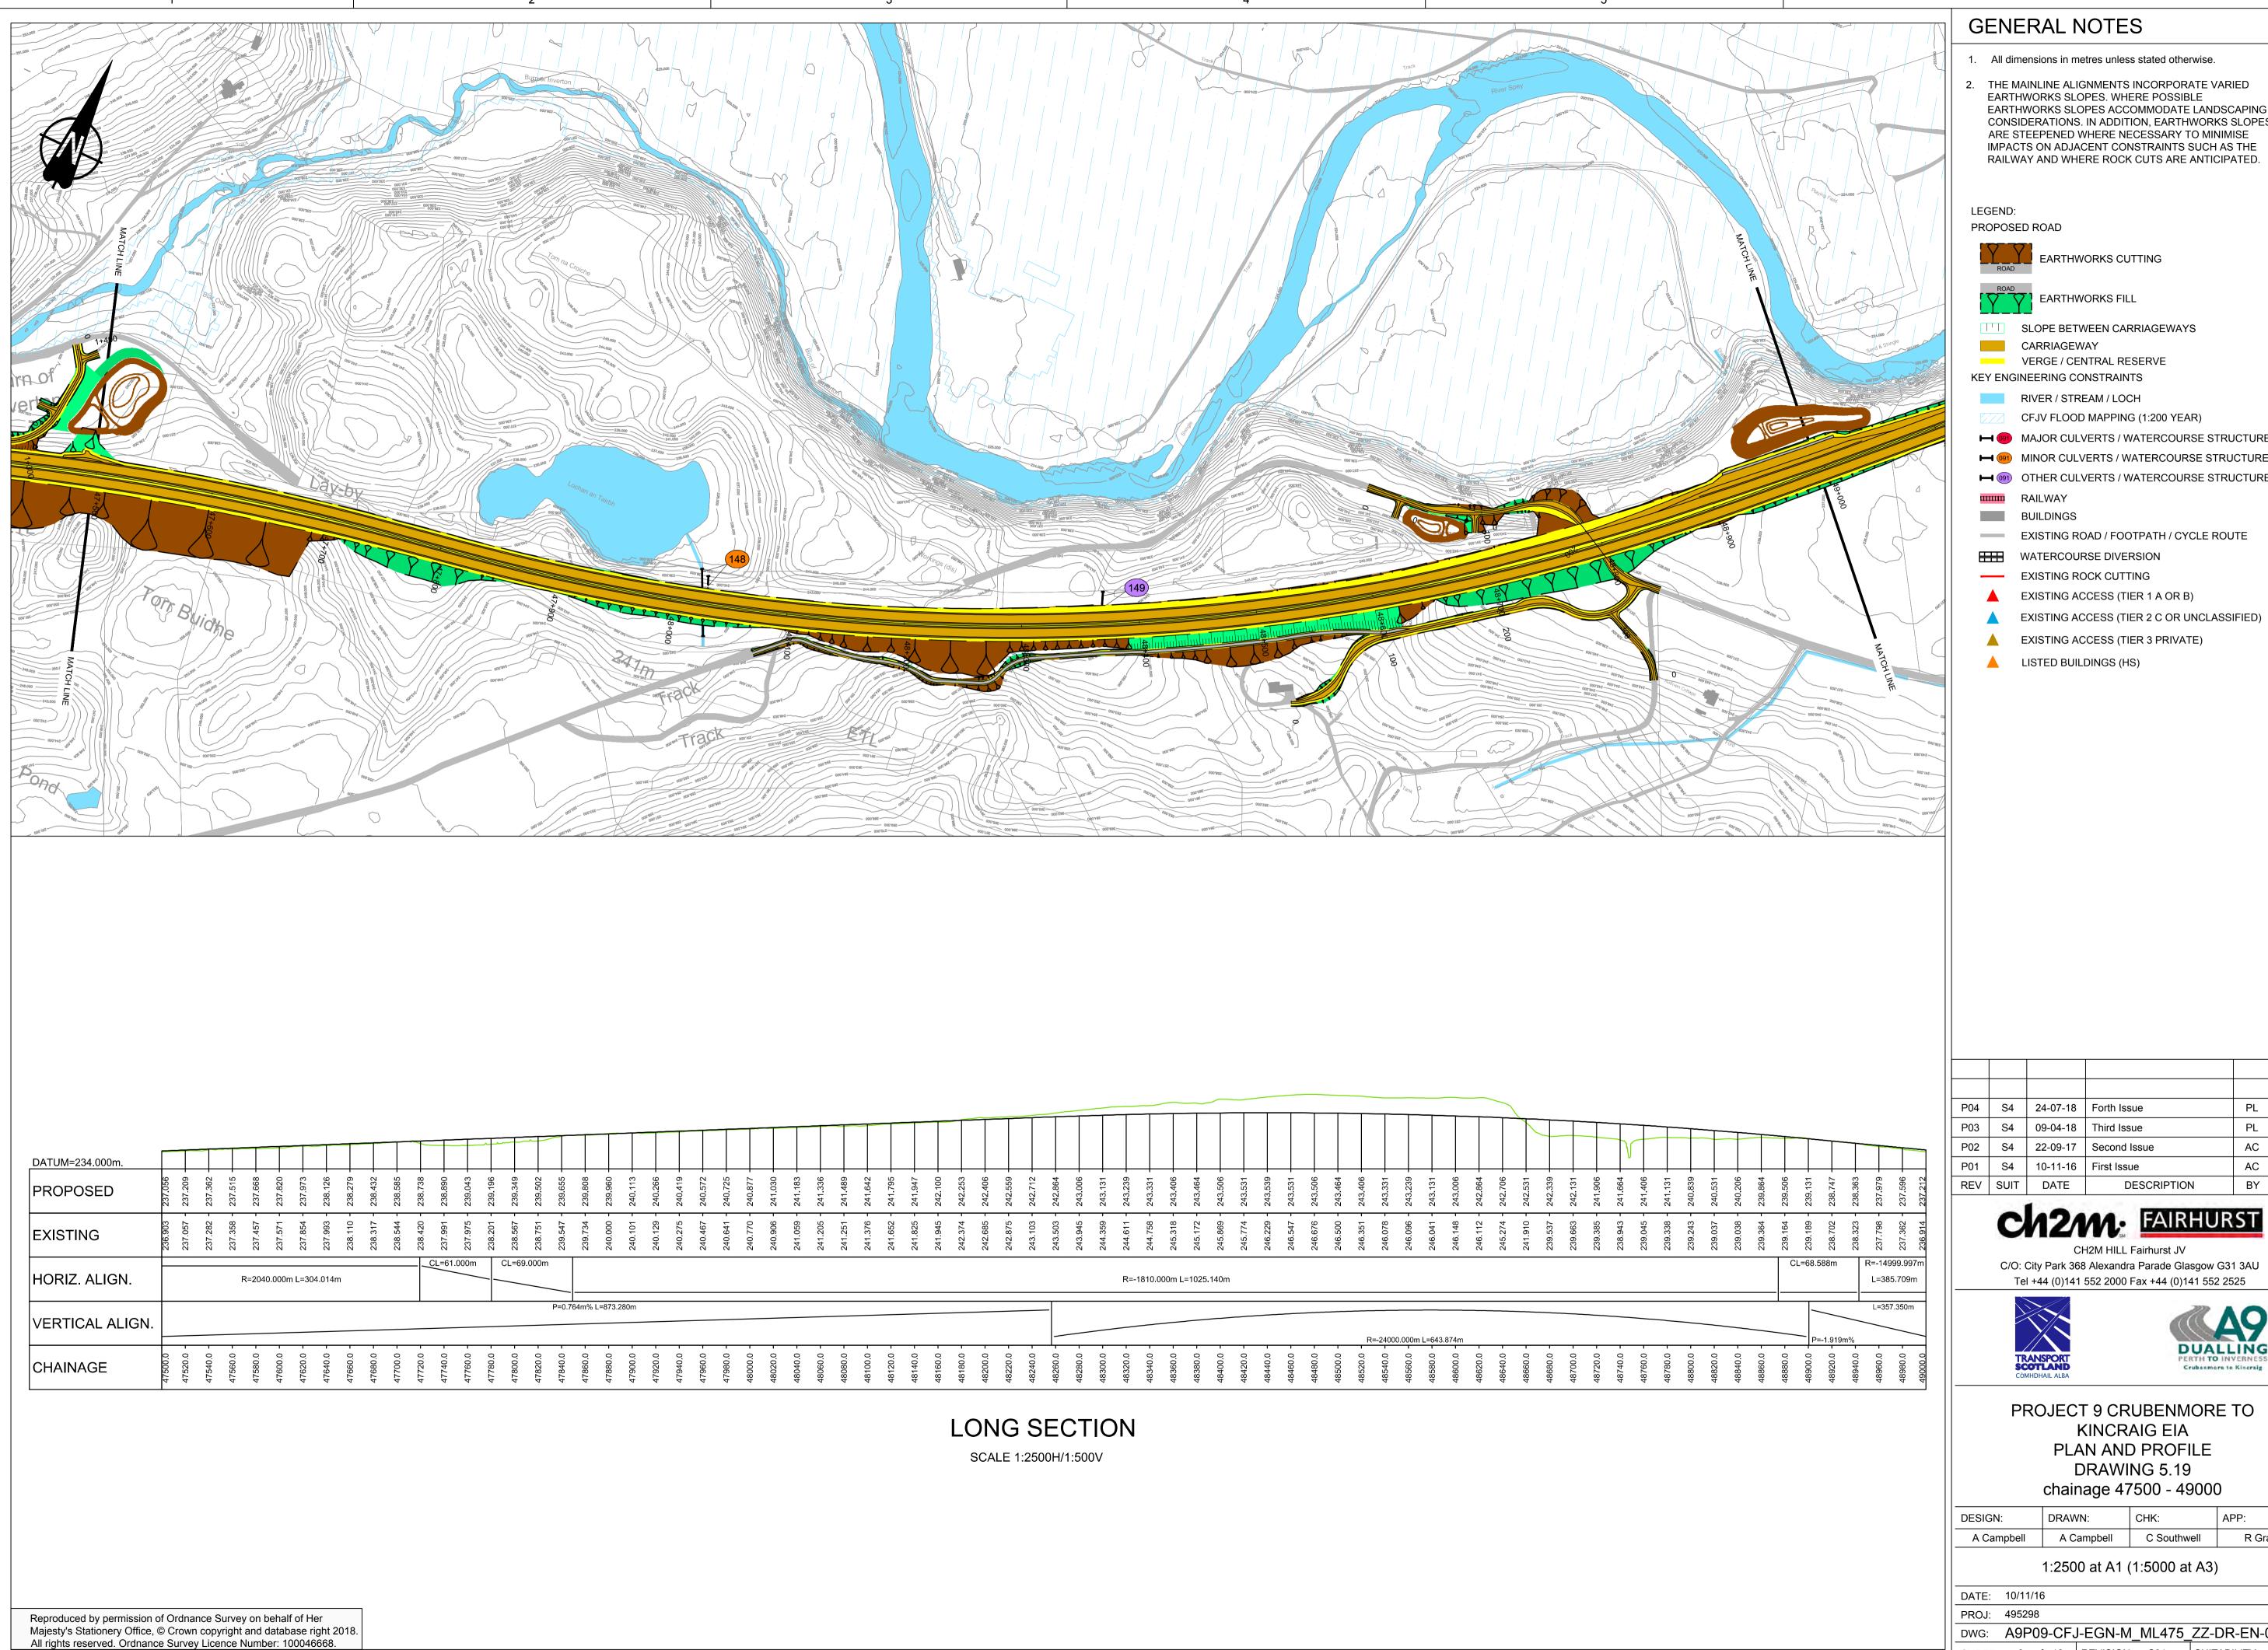

MAJOR CULVERTS / WATERCOURSE STRUCTURE REFS

MINOR CULVERTS / WATERCOURSE STRUCTURE REFS

→ (91) OTHER CULVERTS / WATERCOURSE STRUCTURE REFS


PL RG PL RG AC RG AC RG BY APP

C/O: City Park 368 Alexandra Parade Glasgow G31 3AU Tel +44 (0)141 552 2000 Fax +44 (0)141 552 2525



DESIGN:	DRAWN:	CHK:	APP:
A Campbell	A Campbell	C Southwell	R Gray

DWG: A9P09-CFJ-EGN-M\_ML475\_ZZ-DR-EN-0001 SHEET: 6 of 12 REVISION: C01 SUITABILITY: A3

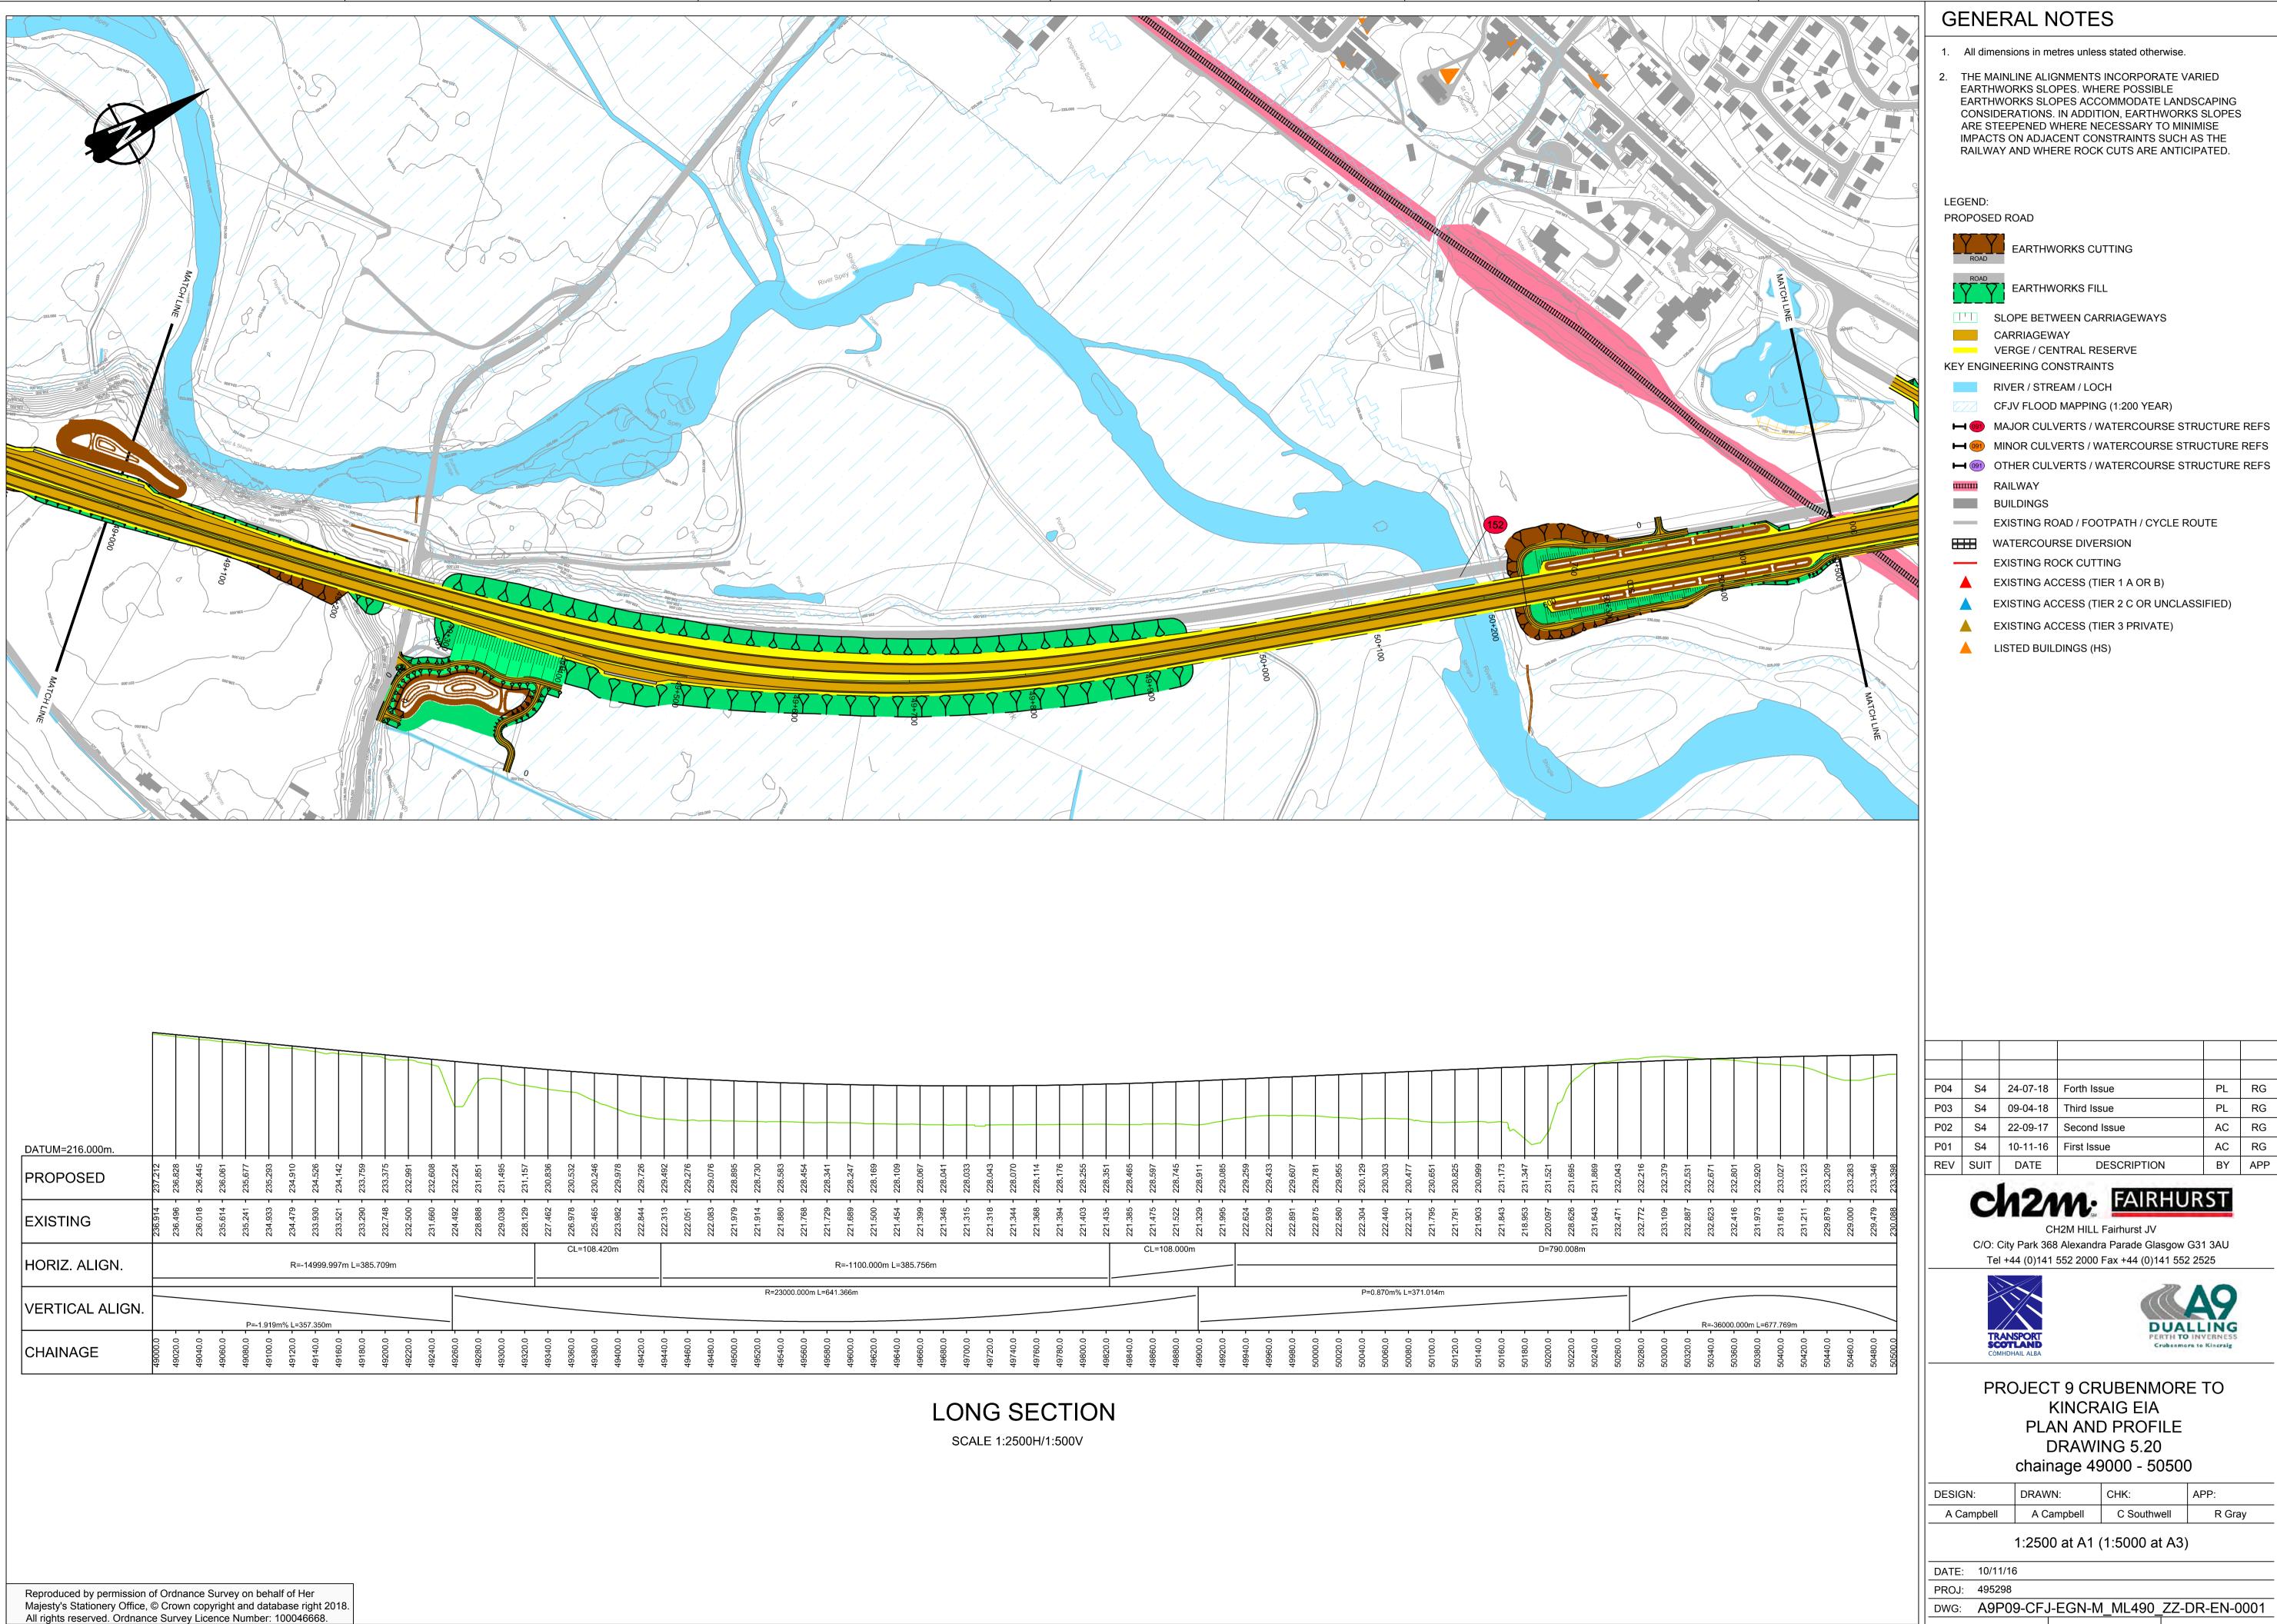

OTHER CULVERTS / WATERCOURSE STRUCTURE REFS

PL RG PL RG AC RG AC RG BY APP


C/O: City Park 368 Alexandra Parade Glasgow G31 3AU Tel +44 (0)141 552 2000 Fax +44 (0)141 552 2525



PROJECT 9 CRUBENMORE TO PLAN AND PROFILE

SIGN:	DRAWN:	CHK:	APP:
A Campbell	A Campbell	C Southwell	R Gray

DWG: A9P09-CFJ-EGN-M\_ML490\_ZZ-DR-EN-0001 SHEET: 7 of 12 REVISION: C01 SUITABILITY: A3

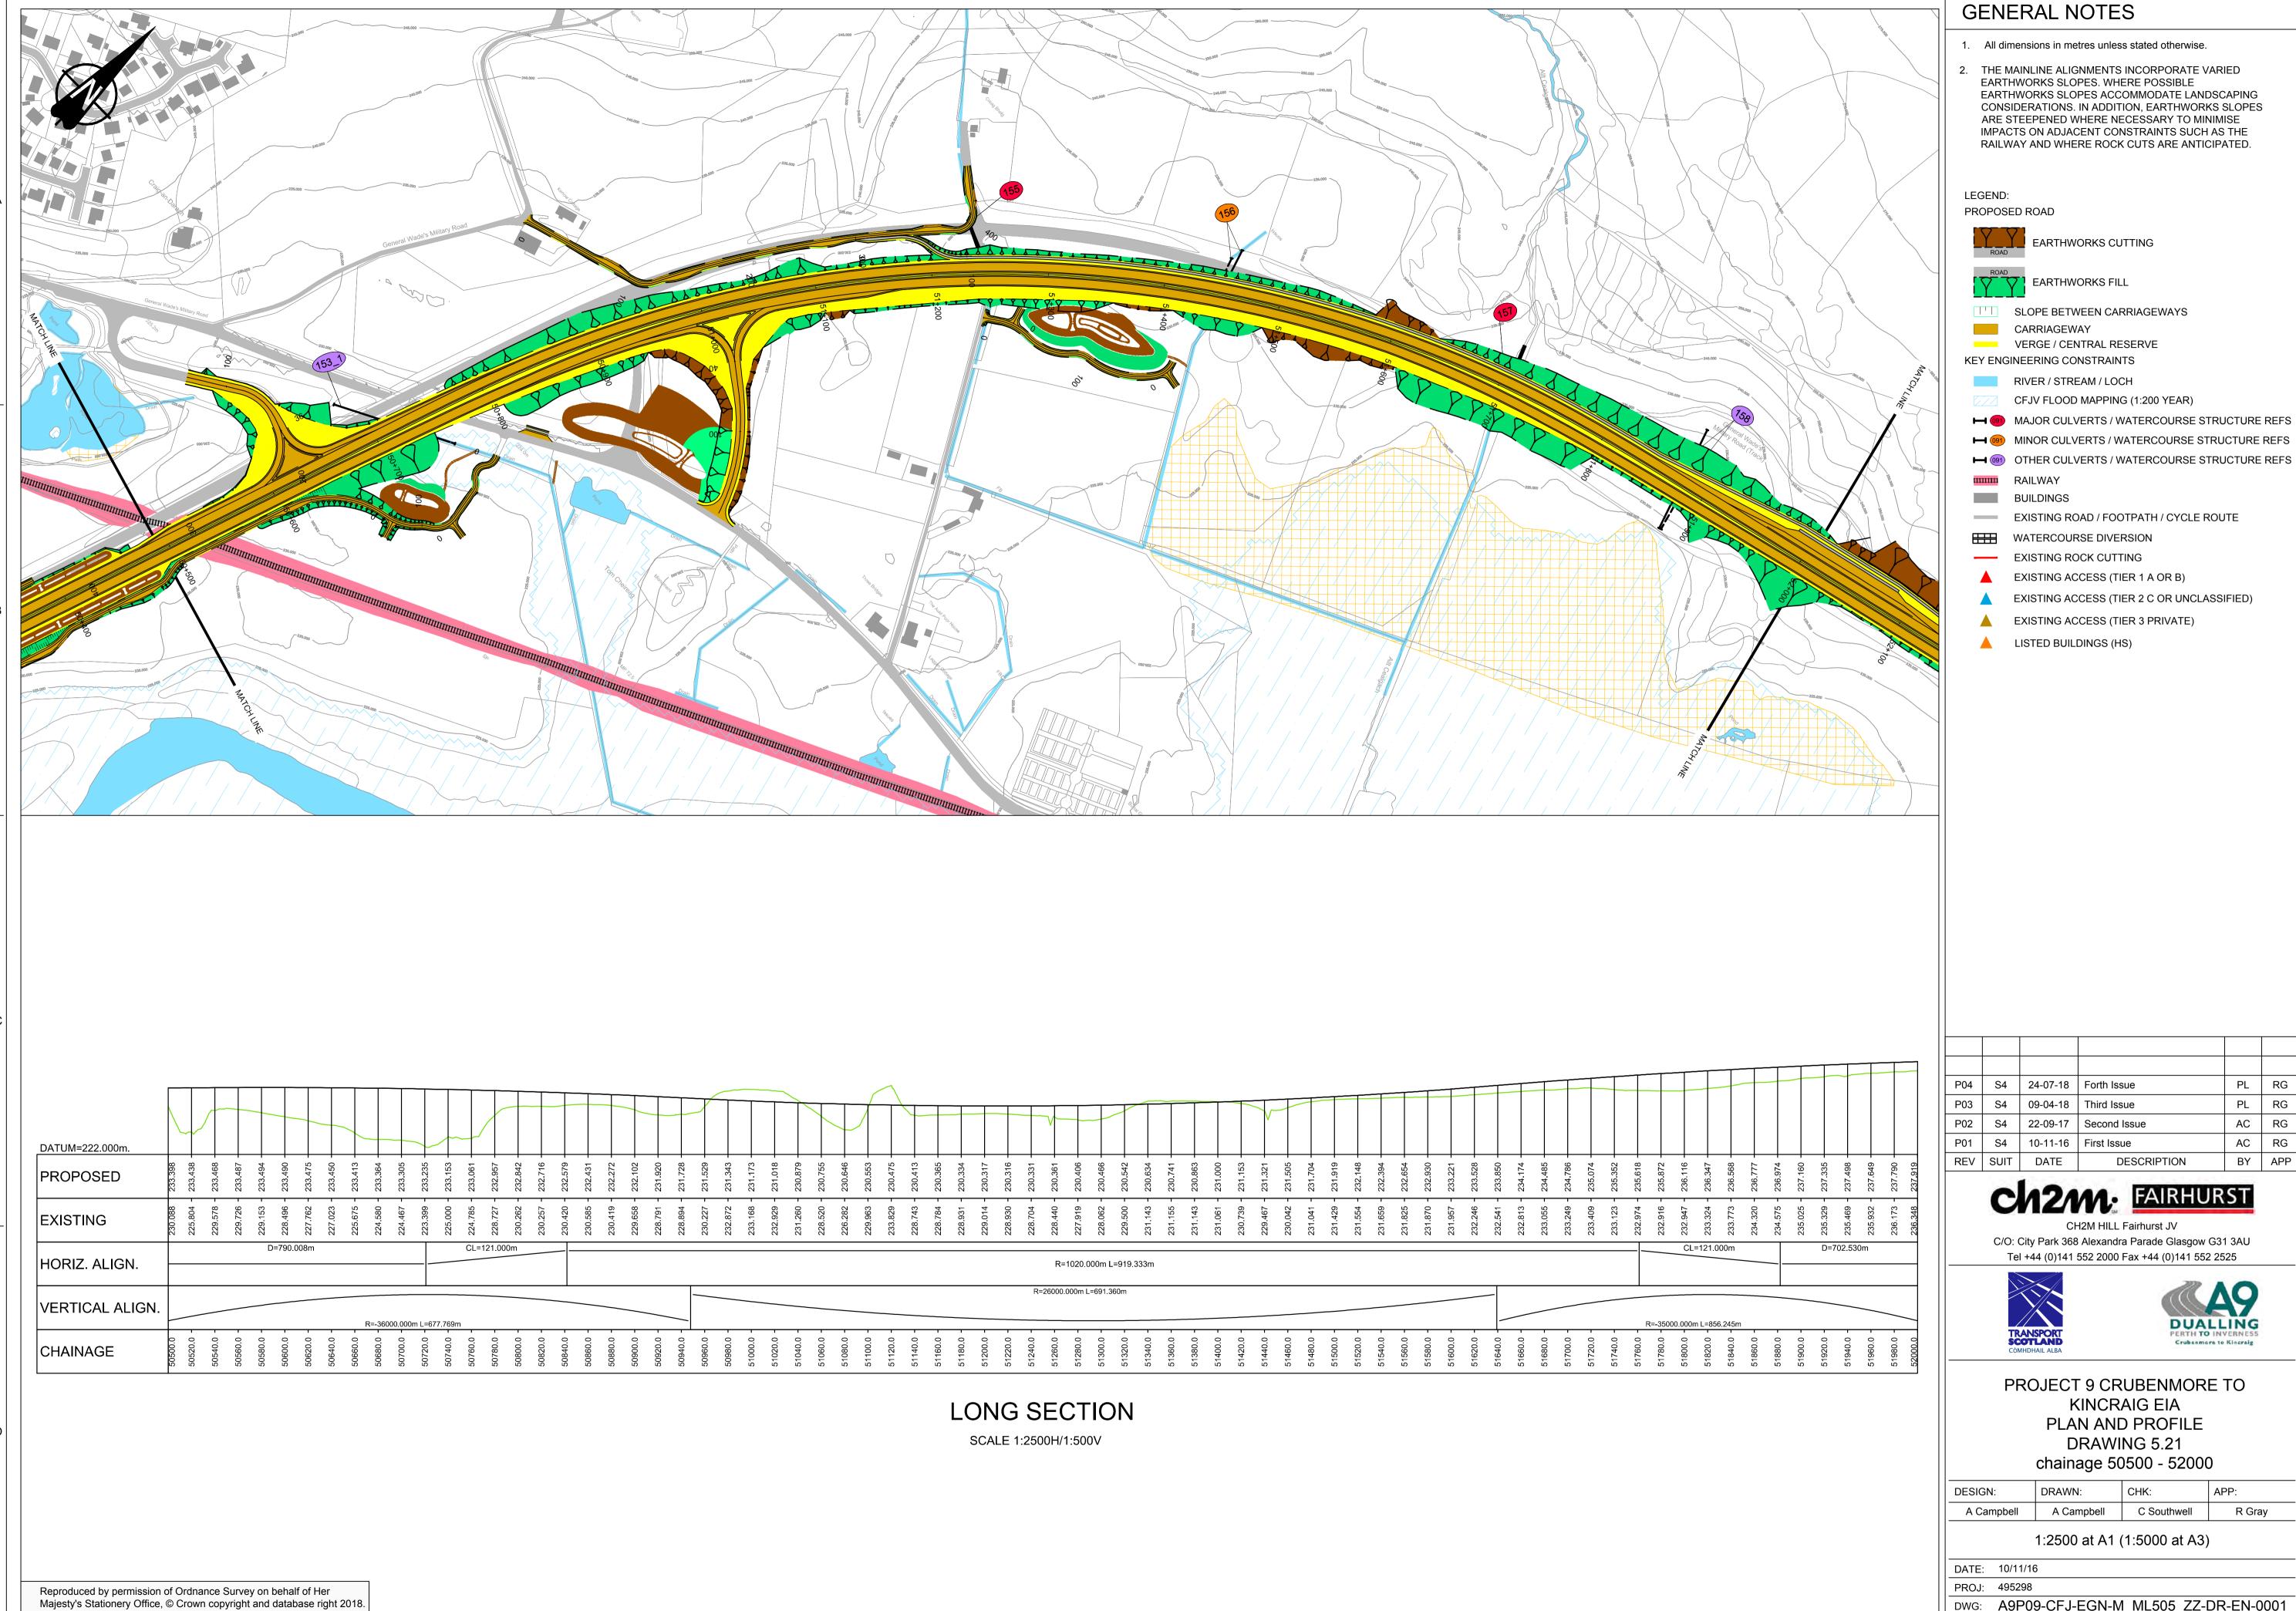

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2. THE MAINLINE ALIGNMENTS INCORPORATE VARIED EARTHWORKS SLOPES ACCOMMODATE LANDSCAPING CONSIDERATIONS. IN ADDITION, EARTHWORKS SLOPES ARE STEEPENED WHERE NECESSARY TO MINIMISE IMPACTS ON ADJACENT CONSTRAINTS SUCH AS THE

MAJOR CULVERTS / WATERCOURSE STRUCTURE REFS

MINOR CULVERTS / WATERCOURSE STRUCTURE REFS

PL RG PL RG AC RG AC RG BY APP


C/O: City Park 368 Alexandra Parade Glasgow G31 3AU Tel +44 (0)141 552 2000 Fax +44 (0)141 552 2525




PROJECT 9 CRUBENMORE TO

ESIGN:	DRAWN:	CHK:	APP:
A Campbell	A Campbell	C Southwell	R Gray

DWG: A9P09-CFJ-EGN-M\_ML505\_ZZ-DR-EN-0001 SHEET: 8 of 12 REVISION: C01 SUITABILITY: A3

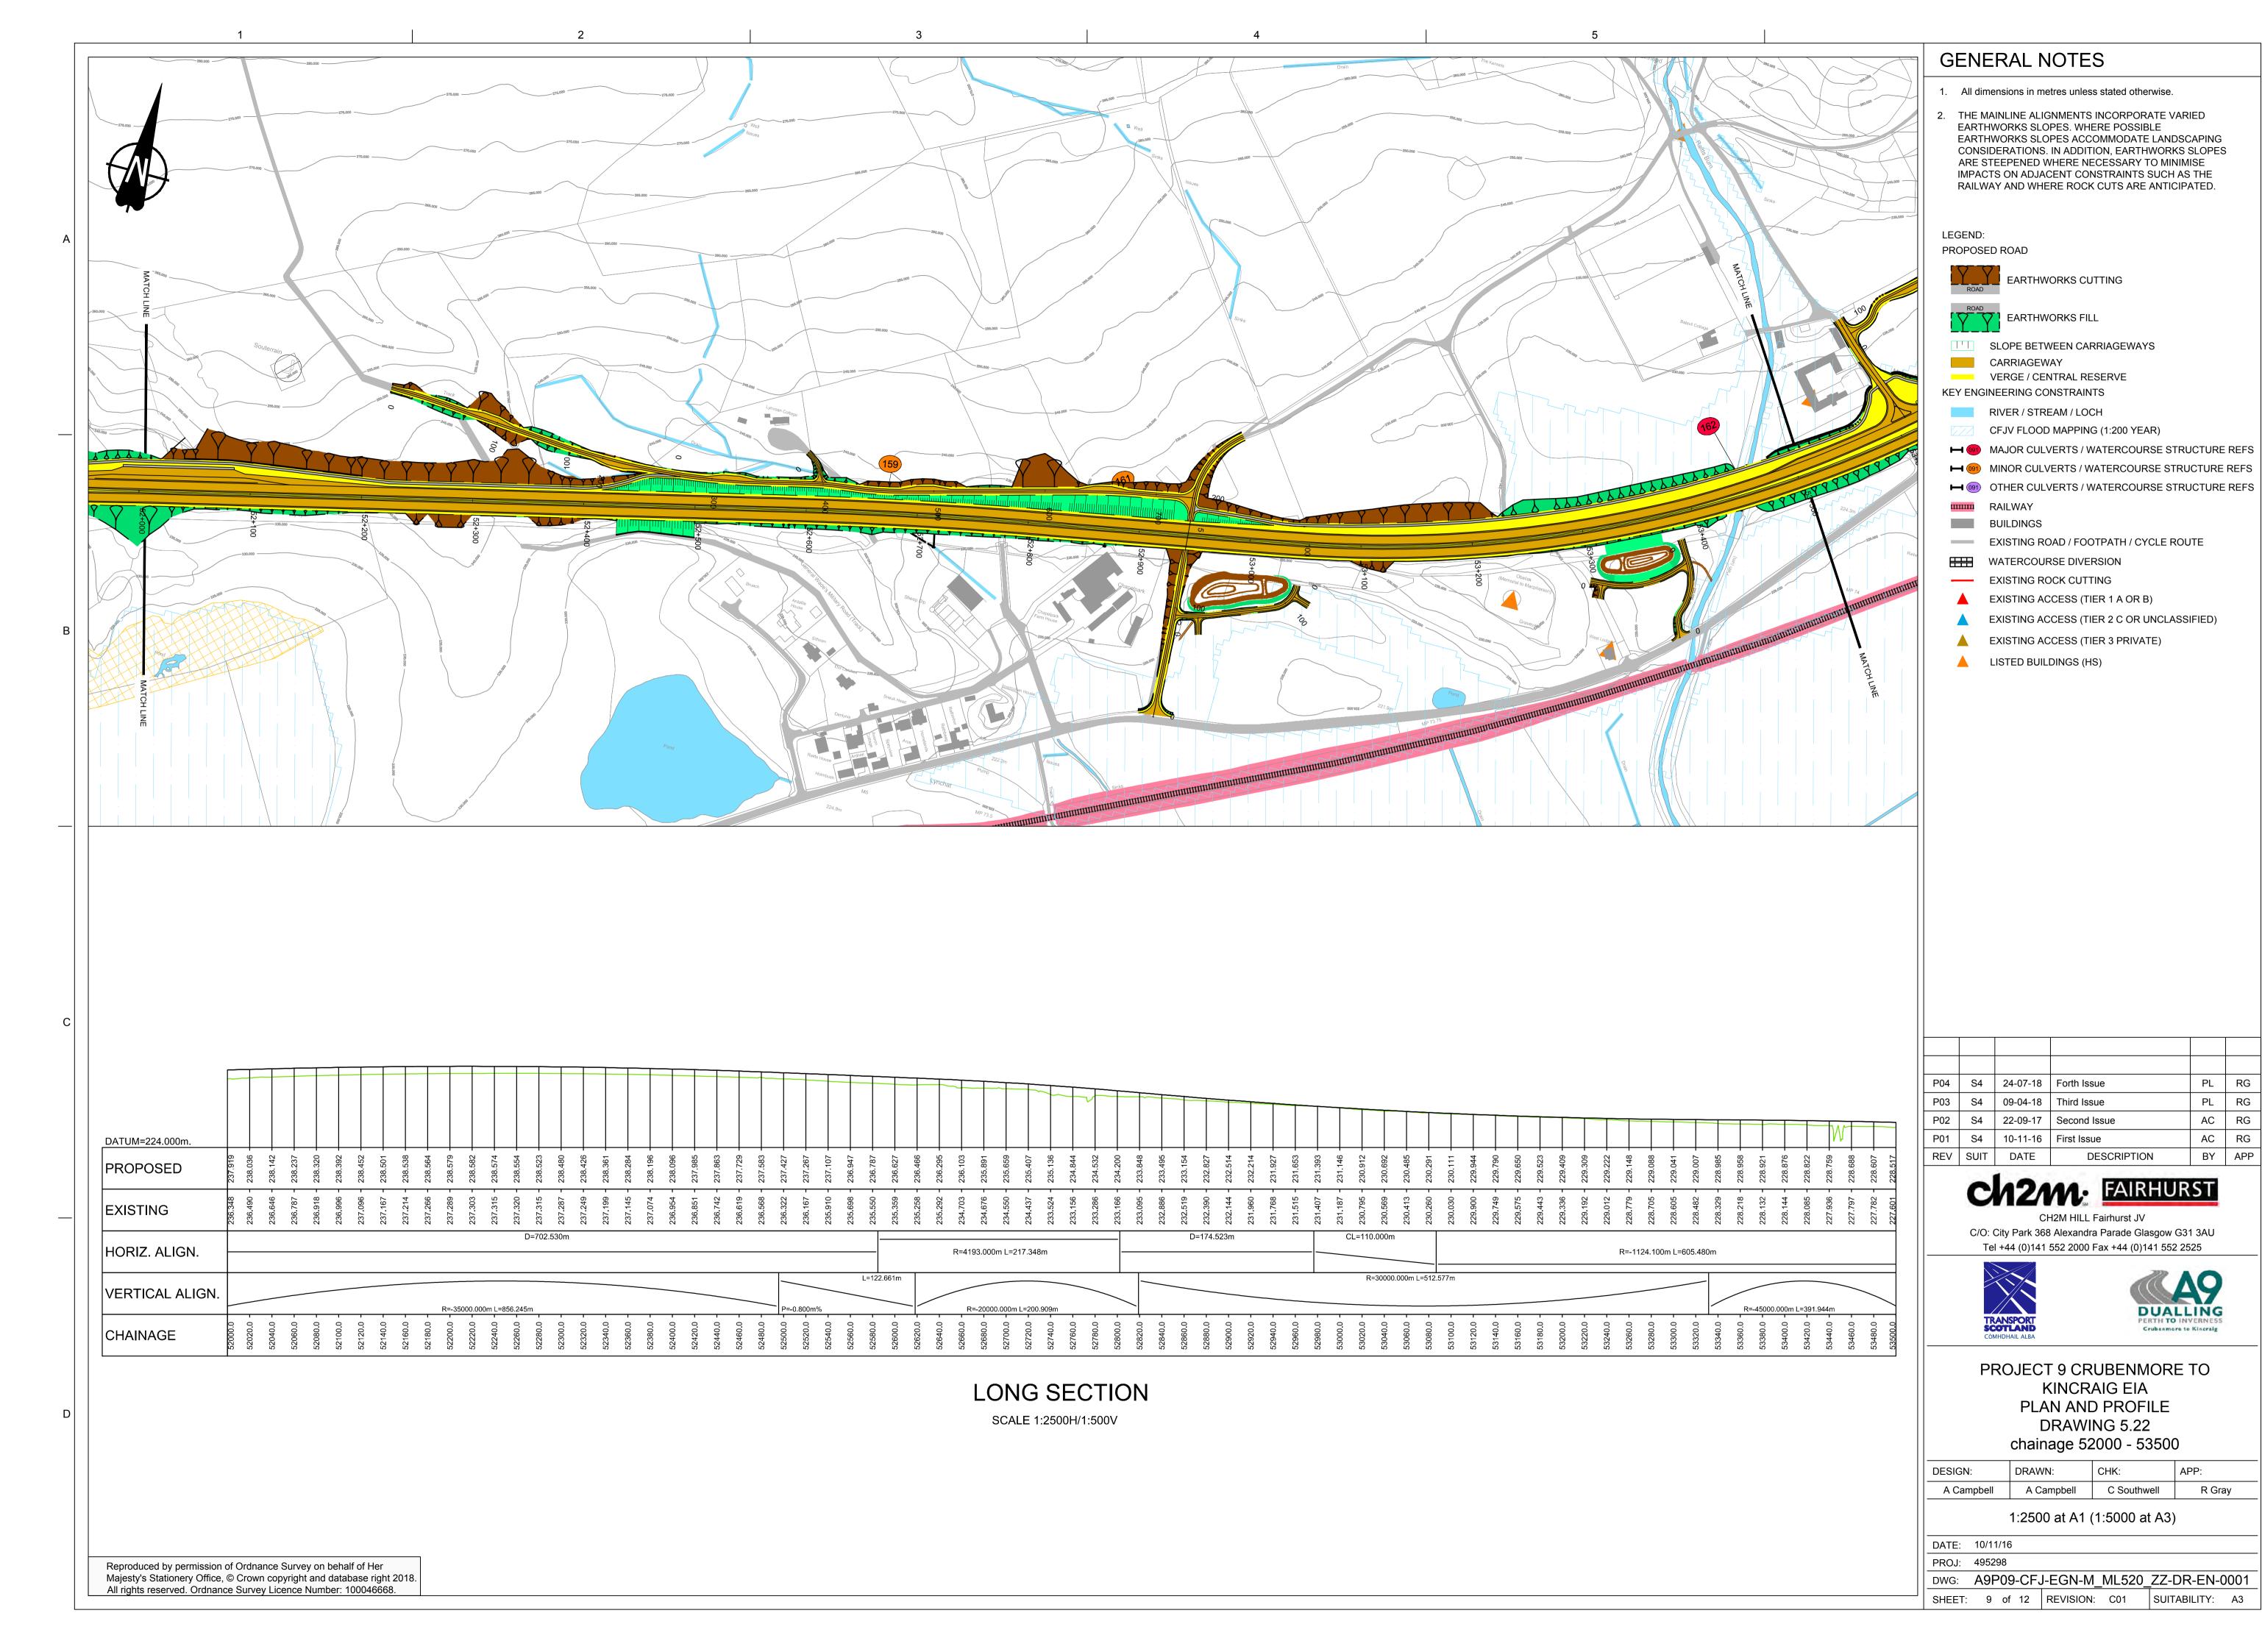

A9P09-CFJ-HML-M\_ML400\_ML-DR-RD-0009.dwg

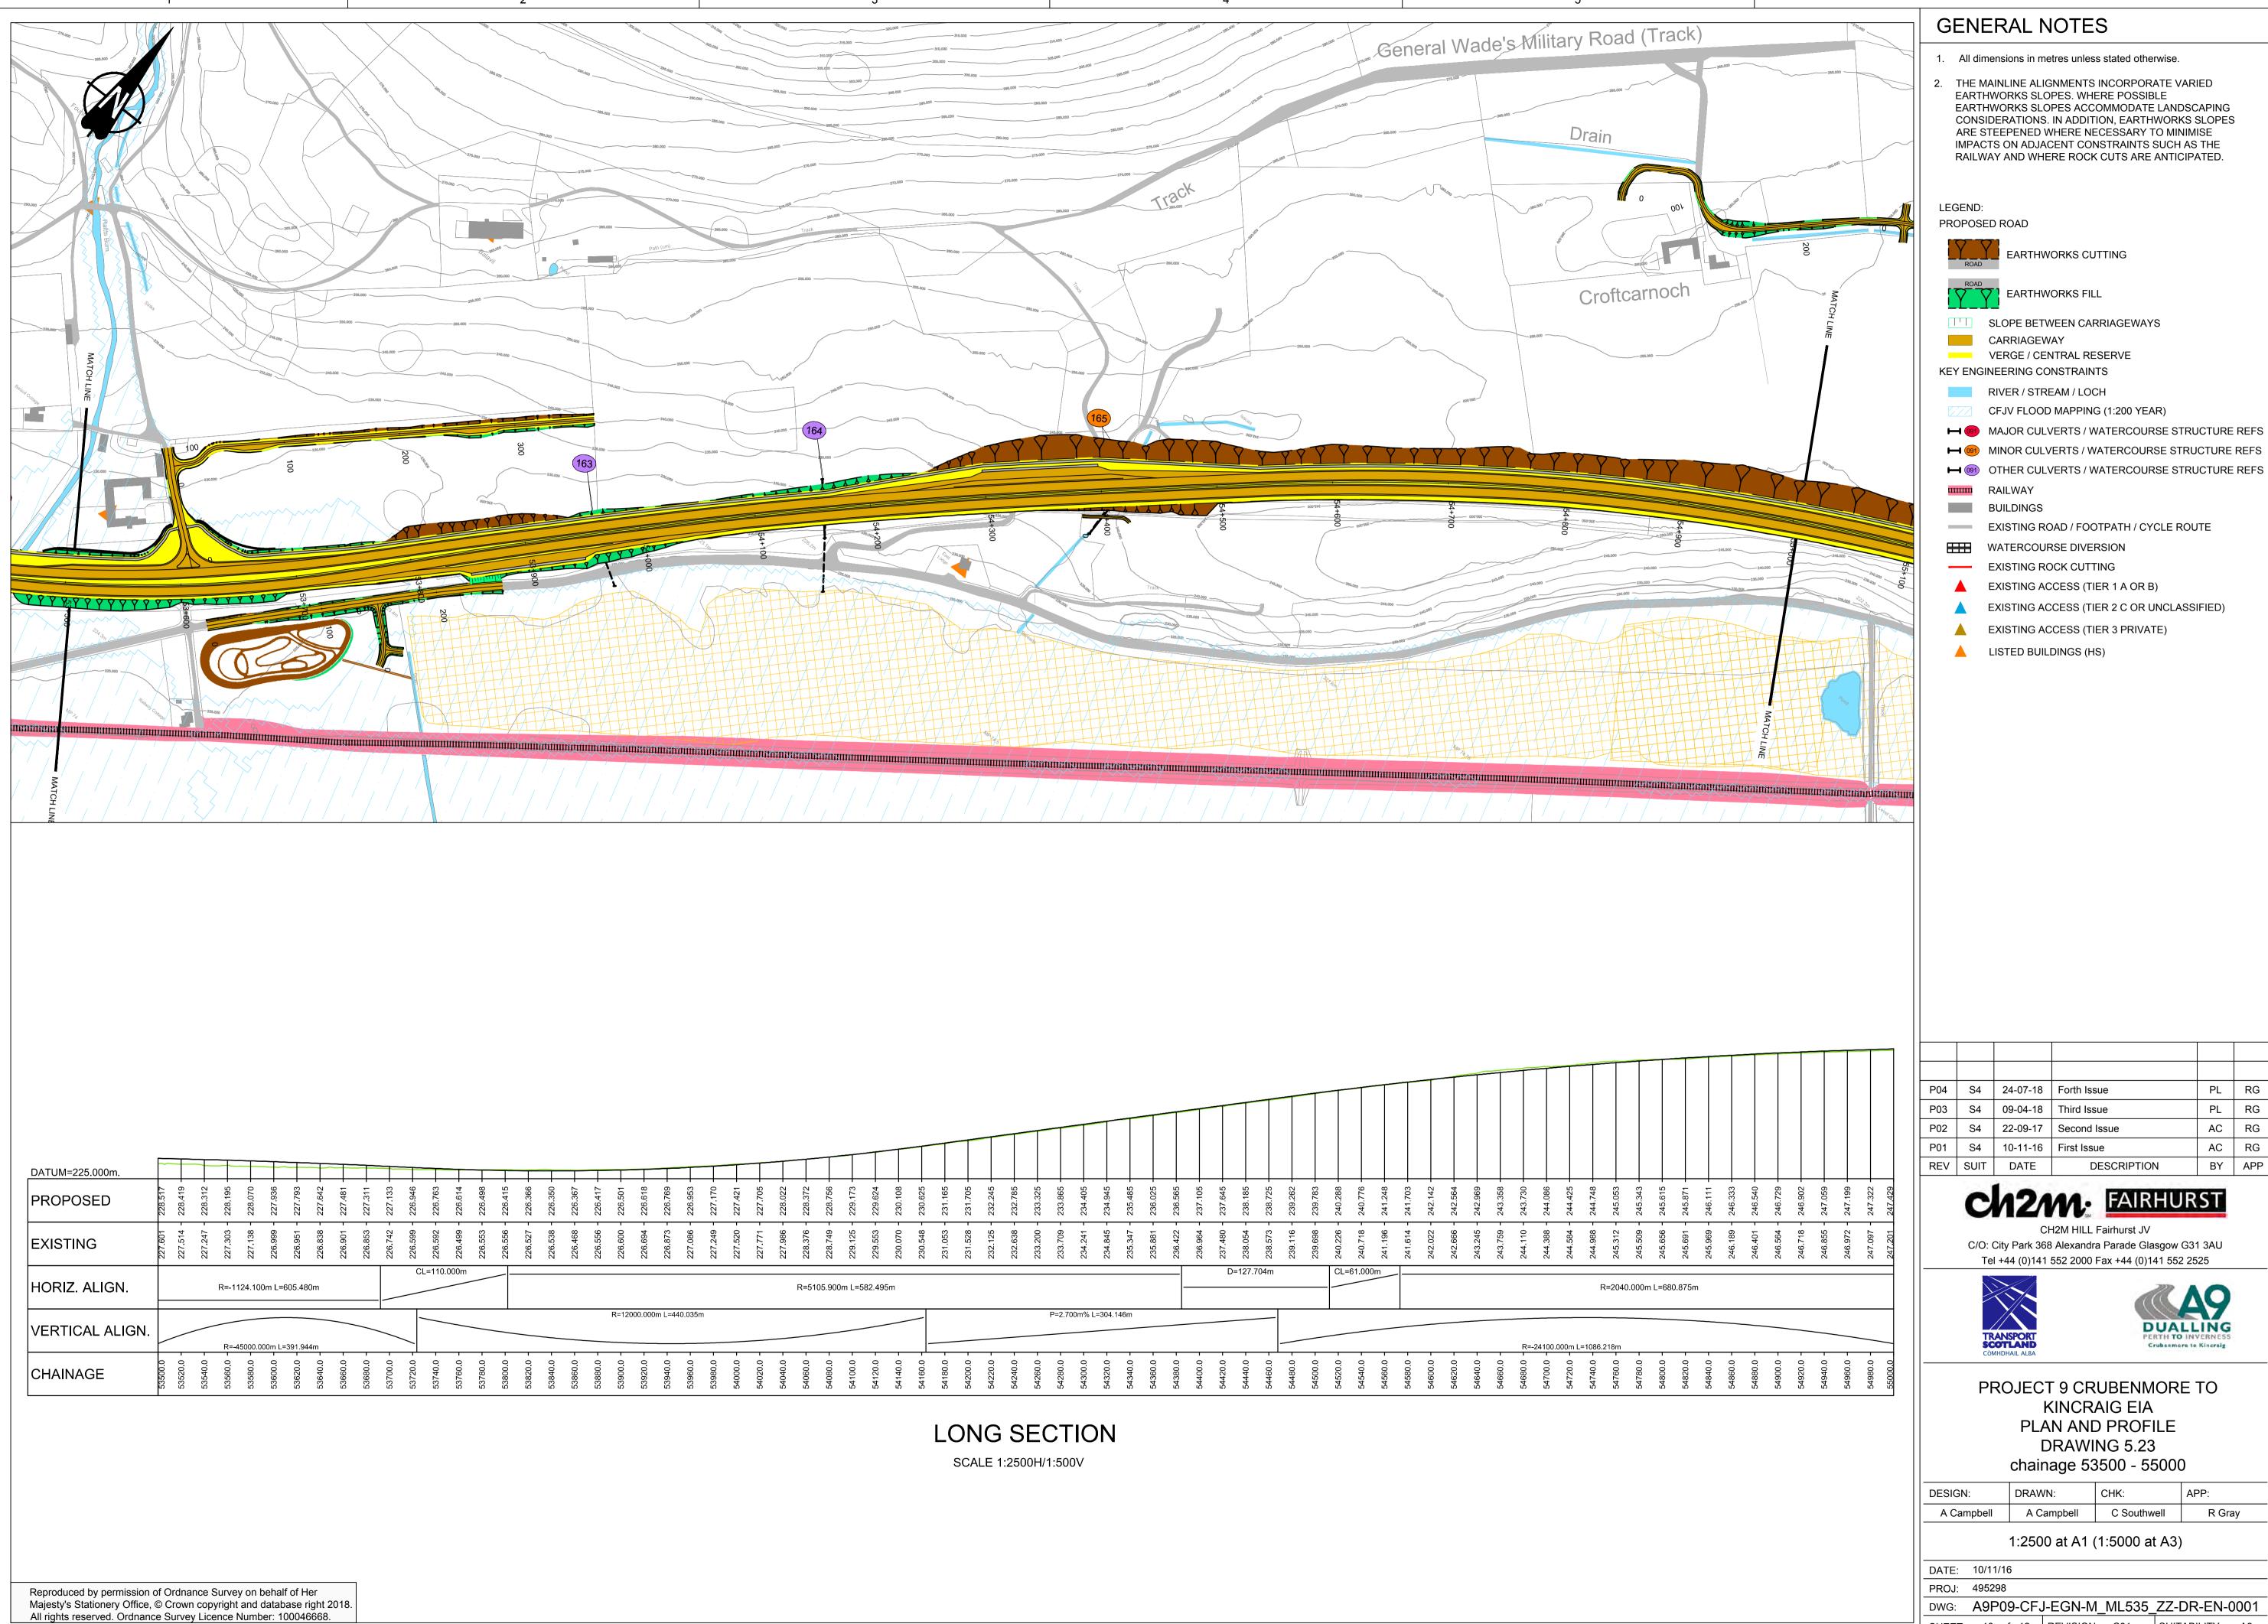

2. THE MAINLINE ALIGNMENTS INCORPORATE VARIED EARTHWORKS SLOPES ACCOMMODATE LANDSCAPING CONSIDERATIONS. IN ADDITION, EARTHWORKS SLOPES

OTHER CULVERTS / WATERCOURSE STRUCTURE REFS


PL RG PL RG AC RG AC RG BY APP



DESIGN:	DRAWN:	CHK:	APP:
A Campbell	A Campbell	C Southwell	R Gray
A Campbell	A Campbell	C Southwell	R Gray

DWG: A9P09-CFJ-EGN-M\_ML535\_ZZ-DR-EN-0001 SHEET: 10 of 12 REVISION: C01 SUITABILITY: A3



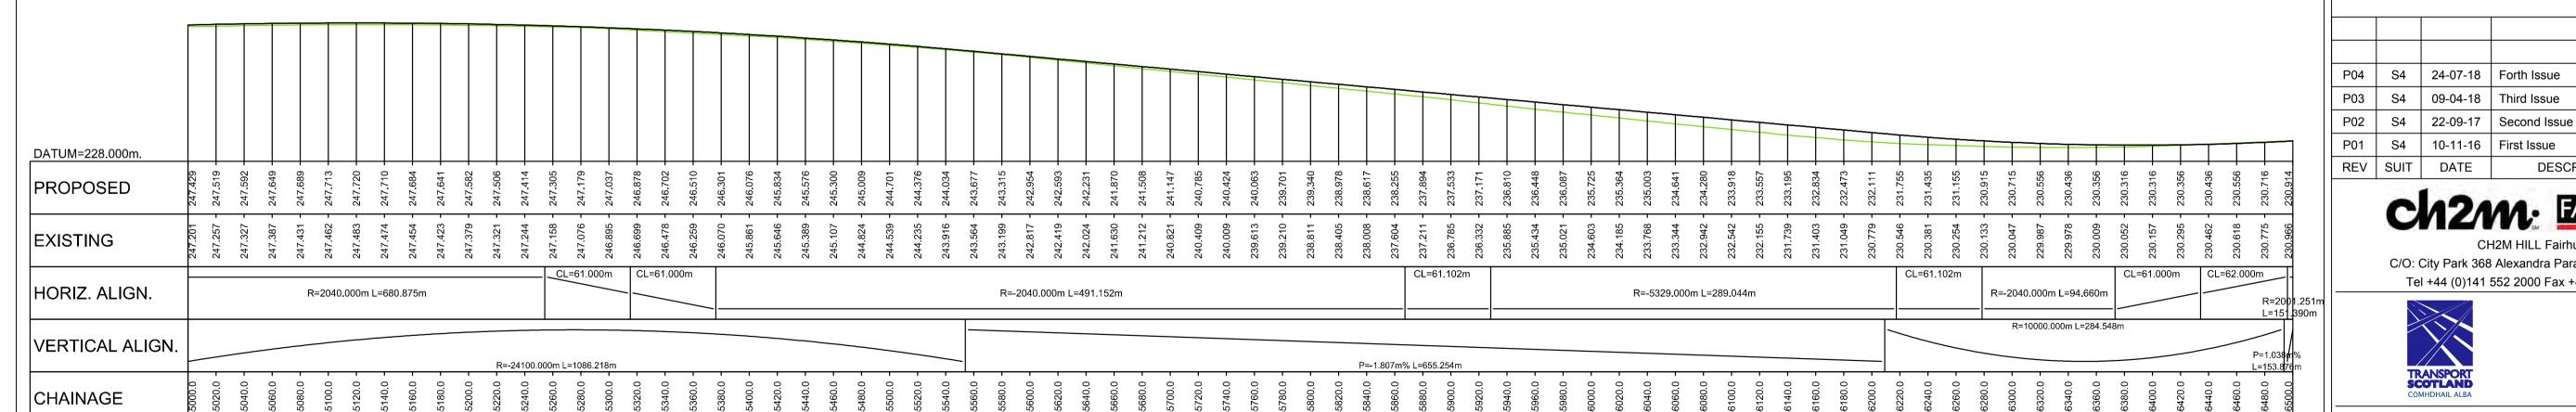

# LONG SECTION

SCALE 1:2500H/1:500V

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TRANSPORT SCOTLAND CÒMHDHAIL ALBA	DUALLING PERTH TO INVERNESS Crubenmore to Kincraig
PROJECT 9 CRU KINCRA	

DESCRIPTION

C/12/11: FAIRHURST

CH2M HILL Fairhurst JV C/O: City Park 368 Alexandra Parade Glasgow G31 3AU

Tel +44 (0)141 552 2000 Fax +44 (0)141 552 2525

PLAN AND PROFILE DRAWING 5.24 chainage 55000 - 56500

ESIGN:	DRAWN:	CHK:	APP:
A Campbell	A Campbell	C Southwell	R Gray

1:2500 at A1 (1:5000 at A3)

DATE: 10/11/16

DATE

DWG: A9P09-CFJ-EGN-M\_ML550\_ZZ-DR-EN-0004 SHEET: 11 of 12 REVISION: C01 SUITABILITY: A3

PL RG

PL RG

AC RG

AC RG

BY APP



7	GEN	IERAL	NOTE	= ,
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1. All dimensions in metres unless stated otherwise.

2. THE MAINLINE ALIGNMENTS INCORPORATE VARIED EARTHWORKS SLOPES. WHERE POSSIBLE EARTHWORKS SLOPES ACCOMMODATE LANDSCAPING CONSIDERATIONS. IN ADDITION, EARTHWORKS SLOPES ARE STEEPENED WHERE NECESSARY TO MINIMISE IMPACTS ON ADJACENT CONSTRAINTS SUCH AS THE RAILWAY AND WHERE ROCK CUTS ARE ANTICIPATED.

EARTHWORKS CUTTING

VERGE / CENTRAL RESERVE

CFJV FLOOD MAPPING (1:200 YEAR)

MAJOR CULVERTS / WATERCOURSE STRUCTURE REFS

OTHER CULVERTS / WATERCOURSE STRUCTURE REFS

**EXISTING ACCESS (TIER 2 C OR UNCLASSIFIED)** 

**EXISTING ACCESS (TIER 3 PRIVATE)** 

LISTED BUILDINGS (HS)

P04	S4	24-07-18	Forth Issue	PL	RG
P03	S4	09-04-18	Third Issue	PL	RG
P02	S4	22-09-17	Second Issue	AC	RG
P01	S4	10-11-16	First Issue	AC	RG
REV	SUIT	DATE	DESCRIPTION	BY	APP

CH2M HILL Fairhurst JV

C/O: City Park 368 Alexandra Parade Glasgow G31 3AU Tel +44 (0)141 552 2000 Fax +44 (0)141 552 2525





PROJECT 9 CRUBENMORE TO KINCRAIG EIA PLAN AND PROFILE **DRAWING 5.25** chainage 56500 - 56645

DESIGN:	DRAWN:	CHK:	APP:
A Campbell	A Campbell	C Southwell	R Gray

1:2500 at A1 (1:5000 at A3)

DATE: 10/11/16

PROJ: 495298

DWG: A9P09-CFJ-EGN-M\_ML565\_ZZ-DR-EN-0001 SHEET: 12 of 12 REVISION: C01 SUITABILITY: A3

LONG SECTION SCALE 1:2500H/1:500V

R=2001.251m L=151.390m

P=1.038m% L=153.876m

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DATUM=229.000m.

PROPOSED

EXISTING

CHAINAGE

HORIZ. ALIGN.

VERTICAL ALIGN.