


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CN03_001-LONGSECTION
SCALE: H 1:10000, V 1:2000

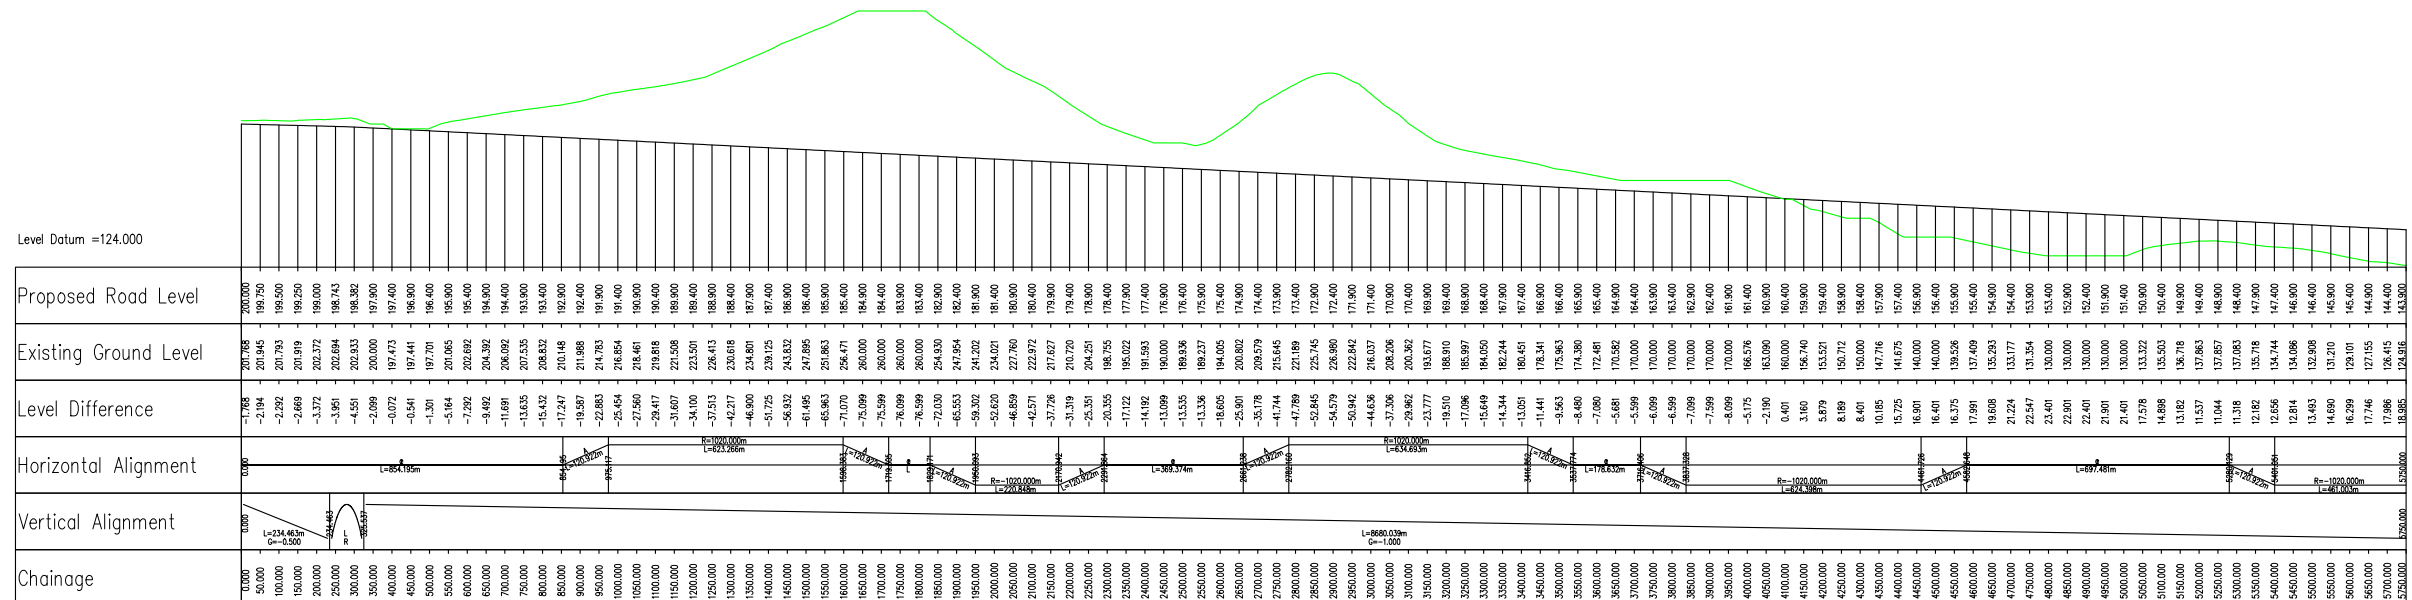

P01	Fit For Information - First Fix Alignments				
	TD	SC	CL	CB	GMacD
	02/03/18	02/03/18	02/03/18	02/03/18	02/03/18

Designer
Precision House
McNeil Drive
Motherwell
ML1 4UR



Client
58 Port Dundas Road
Glasgow
G4 0HF




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A96 Dualling East of Huntly to Aberdeen

Drawing Title
CN03_001 First Fix Alignment
Plan and Profile
Sheet 1 of 3

Project Ref. No. 250002-92	Stage 2	Scale: 1:10000H 1:2000V @ A1 Dimensions: M
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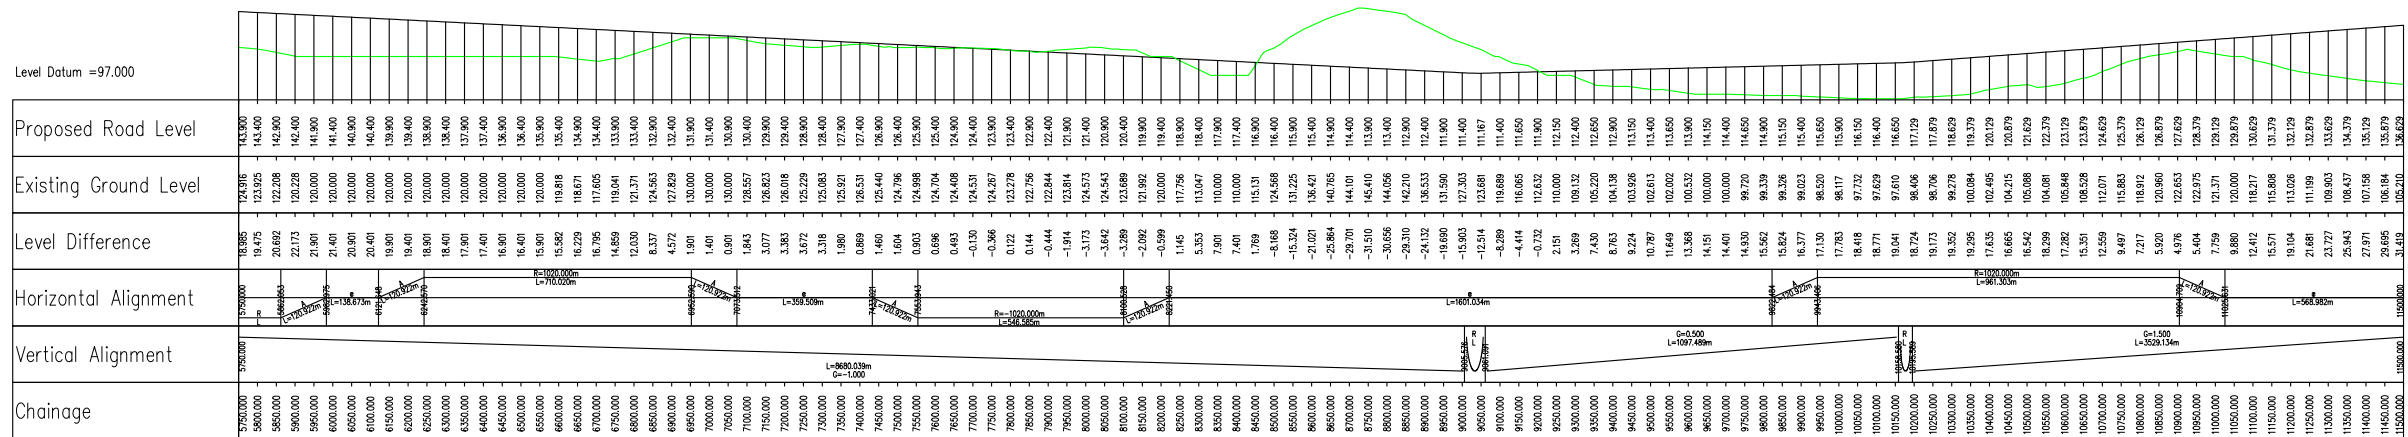
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Project | Originator | Volume |
A96PEA - AMAR - HGN -
CC - DR-CH- 003101
Location | Type | Role | Number

Suitability S2	Suitability Description Fit For Information	Revision P01
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CN03_001-LONGSECTION
 SCALE: H 1:10000, V 1:2000

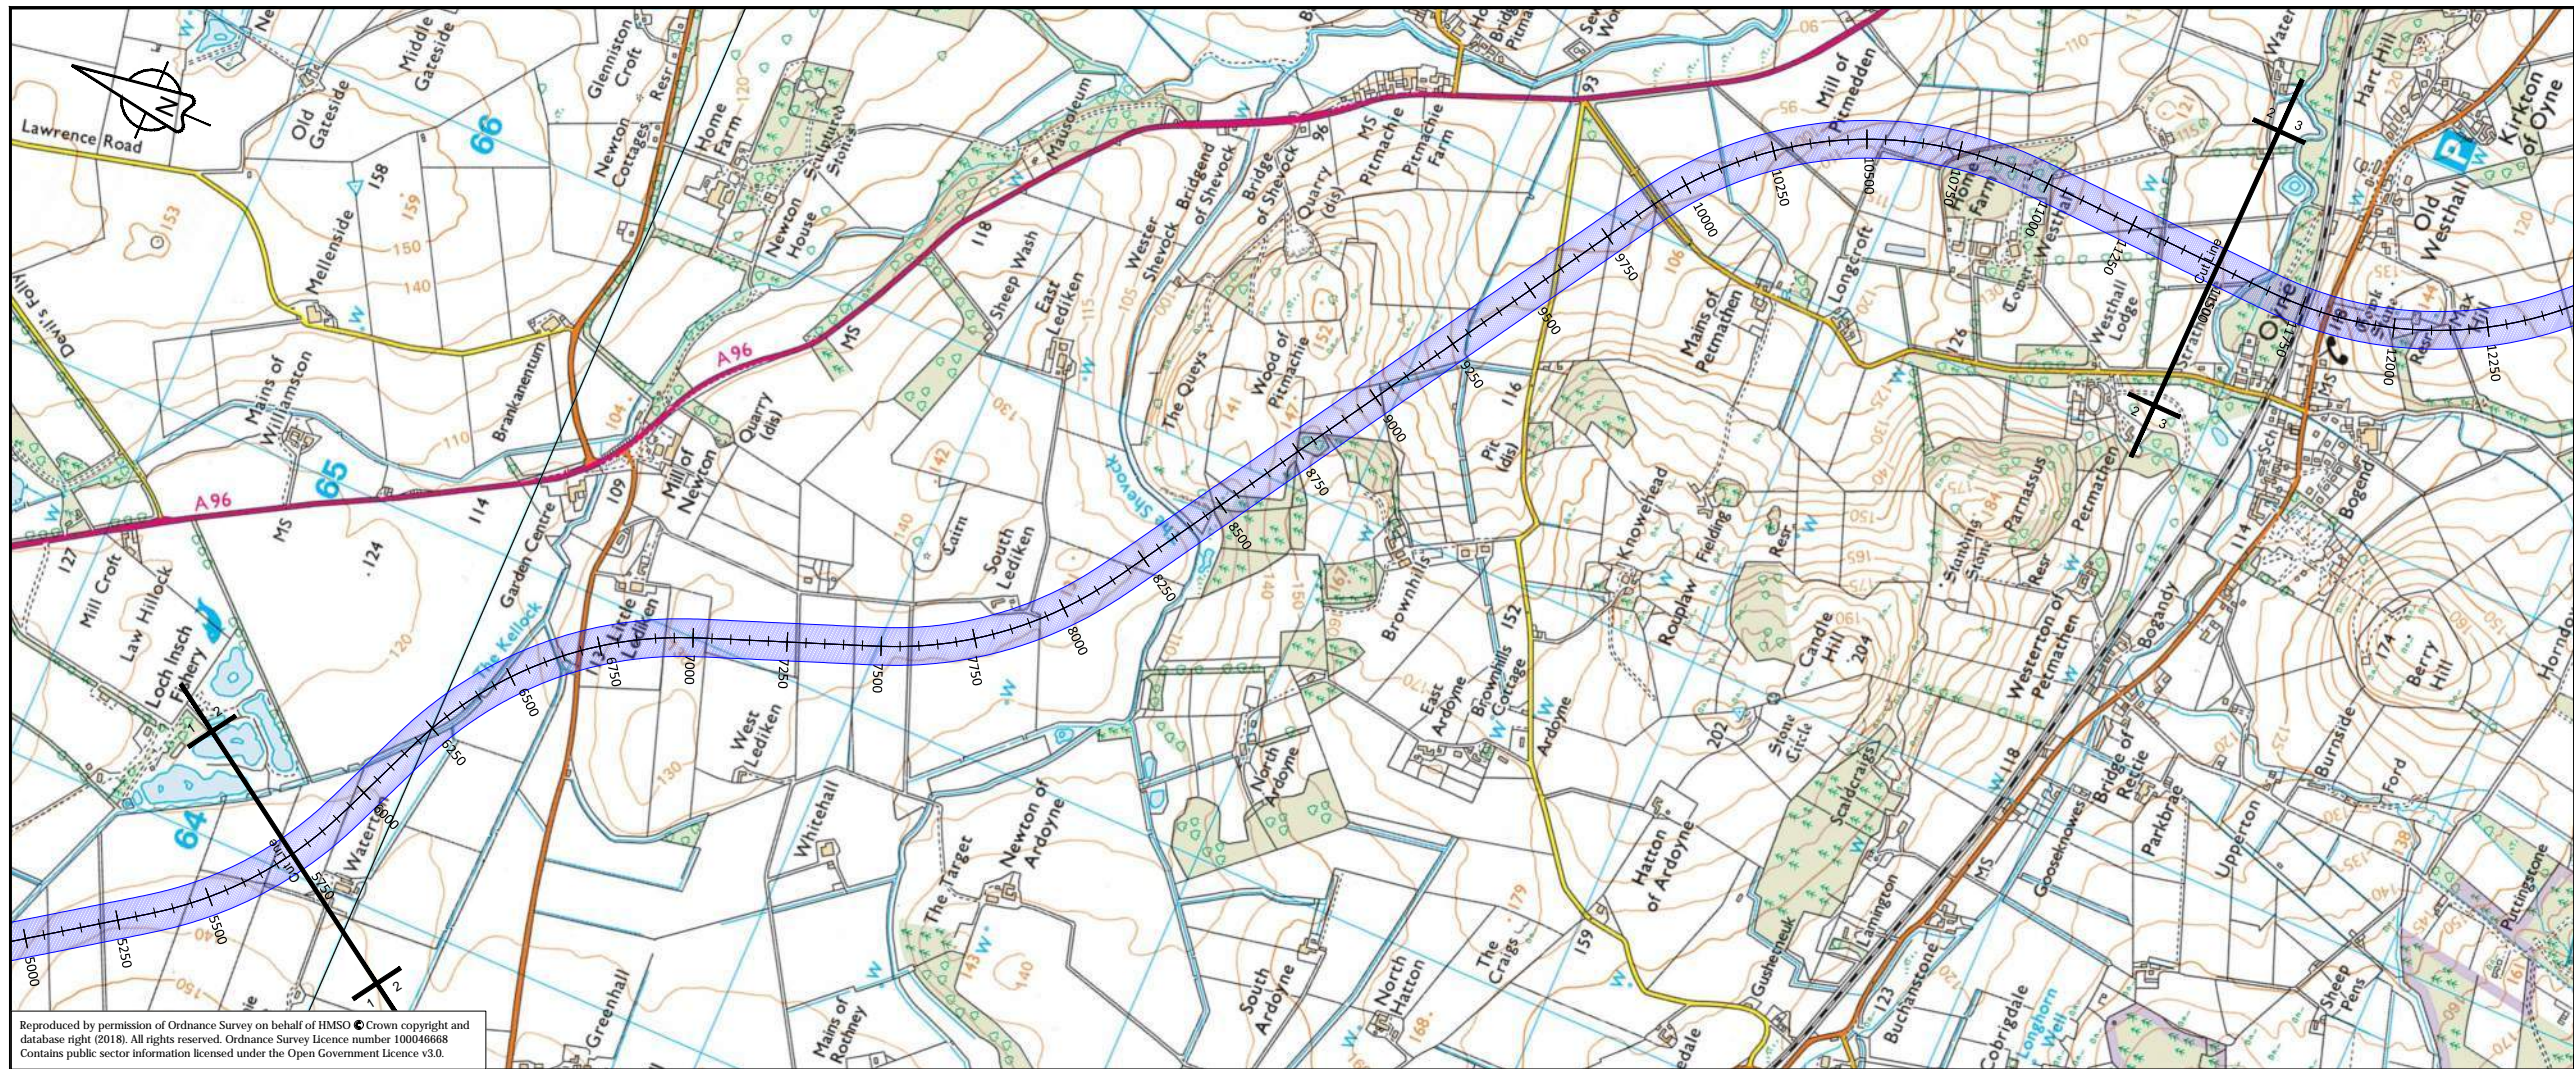

P01	Fit For Information - First Fix Alignments				
	TD	SC	CL	CB	GMacD
	02/03/18	02/03/18	02/03/18	02/03/18	02/03/18
Revision	Revision details				
	Created	Checked	Reviewed	Approved	Authorised
	dd/mm/yy	dd/mm/yy	dd/mm/yy	dd/mm/yy	dd/mm/yy

Designer
 Precision House
 McNeil Drive
 Motherwell
 ML1 4UR



Client
 58 Port Dundas Road
 Glasgow
 G4 0HF




Project Name
A96 Dualling East of Huntly to Aberdeen

Drawing Title
**CN03_001 First Fix Alignment
 Plan and Profile
 Sheet 2 of 3**

Project Ref. No.	Stage	Scale: 1:10000H 1:2000V @ A1
250002-92	2	Dimensions: M

Drawing Number	Project	Originator	Volume
CC	A96PEA	- AMAR - HGN -	
Location	Role	Number	


Suitability	Suitability Description	Revision
S2	Fit For Information	P01

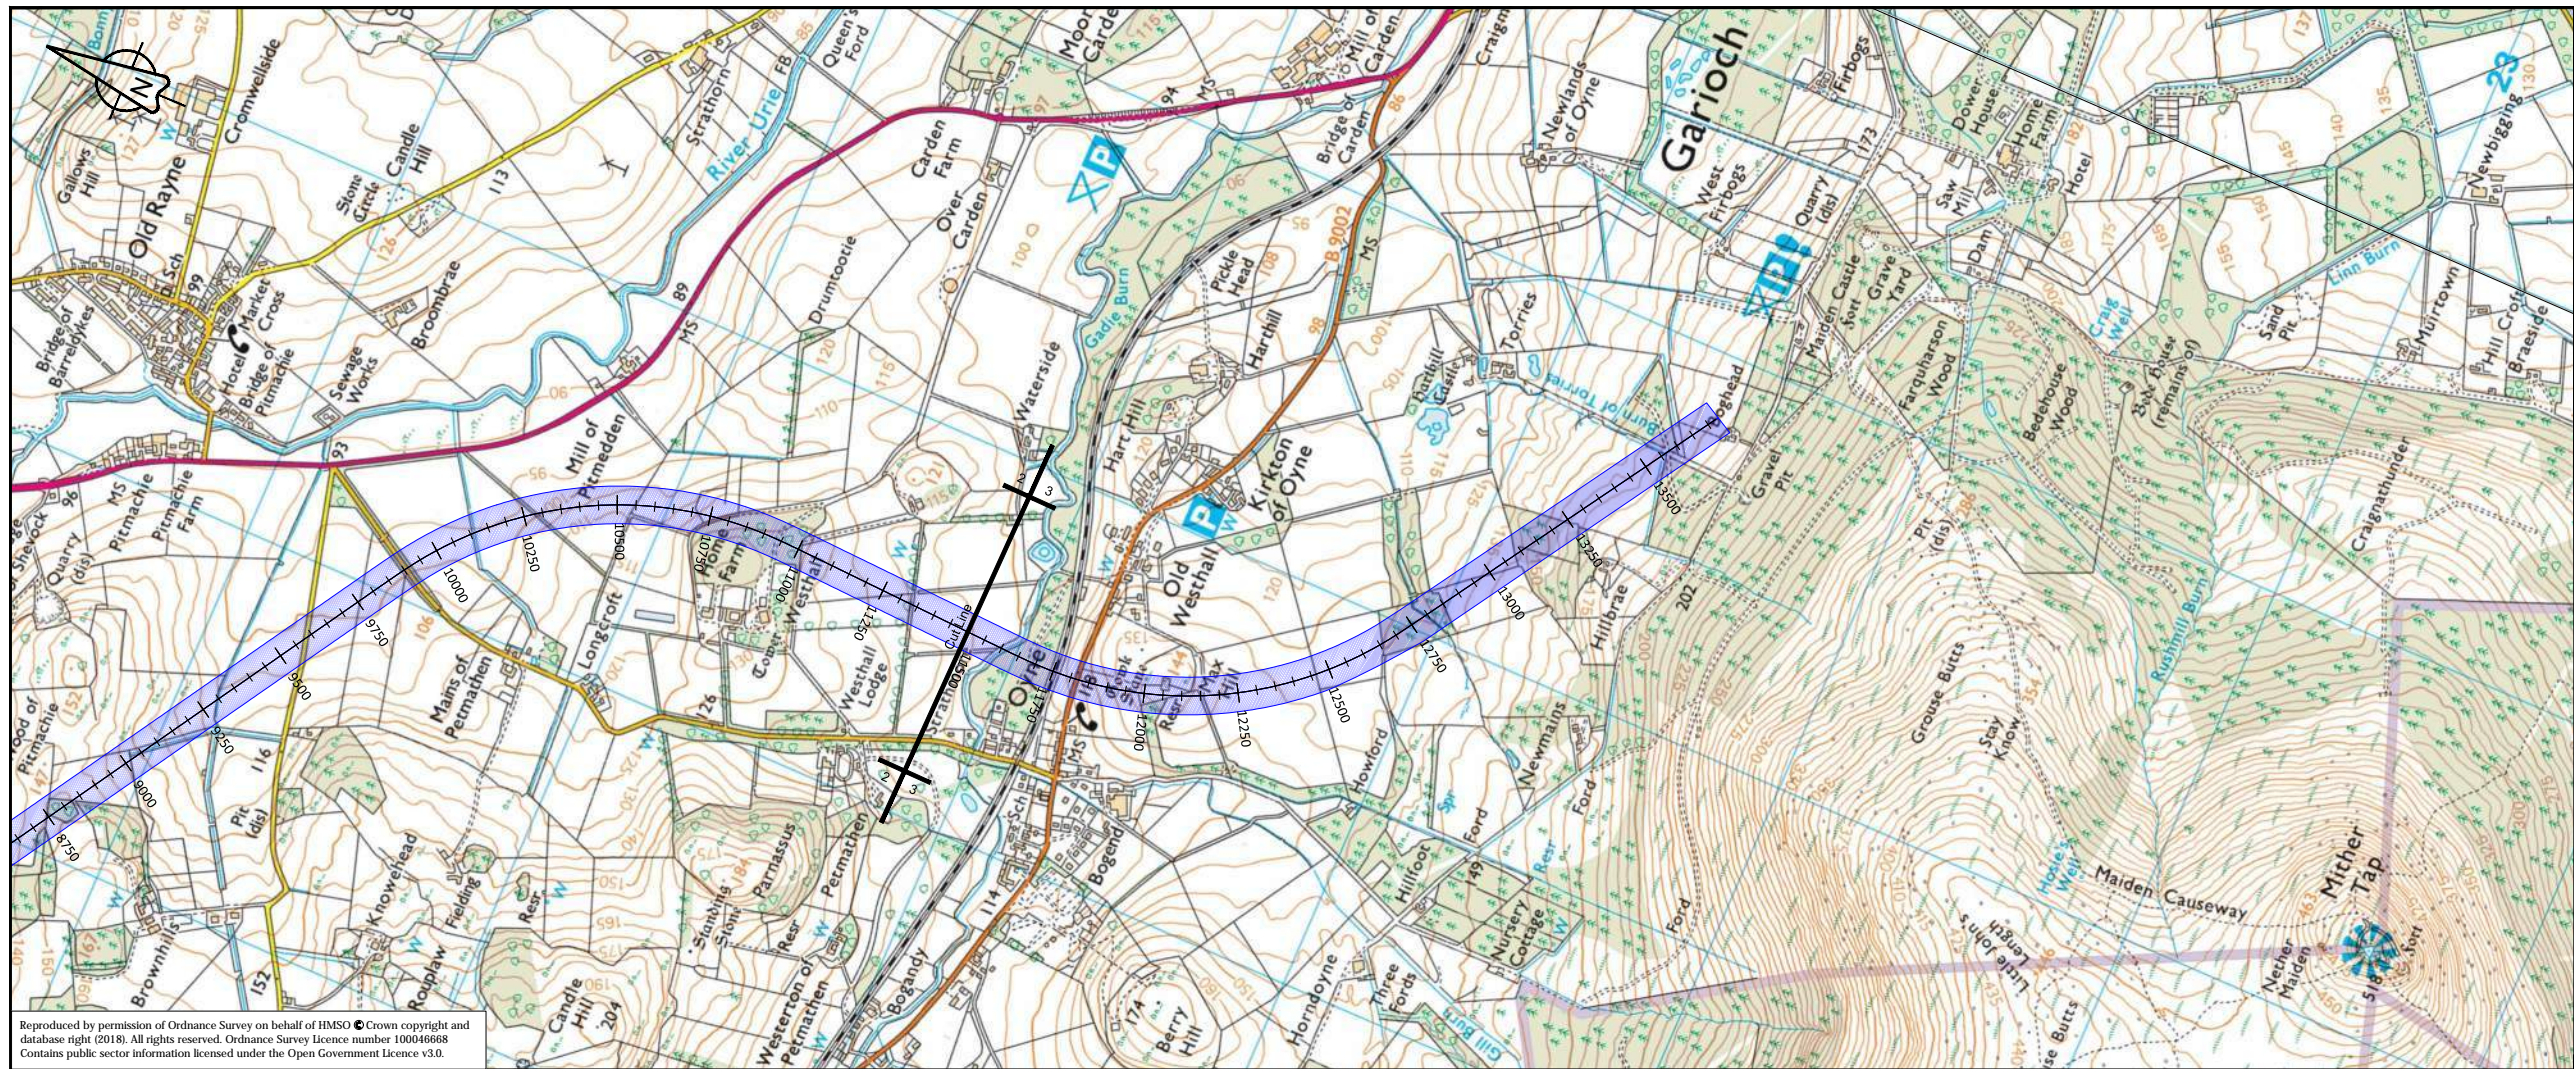

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CN03_001- LONGSECTION
 SCALE: H 1:10000, V 1:2000

Level Datum =102.000

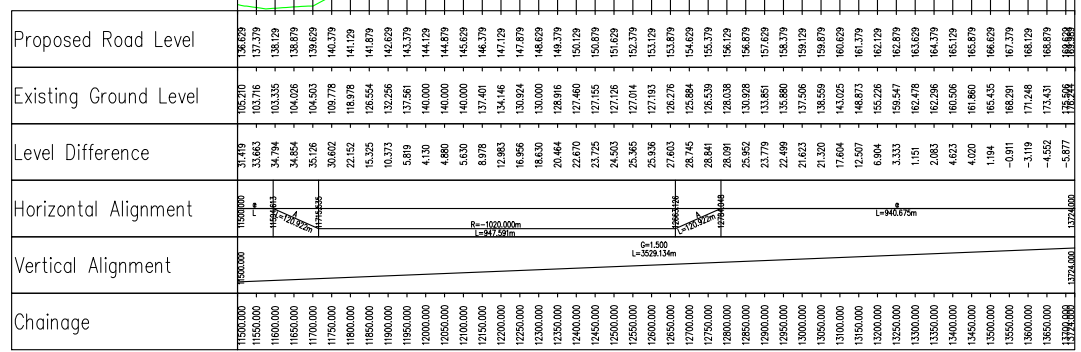

P01	Fit For Information - First Fix Alignments				
	TD	SC	CL	CB	GMacD
	02/03/18	02/03/18	02/03/18	02/03/18	02/03/18
Revision	Revision details				
	Created	Checked	Reviewed	Approved	Authorised
	dd/mm/yy	dd/mm/yy	dd/mm/yy	dd/mm/yy	dd/mm/yy

Designer
 Precision House
 McNeil Drive
 Motherwell
 ML1 4UR



Client
 58 Port Dundas Road
 Glasgow
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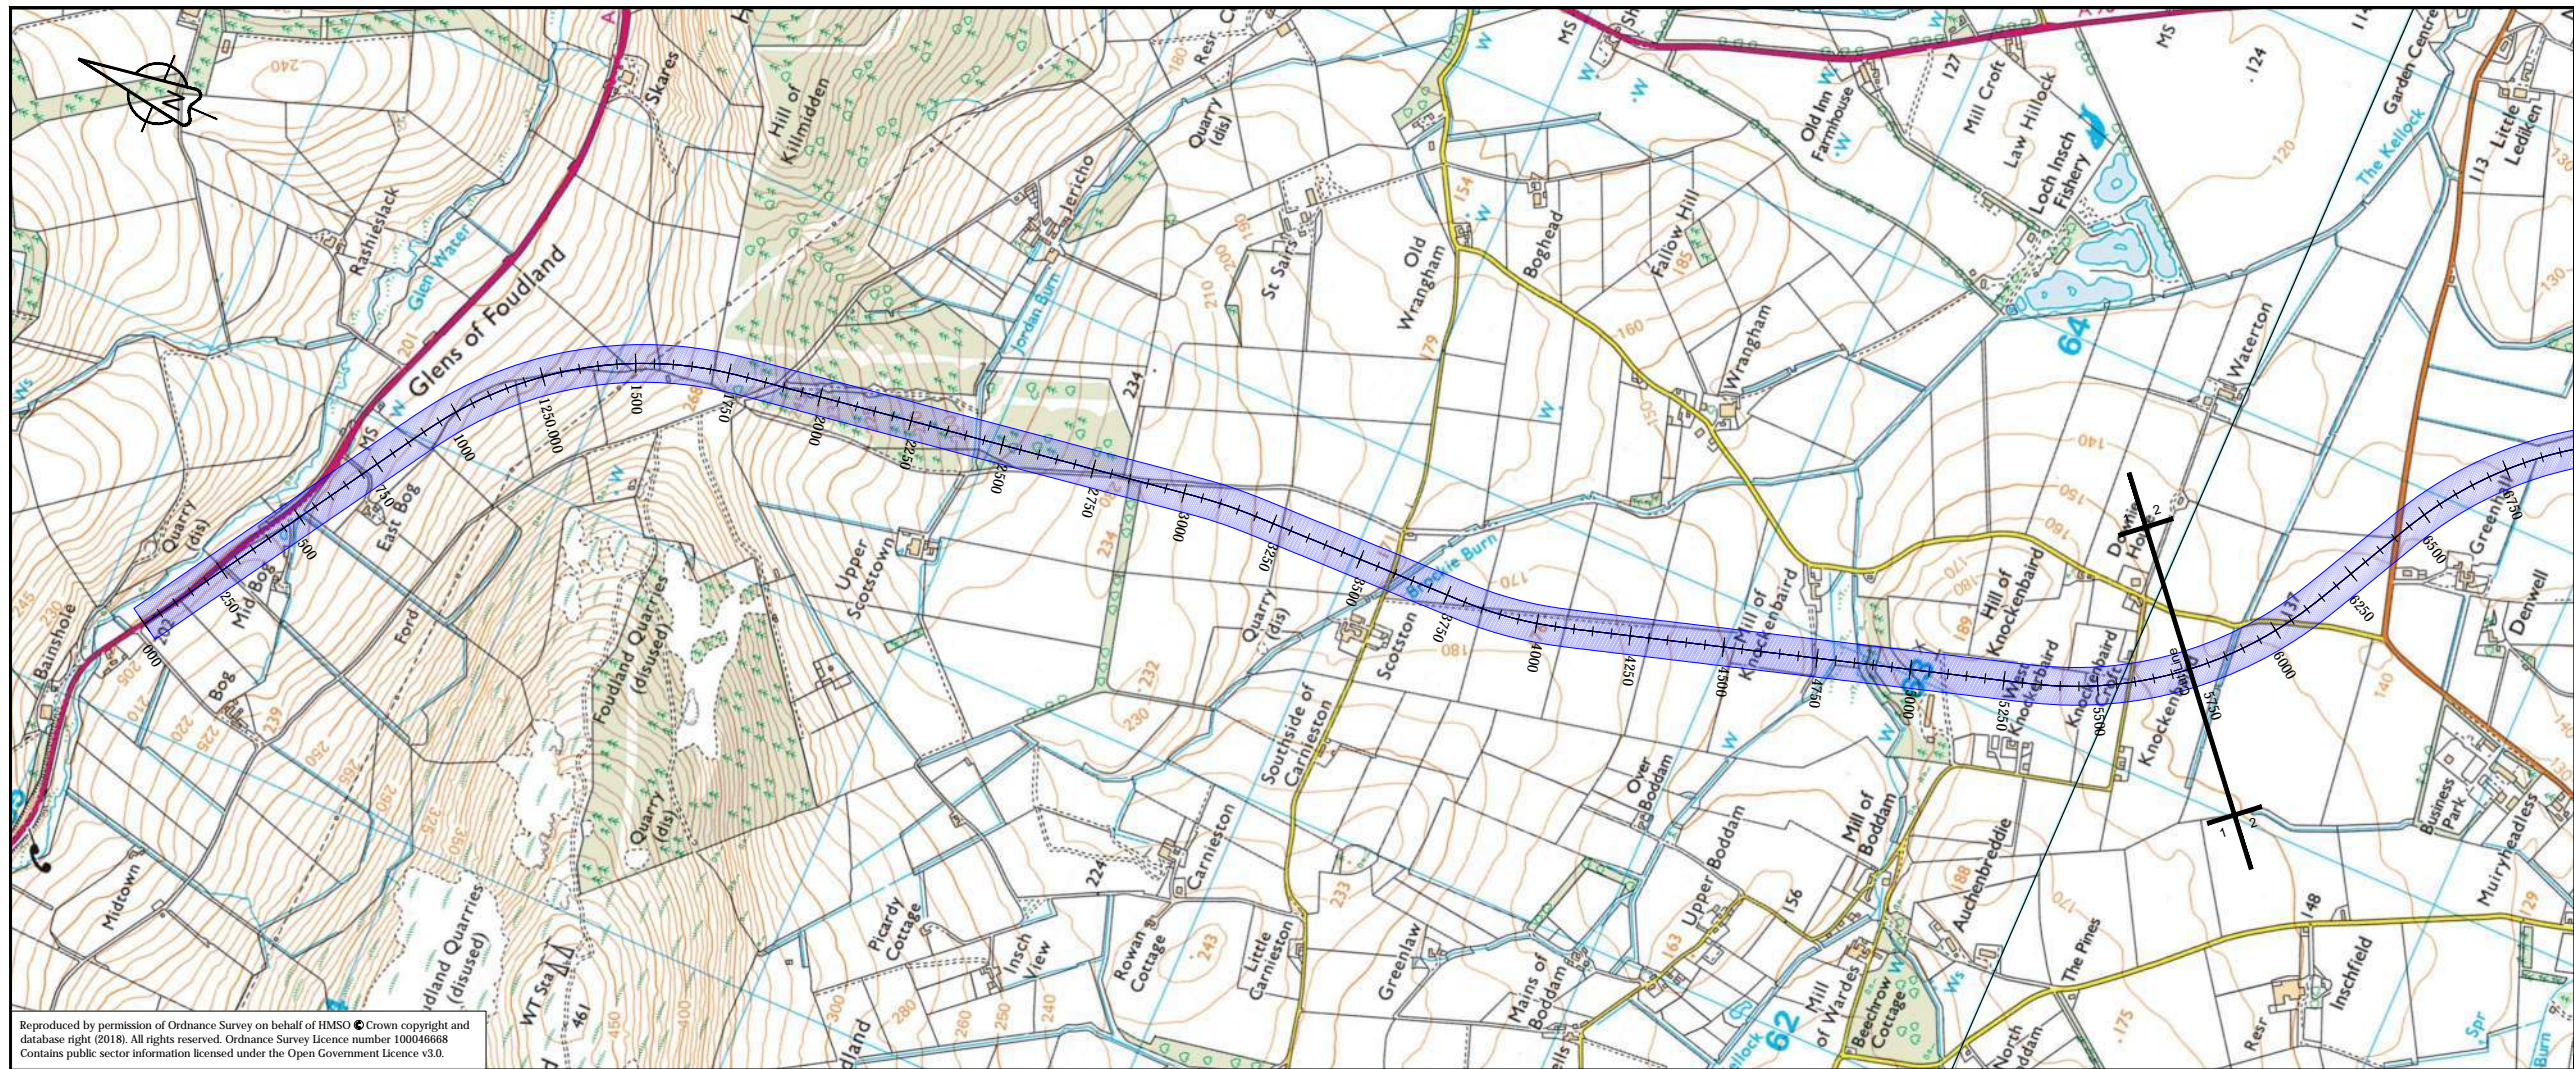
Project Name
A96 Dualling East of Huntly to Aberdeen

Drawing Title
CN03_001 First Fix Alignment Plan and Profile Sheet 3 of 3


Project Ref. No. 250002-92	Stage 2	Scale : 1:10000H 1:2000V @ A1 Dimensions : M
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Drawing Number	Project	Originator	Volume
A96PEA - AMAR - HGN - CC			
	Location	Type	Role
			Number

Suitability	Suitability Description	Revision
S2	Fit For Information	P01



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Chainage	Proposed Road Level	Existing Ground Level	Level Difference
0+000	200.000	207.785	-7.785
50.000	200.500	201.845	-1.444
100.000	201.000	201.793	-0.792
150.000	201.500	201.819	-0.419
200.000	202.000	202.372	-0.372
250.000	202.500	202.694	-0.194
300.000	203.000	202.933	0.067
350.000	203.500	203.000	0.500
400.000	204.000	197.441	6.559
450.000	204.500	197.701	7.799
500.000	205.000	201.065	4.435
550.000	205.500	202.692	3.308
600.000	206.000	204.392	2.108
650.000	206.500	206.932	0.969
700.000	207.000	207.535	-0.035
750.000	207.500	208.832	-1.332
800.000	208.000	210.146	-2.146
850.000	208.500	211.999	-3.499
900.000	209.000	214.622	-5.622
950.000	209.500	218.794	-9.294
1000.000	210.000	218.589	-8.589
1050.000	210.500	218.990	-8.490
1100.000	211.000	221.720	-10.720
1150.000	211.500	223.756	-12.256
1200.000	212.000	226.769	-14.769
1250.000	212.500	230.966	-18.466
1300.000	213.000	235.219	-22.219
1350.000	213.500	239.583	-26.083
1400.000	214.000	244.143	-30.143
1450.000	214.500	248.441	-33.941
1500.000	215.000	252.300	-37.300
1550.000	215.500	256.757	-41.257
1600.000	216.000	260.000	-44.000
1650.000	216.500	263.834	-47.334
1700.000	217.000	267.000	-50.000
1750.000	217.500	269.793	-52.293
1800.000	218.000	272.000	-54.000
1850.000	218.500	273.532	-55.032
1900.000	219.000	274.684	-55.684
1950.000	219.500	274.700	-55.200
2000.000	220.000	273.700	-53.700
2050.000	220.500	271.700	-51.200
2100.000	221.000	268.700	-47.700
2150.000	221.500	264.700	-42.700
2200.000	222.000	260.000	-36.000
2250.000	222.500	254.700	-28.700
2300.000	223.000	249.000	-21.000
2350.000	223.500	242.800	-12.800
2400.000	224.000	236.200	-3.800
2450.000	224.500	229.200	5.300
2500.000	225.000	221.800	13.200
2550.000	225.500	214.000	21.500
2600.000	226.000	205.800	30.200
2650.000	226.500	197.200	39.300
2700.000	227.000	188.200	48.800
2750.000	227.500	178.700	58.800
2800.000	228.000	168.700	69.300
2850.000	228.500	158.200	79.300
2900.000	229.000	147.200	88.800
2950.000	229.500	135.700	97.800
3000.000	230.000	123.700	106.300
3050.000	230.500	111.200	119.300
3100.000	231.000	98.200	132.800
3150.000	231.500	84.700	146.800
3200.000	232.000	70.700	161.300
3250.000	232.500	56.200	176.300
3300.000	233.000	41.200	191.800
3350.000	233.500	25.700	207.800
3400.000	234.000	10.700	224.300
3450.000	234.500	-4.800	241.300
3500.000	235.000	-20.800	258.800
3550.000	235.500	-37.300	276.800
3600.000	236.000	-54.300	295.300
3650.000	236.500	-71.800	314.300
3700.000	237.000	-89.800	333.800
3750.000	237.500	-108.300	353.800
3800.000	238.000	-127.300	374.300
3850.000	238.500	-146.800	395.300
3900.000	239.000	-166.800	416.800
3950.000	239.500	-187.300	438.800
4000.000	240.000	-208.300	461.300
4050.000	240.500	-229.800	484.300
4100.000	241.000	-251.800	507.800
4150.000	241.500	-274.300	531.800
4200.000	242.000	-297.300	556.300
4250.000	242.500	-320.800	581.300
4300.000	243.000	-344.800	606.800
4350.000	243.500	-369.300	632.800
4400.000	244.000	-394.300	659.300
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4650.000	246.500	-526.800	799.300
4700.000	247.000	-554.800	828.800
4750.000	247.500	-583.300	858.800
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4850.000	248.500	-641.800	920.300
4900.000	249.000	-671.800	951.800
4950.000	249.500	-702.300	983.800
5000.000	250.000	-733.300	1016.300
5050.000	250.500	-764.800	1049.300
5100.000	251.000	-796.800	1082.800
5150.000	251.500	-829.300	1116.800
5200.000	252.000	-862.300	1151.300
5250.000	252.500	-895.800	1186.300
5300.000	253.000	-929.800	1221.800
5350.000	253.500	-964.300	1257.800
5400.000	254.000	-999.300	1294.300
5450.000	254.500	-1034.800	1331.300
5500.000	255.000	-1070.800	1368.800
5550.000	255.500	-1107.300	1406.800
5600.000	256.000	-1144.300	1445.300
5650.000	256.500	-1181.800	1484.300
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5850.000	258.500	-1336.800	1645.300
5900.000	259.000	-1376.800	1686.800
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6000.000	260.000	-1458.300	1771.300
6050.000	260.500	-1499.800	1814.300
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6350.000	263.500	-1759.300	2082.800
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6450.000	264.500	-1849.800	2176.300
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6550.000	265.500	-1942.300	2271.800
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6700.000	267.000	-2084.800	2418.800
6750.000	267.500	-2133.300	2468.800
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6850.000	268.500	-2231.800	2570.300
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7100.000	271.000	-2486.800	2832.800
7150.000	271.500	-2539.300	2886.800
7200.000	272.000	-2592.300	2941.300
7250.000	272.500	-2645.800	2996.300
7300.000	273.000	-2699.800	3051.800
7350.000	273.500	-2754.300	3107.800
7400.000	274.000	-2809.300	3164.300
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7650.000	276.500	-3091.800	3454.300
7700.000	277.000	-3149.800	3513.800
7750.000	277.500	-3208.300	3573.800
7800.000	278.000	-3267.300	3634.300
7850.000	278.500	-3326.800	3695.300
7900.000	279.000	-3386.800	3756.800
7950.000	279.500	-3447.300	3818.800
8000.000	280.000	-3508.300	3881.300
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8150.000	281.500	-3694.300	4071.800
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8350.000	283.500	-3949.300	4332.800
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9400.000	294.000	-5419.300	5834.300
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P01	Fit For Information - First Fix Alignments				
	TD	SC	CL	CB	GMacD
	02/03/18	02/03/18	02/03/18	02/03/18	02/03/18
Revision	Revision details				
	Created	Checked	Reviewed	Approved	Authorised
	dd/mm/yy	dd/mm/yy	dd/mm/yy	dd/mm/yy	dd/mm/yy

Designer
Precision House
McNeil Drive
Motherwell
ML1 4UR

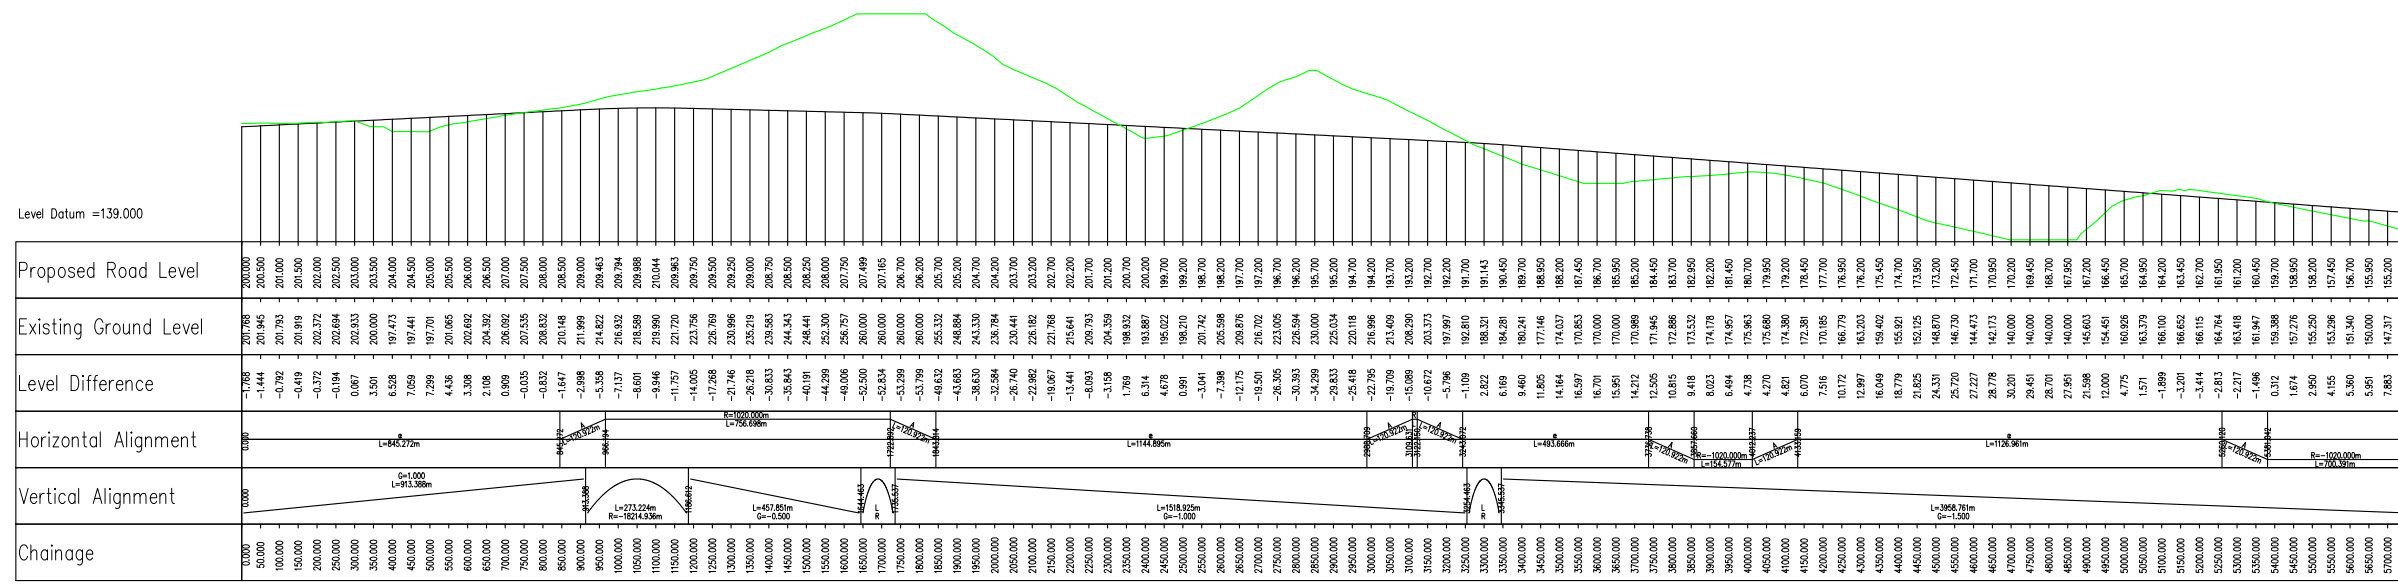Client
58 Port Dundas Road
Glasgow
G4 0HF


Project Name
A96 Dualling East of Huntly to Aberdeen

Drawing Title
CN03_002 First Fix Alignment Plan and Profile Sheet 1 of 3


Project Ref. No.	Stage	Scale
250002-92	2	1:10000H:1:2000V @ A1
Dimensions: M		

Drawing Number
Project | Originator | Volume |
A96PEA - AMAR - HGN -
CC -DR-CH- 003201
Location | Type | Role | Number

Suitability	Suitability Description	Revision
S2	Fit For Information	P01

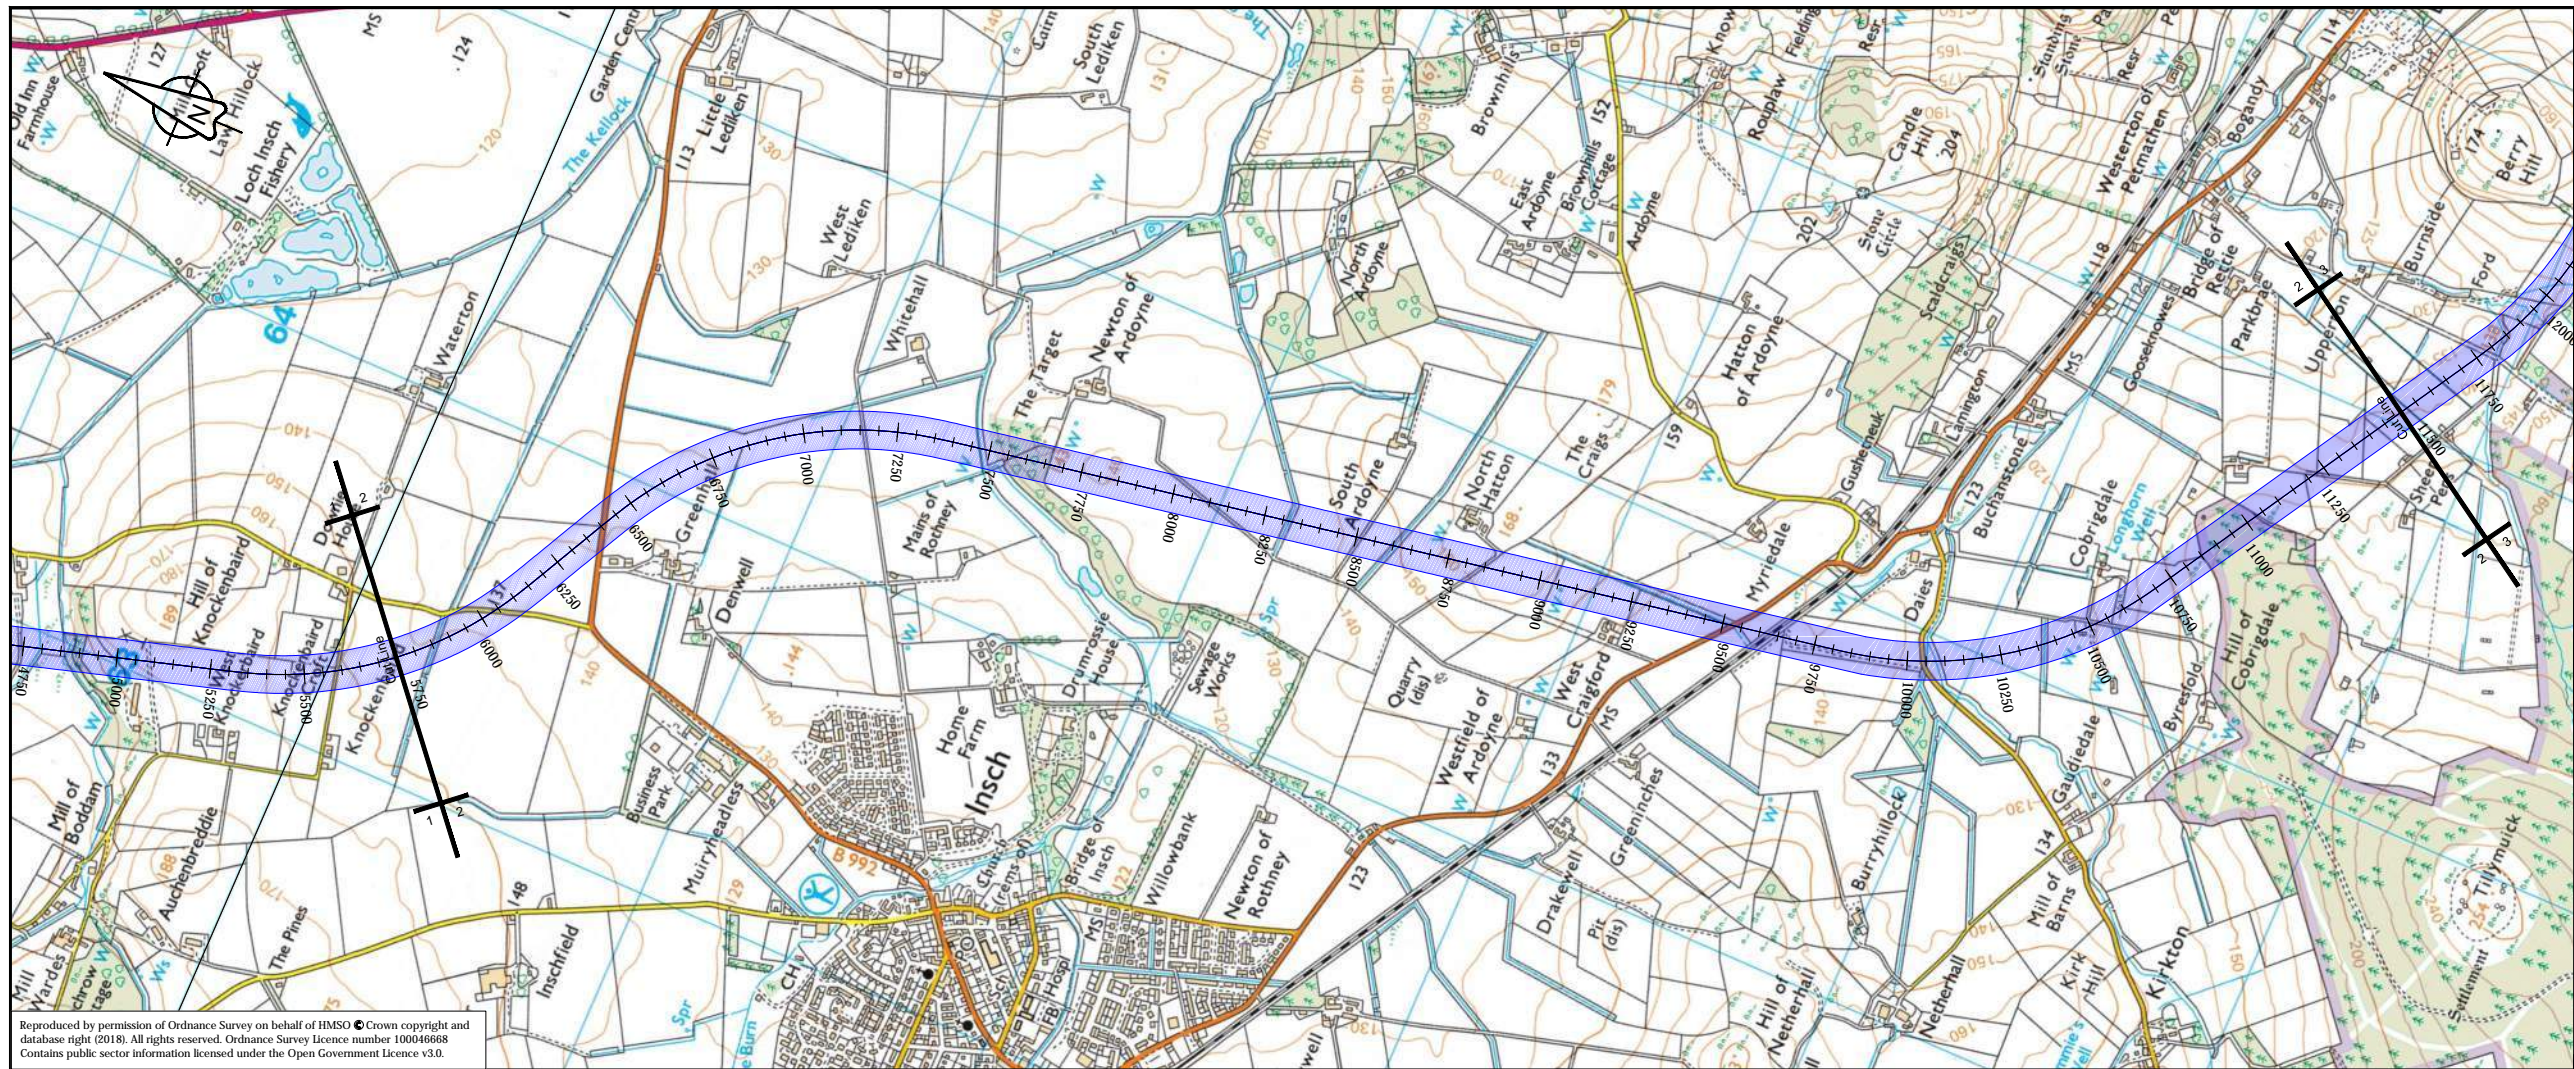

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Chainage	Proposed Road Level	Existing Ground Level	Level Difference
9750.000	144.500	144.306	0.194
9800.000	143.700	142.250	1.450
9850.000	142.900	140.200	2.700
9900.000	142.100	138.150	3.950
9950.000	141.300	136.100	5.200
10000.000	140.500	134.050	6.450
10050.000	139.700	132.000	7.700
10100.000	138.900	130.000	8.900
10150.000	138.100	128.000	10.100
10200.000	137.300	126.000	11.300
10250.000	136.500	124.000	12.500
10300.000	135.700	122.000	13.700
10350.000	134.900	120.000	14.900
10400.000	134.100	118.000	16.100
10450.000	133.300	116.000	17.300
10500.000	132.500	114.000	18.500
10550.000	131.700	112.000	19.700
10600.000	130.900	110.000	20.900
10650.000	130.100	108.000	22.100
10700.000	129.300	106.000	23.300
10750.000	128.500	104.000	24.500
10800.000	127.700	102.000	25.700
10850.000	126.900	100.000	26.900
10900.000	126.100	98.000	28.100
10950.000	125.300	96.000	29.300
11000.000	124.500	94.000	30.500
11050.000	123.700	92.000	31.700
11100.000	122.900	90.000	32.900
11150.000	122.100	88.000	34.100
11200.000	121.300	86.000	35.300
11250.000	120.500	84.000	36.500
11300.000	119.700	82.000	37.700
11350.000	118.900	80.000	38.900
11400.000	118.100	78.000	40.100
11450.000	117.300	76.000	41.300
11500.000	116.500	74.000	42.500

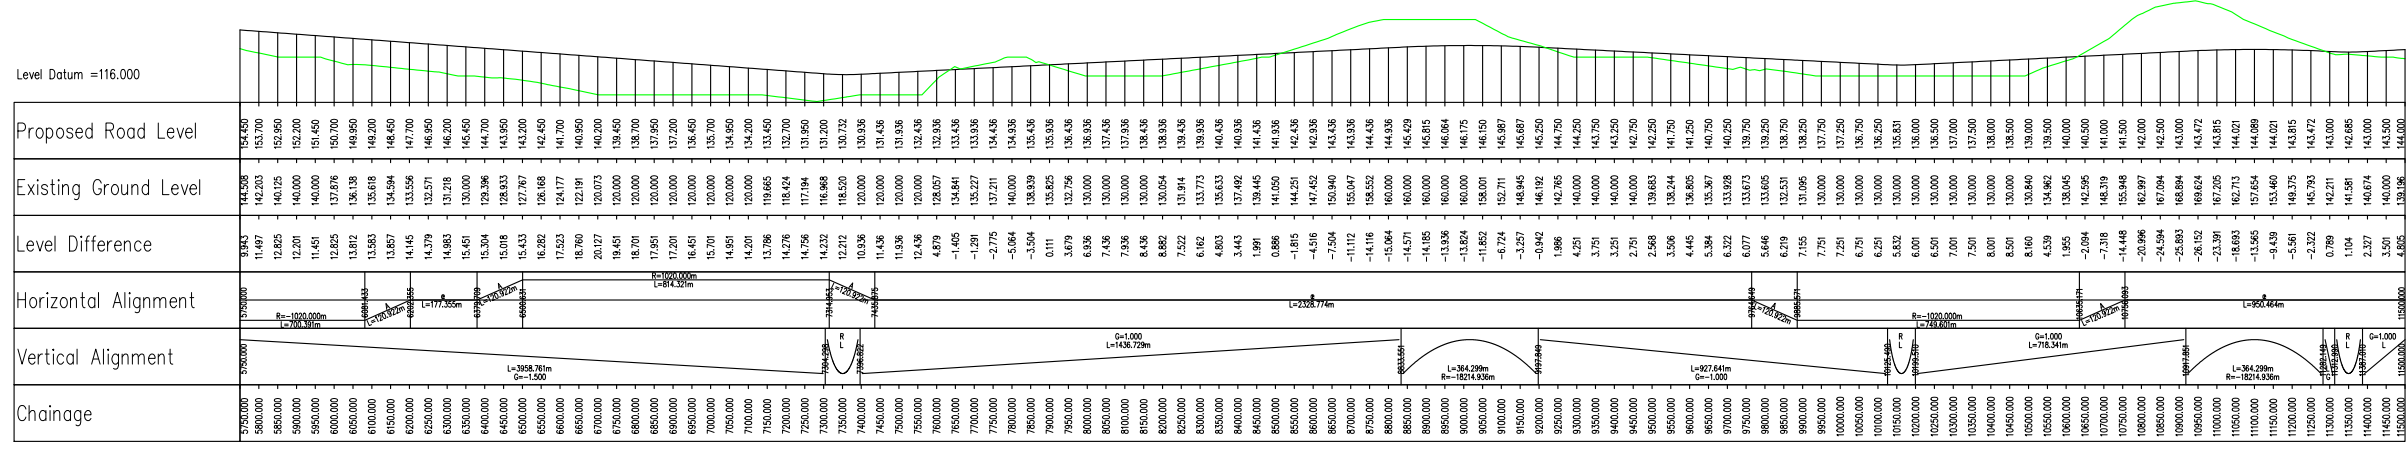P01	Fit For Information - First Fix Alignments				
	TD	SC	CL	CB	GMacD
	02/03/18	02/03/18	02/03/18	02/03/18	02/03/18

Revision details

Revision	Created	Checked	Reviewed	Approved	Authorised
	dd/mm/yy	dd/mm/yy	dd/mm/yy	dd/mm/yy	dd/mm/yy

Designer
 Precision House
 McNeil Drive
 Motherwell
 ML1 4UR

Client
 58 Port Dundas Road
 Glasgow
 G4 0HF


Project Name
A96 Dualling East of Huntly to Aberdeen

Drawing Title
CN03_002 First Fix Alignment Plan and Profile Sheet 2 of 3


Project Ref. No. 250002-92	Stage 2	Scale: 1:10000H 1:2000V @ A1 Dimensions: M
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Drawing Number A96PEA - AMAR - HGN - CC - DR-CH- 003202	Project Originator Volume Location Type Role Number
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Suitability S2	Suitability Description Fit For Information	Revision P01
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P01	Fit For Information - First Fix Alignments				
	TD	SC	CL	CB	GMacD
	02/03/18	02/03/18	02/03/18	02/03/18	02/03/18
Revision	Revision details				
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	dd/mm/yy	dd/mm/yy	dd/mm/yy	dd/mm/yy	dd/mm/yy

Designer
Precision House
McNeil Drive
Motherwell
ML1 4UR

Client
58 Port Dundas Road
Glasgow
G4 0HF

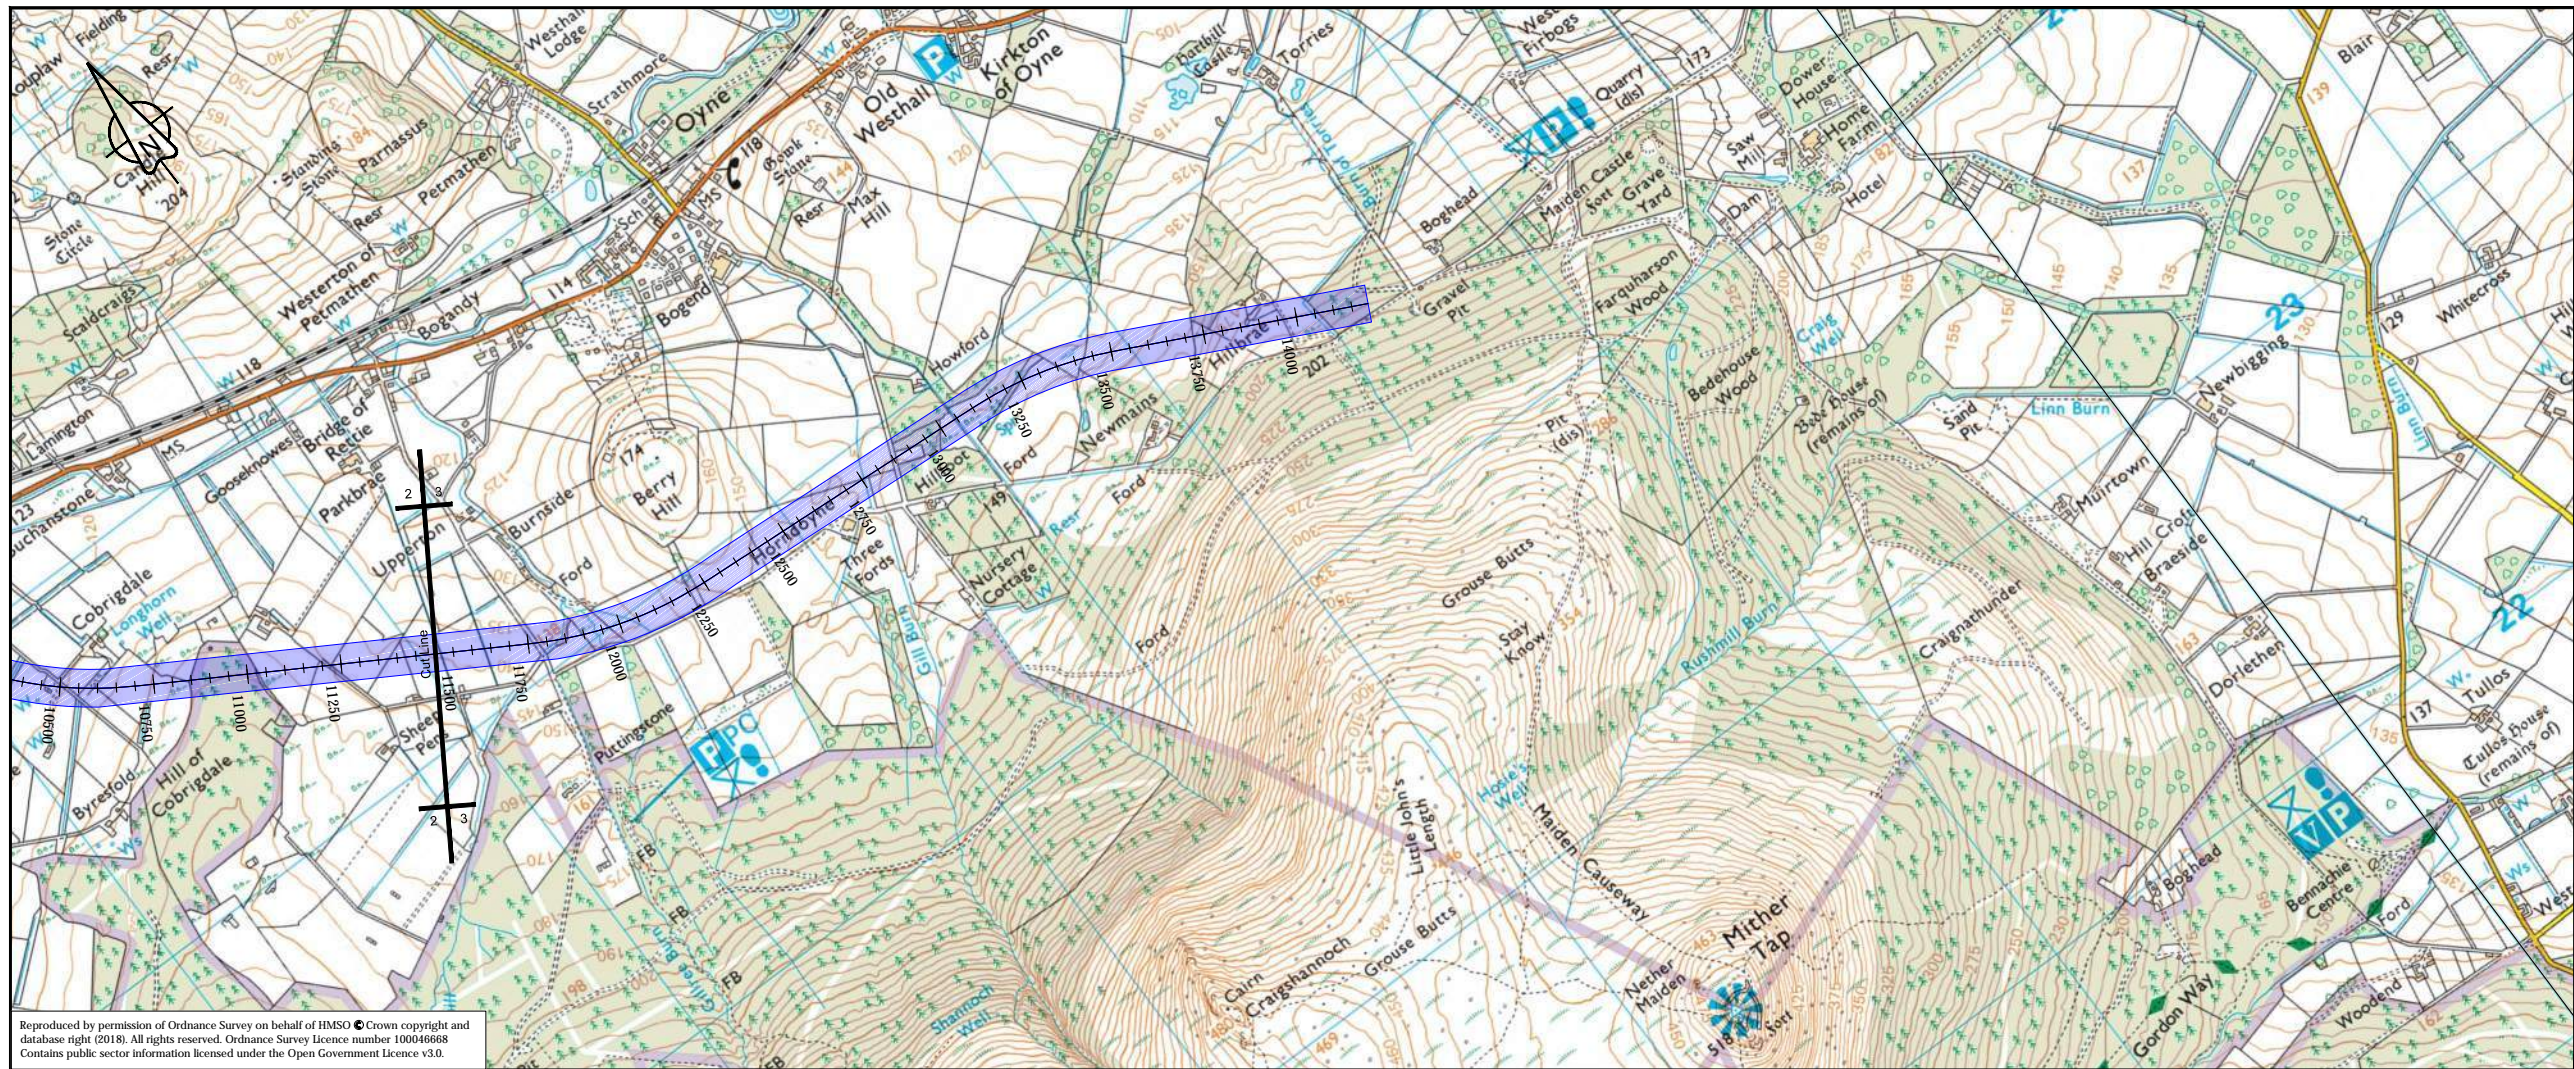
Project Name
A96 Dualling East of Huntly to Aberdeen

Drawing Title
CN03_002 First Fix Alignment Plan and Profile Sheet 3 of 3

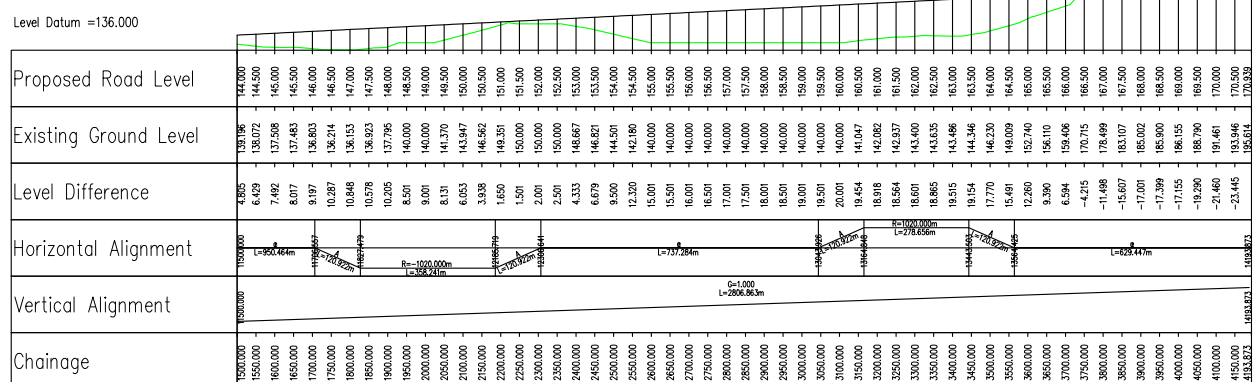
Project Ref. No.	Stage	Scale
250002-92	2	1:10000H 1:2000V @ A1
Dimensions: M		

Drawing Number	Project	Originator	Volume
CC	A96PEA	- AMAR - HGN -	
Location	Type	Role	Number

Suitability	Suitability Description	Revision
S2	Fit For Information	P01

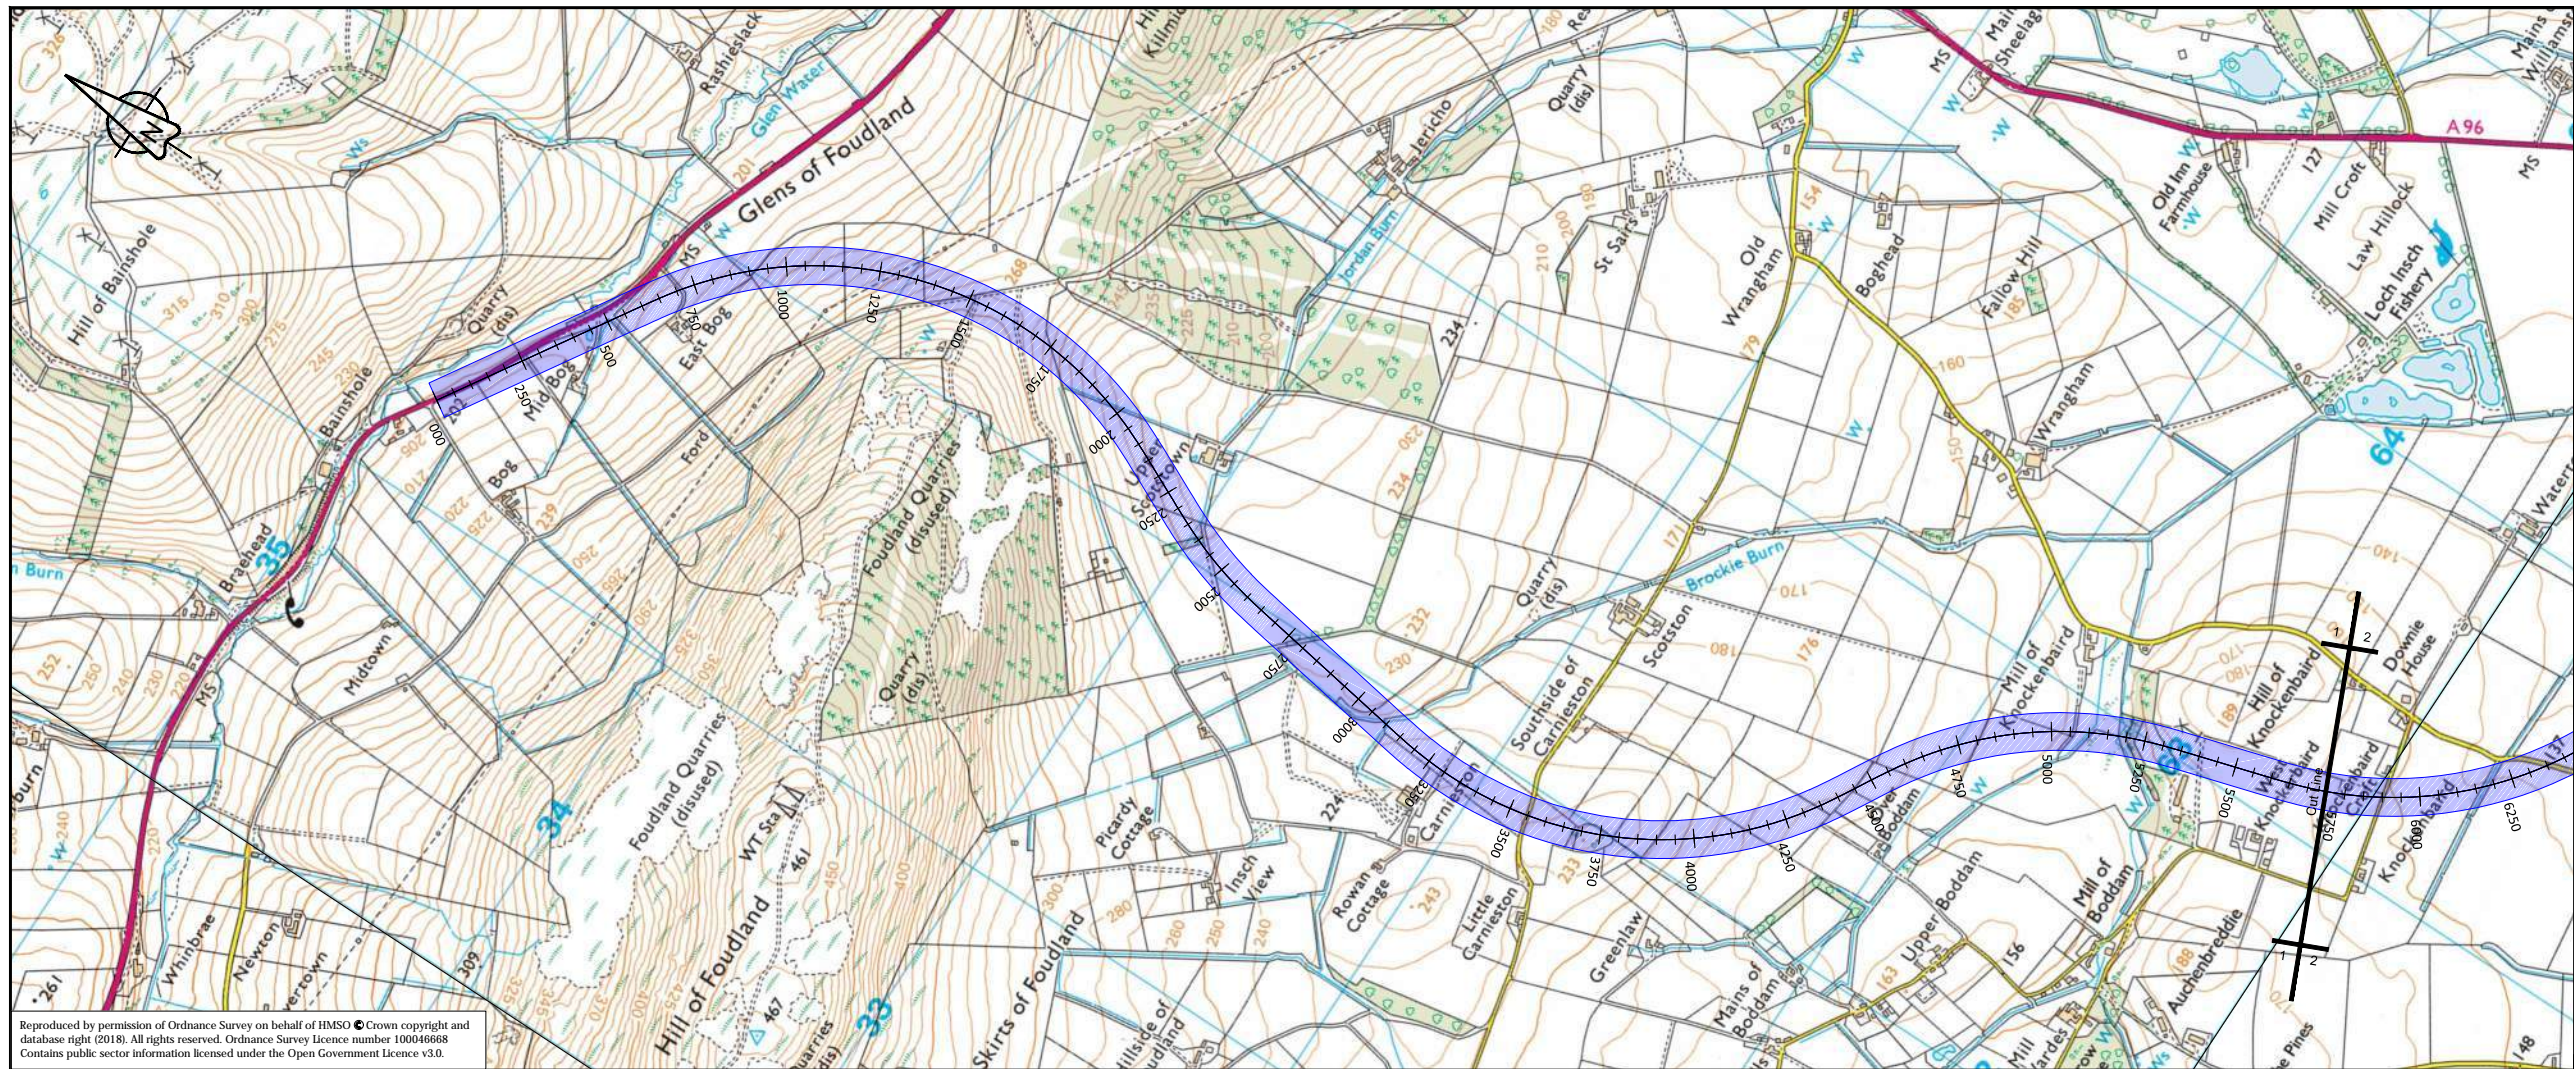

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P01	Fit For Information - First Fix Alignments				
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	02/03/18	02/03/18	02/03/18	02/03/18	02/03/18

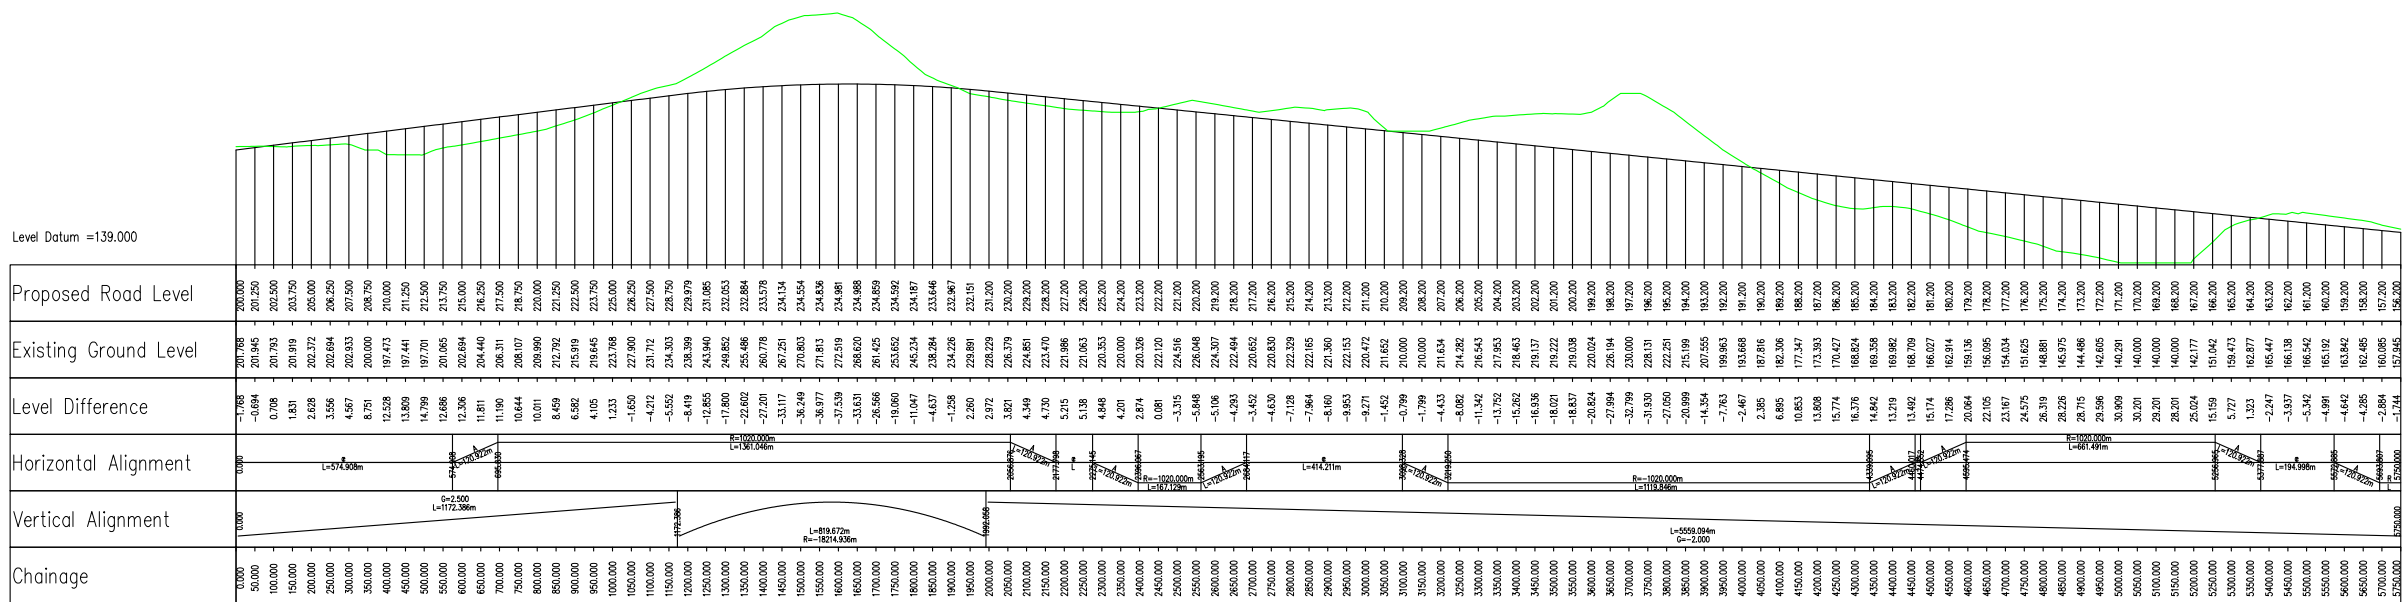Revision	Revision details				
	Created	Checked	Reviewed	Approved	Authorised
	dd/mm/yy	dd/mm/yy	dd/mm/yy	dd/mm/yy	dd/mm/yy

Designer
Precision House
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 Glasgow
 G4 0HF




Project Name
A96 Dualling East of Huntly to Aberdeen

Drawing Title
CN03_003 First Fix Alignment Plan and Profile Sheet 1 of 3

Project Ref. No. 250002-92	Stage 2	Scale: 1:1000H 1:2000V @ A1 Dimensions: M
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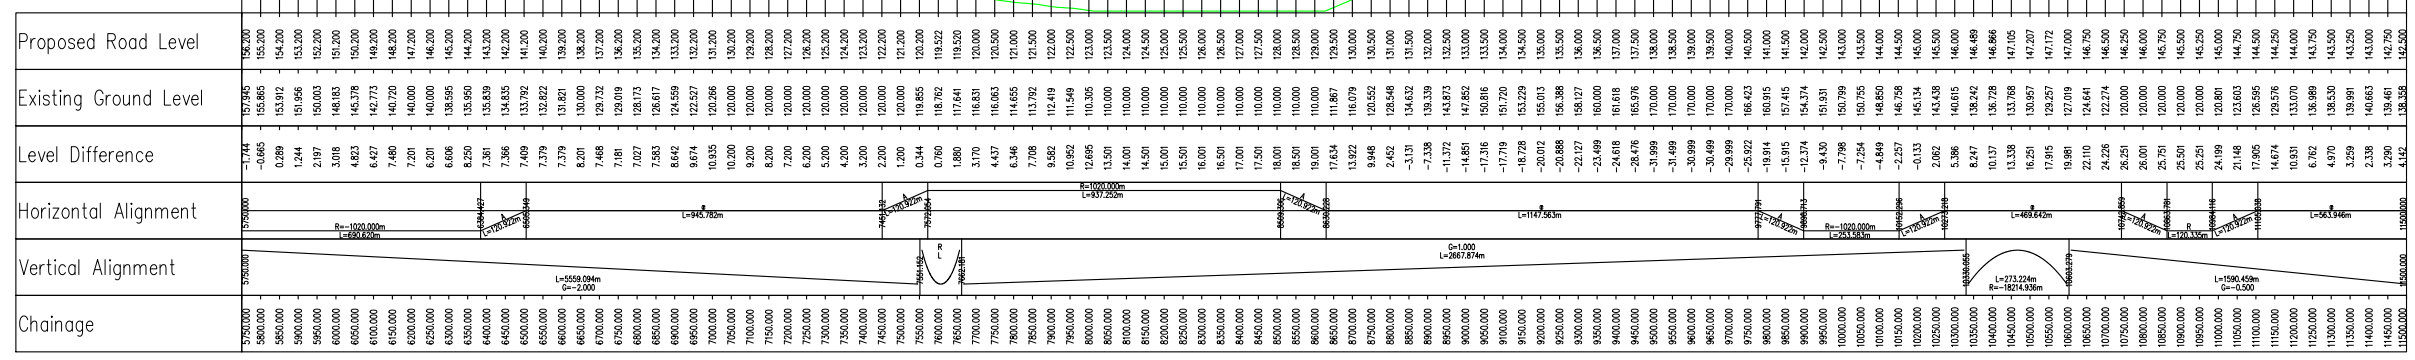
Drawing Number A96PEA - AMAR - HGN - CC - DR-CH- 003301	Project Originator Volume Location Type Role Number
--	---

Suitability S2	Suitability Description Fit For Information	Revision P01
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Level Datum = 109.000

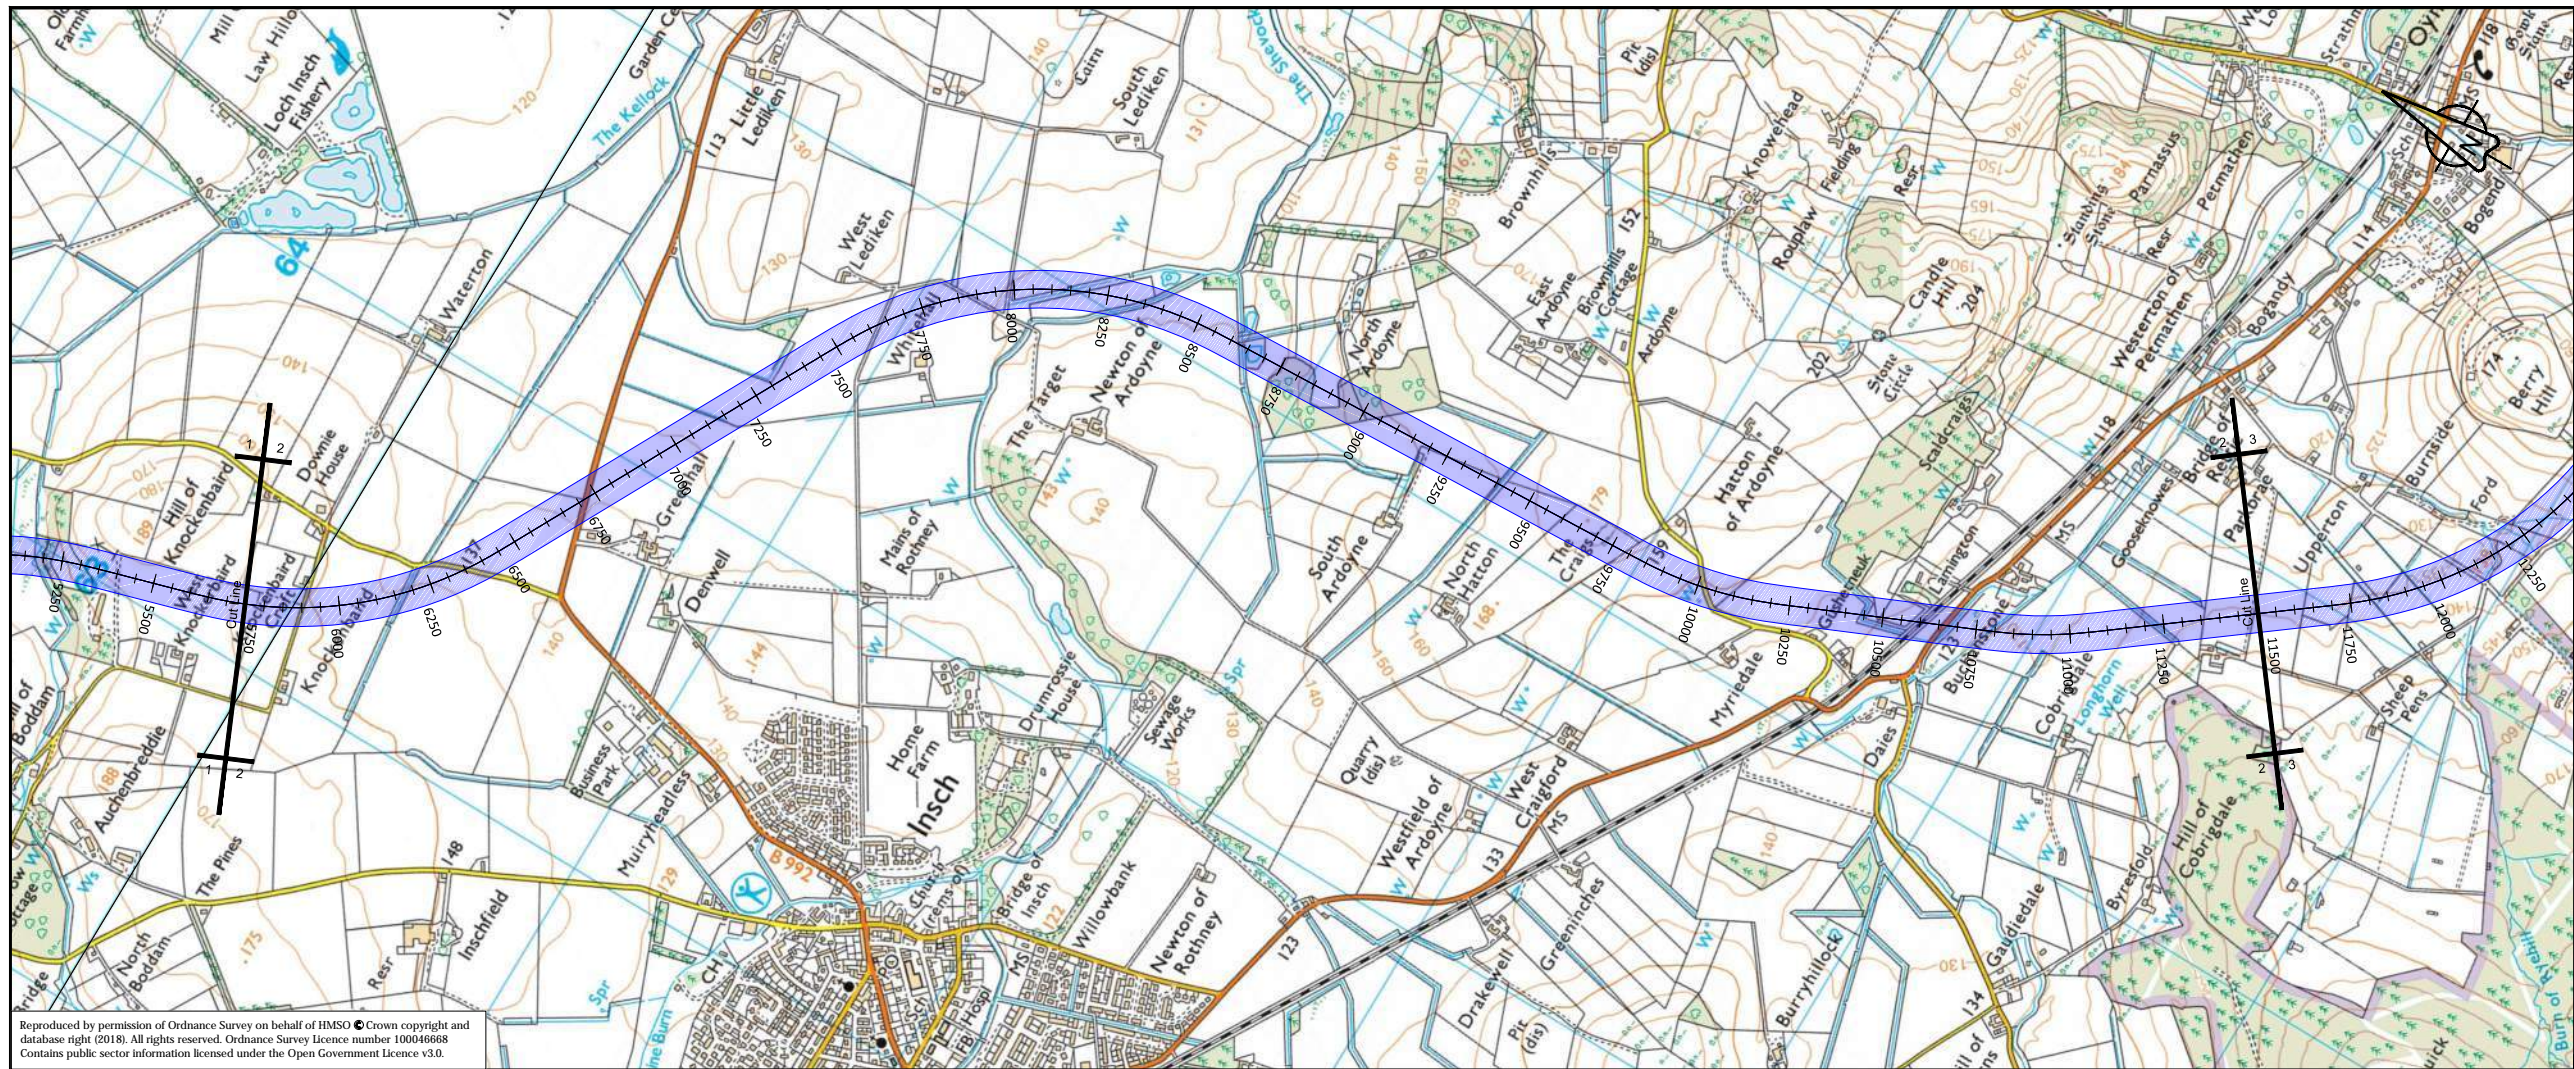

P01	Fit For Information - First Fix Alignments				
	TD	SC	CL	CB	GMacD
	02/03/18	02/03/18	02/03/18	02/03/18	02/03/18
Revision	Revision details				
	Created	Checked	Reviewed	Approved	Authorised
	dd/mm/yy	dd/mm/yy	dd/mm/yy	dd/mm/yy	dd/mm/yy

Designer
Precision House
McNeil Drive
Motherwell
ML1 4UR

Client
58 Port Dundas Road
Glasgow
G4 0HF


Project Name
A96 Dualling East of Huntly to Aberdeen

Drawing Title
CN03_003 First Fix Alignment Plan and Profile Sheet 2 of 3


Project Ref. No. 250002-92	Stage 2	Scale: 1:10000H 1:2000V @ A1 Dimensions: M
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Drawing Number	Project	Originator	Volume
A96PEA - AMAR - HGN - CC			
	Location	Type	Role
			Number

Suitability	Suitability Description	Revision
S2	Fit For Information	P01

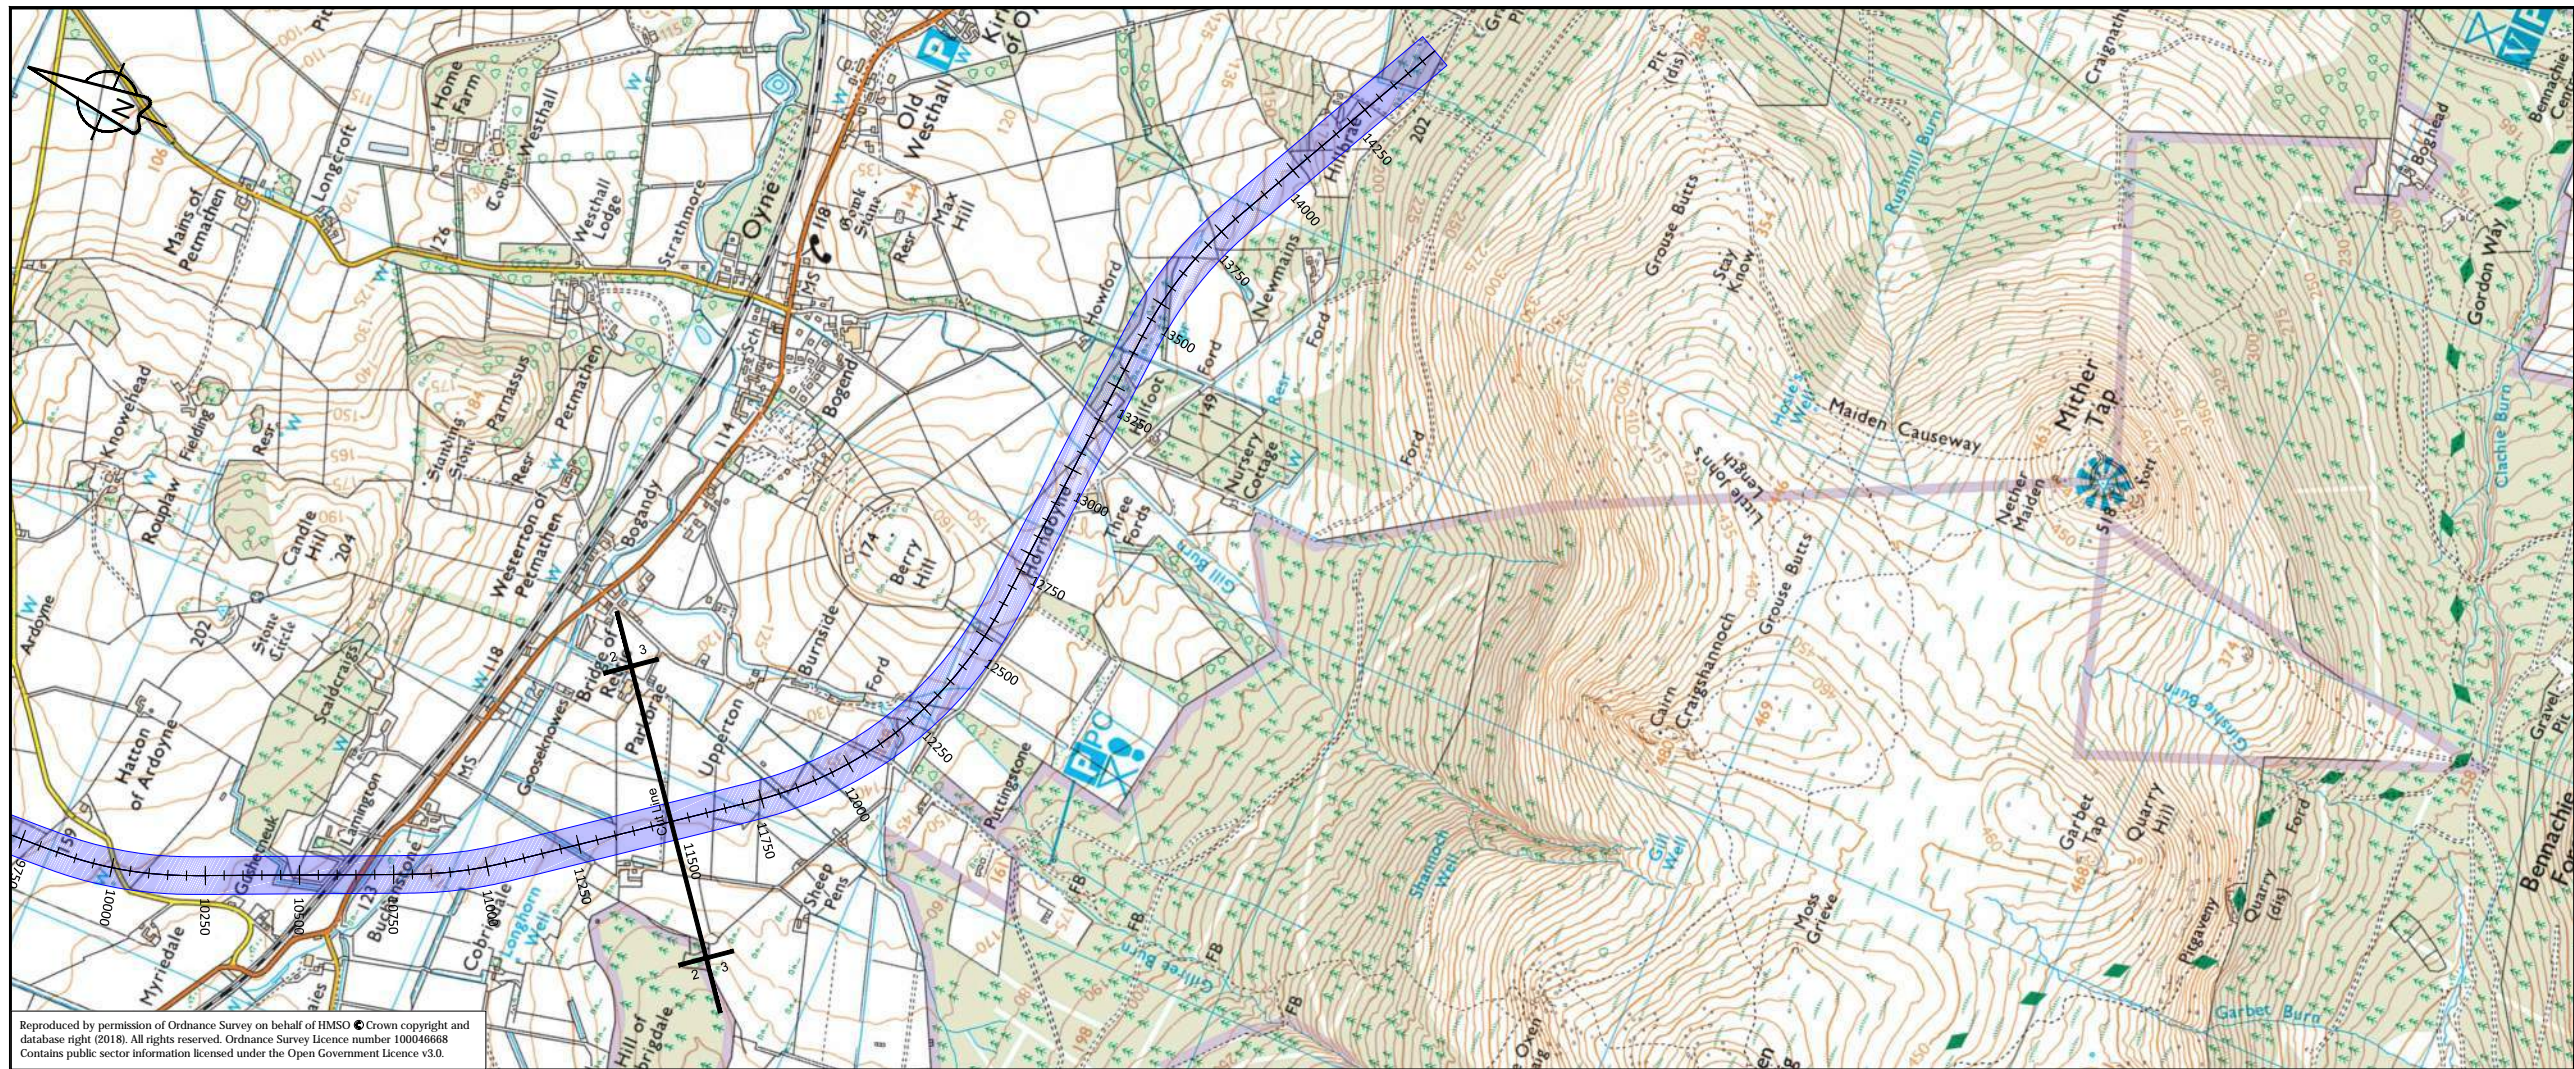

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P01	Fit For Information - First Fix Alignments				
	TD	SC	CL	CB	GMacD
	02/03/18	02/03/18	02/03/18	02/03/18	02/03/18

Revision	Revision details				
	Created	Checked	Reviewed	Approved	Authorised
	dd/mm/yy	dd/mm/yy	dd/mm/yy	dd/mm/yy	dd/mm/yy

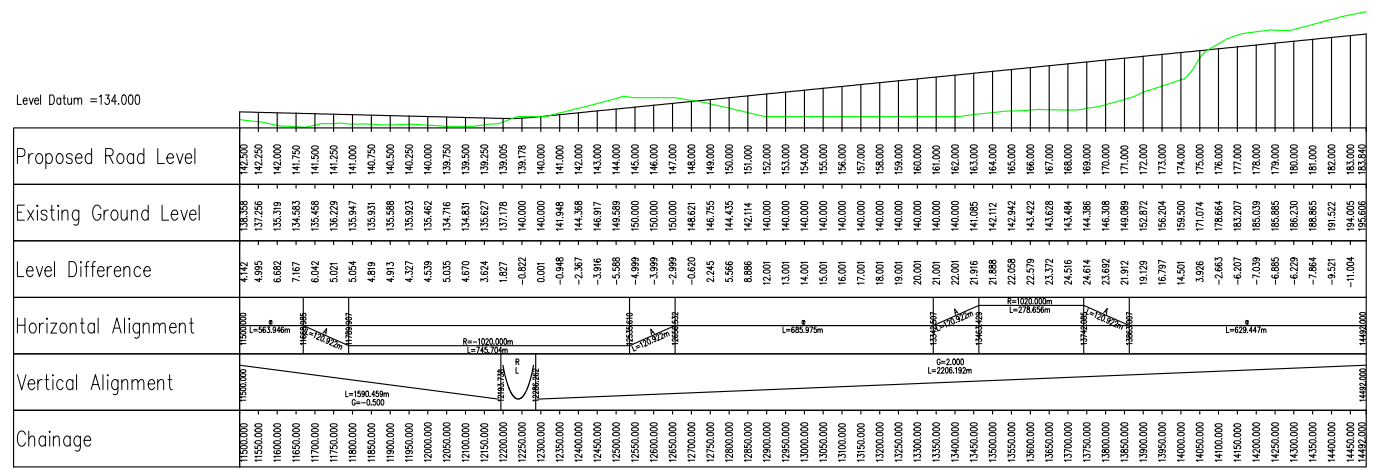Designer
 Precision House
 McNeil Drive
 Motherwell
 ML1 4UR

Client
 58 Port Dundas Road
 Glasgow
 G4 0HF


Project Name
A96 Dualling East of Huntly to Aberdeen

Drawing Title
**CN03_003 First Fix Alignment
 Plan and Profile
 Sheet 3 of 3**

Project Ref. No. 250002-92	Stage 2	Scale: 1:10000H 1:2000V @ A1 Dimensions: As shown
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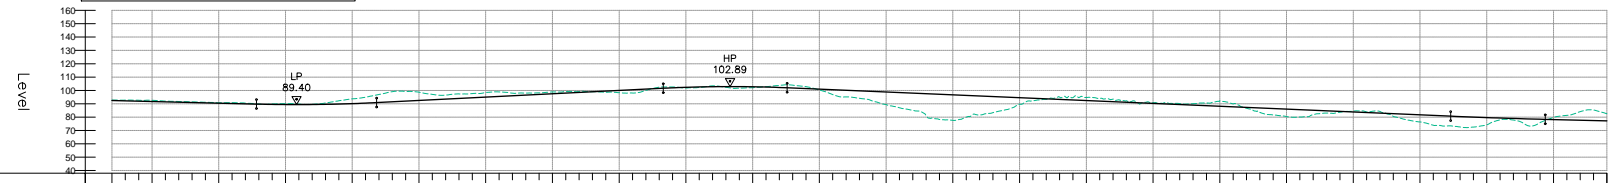
Drawing Number	Project	Originator	Volume
A96PEA - AMAR - HGN -	CC	-DR-CH-	003303
	Location	Type	Role

Suitability	Suitability Description	Revision
S2	Fit For Information	P01

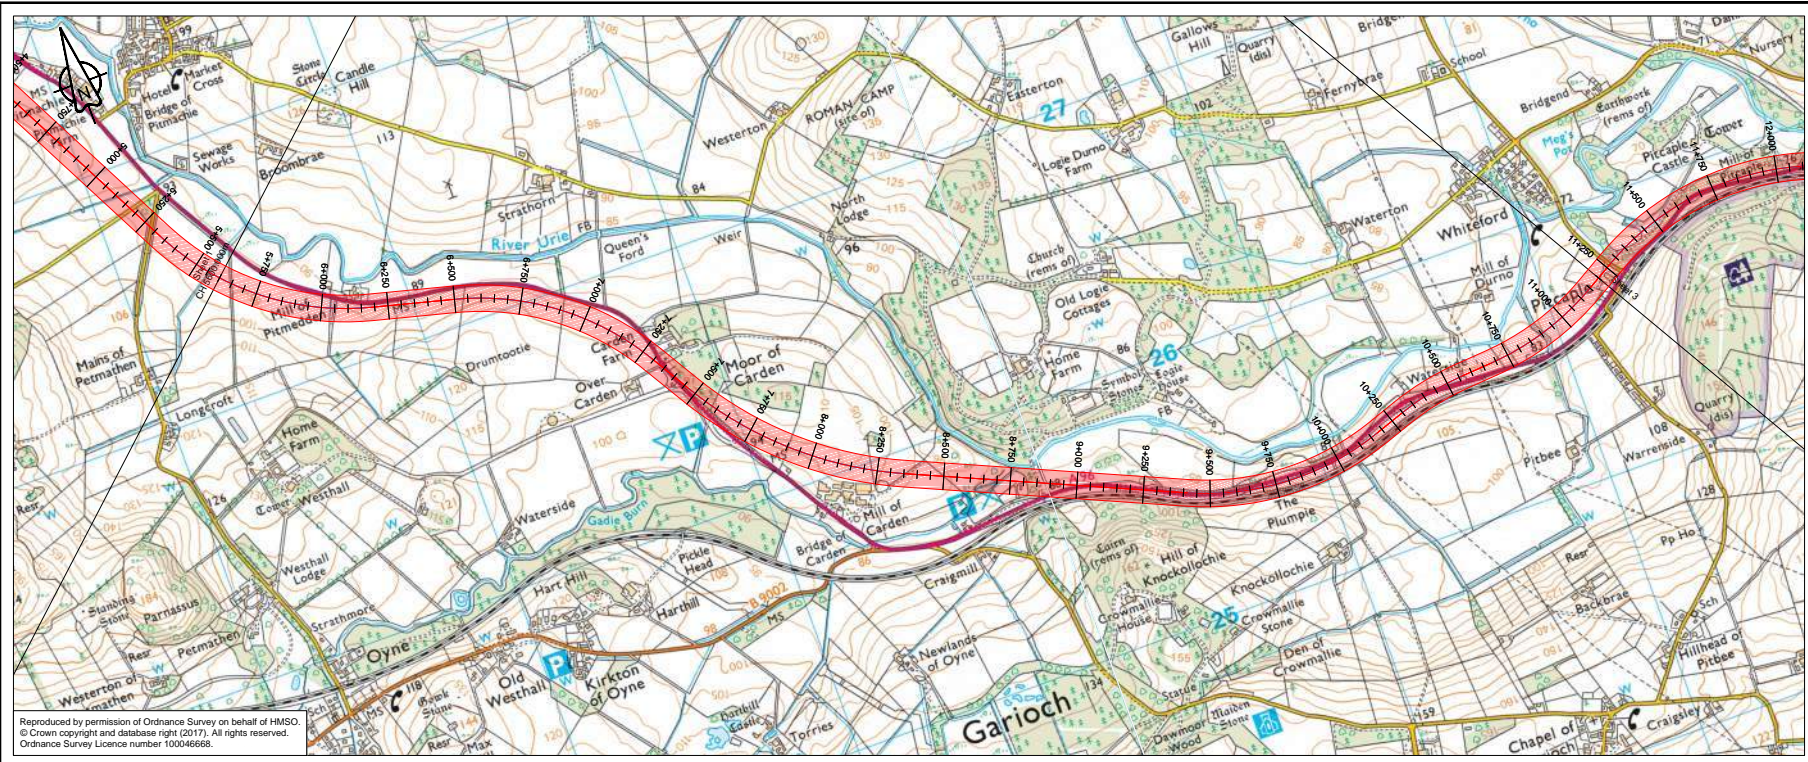


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OLC_001 - LONGSECTION
SCALE: H 1:10000, V 1:2000, DATUM: 40,000




Proposed Road Level	92.484 92.234 91.984 0.234 -0.084 -0.334 -0.584 -14.584 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OLC_002 - LONGSECTION
SCALE: H 1:10000, V 1:2000, DATUM: 50.000

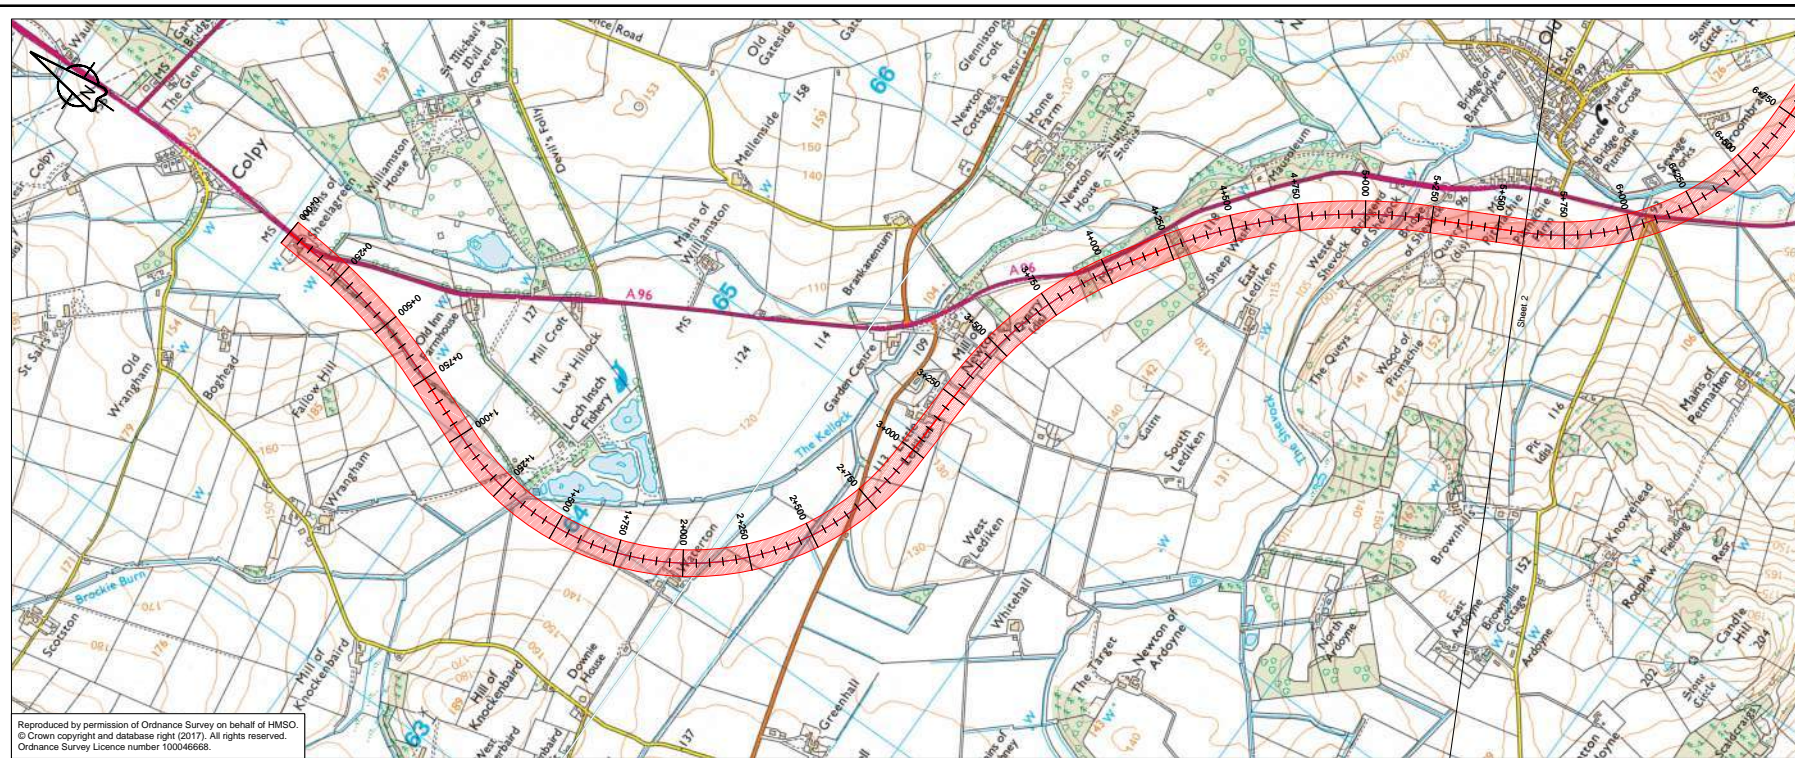

Chainage	Proposed Road Level	Existing Ground Level	Level Difference	Horizontal Alignment	Vertical Alignment
0+000	139.729	139.729	0.000	L=119.571	G=-2.23200000
0+100	138.623	138.990	-0.347	R: 2040.000	G=0.75094
0+200	137.947	138.404	-0.457	L=619.545	L=534.064
0+300	137.537	137.966	-0.048	L=274.555	R=18200.000
0+400	136.310	136.596	-0.275	R: 1020.000	K=182.000
0+500	135.310	136.310	-0.000	L=1991.631	L=564.200
0+600	134.448	135.950	-1.387	L=334.973	G=-2.3700000
0+700	133.435	135.435	-1.768	R: 1440.000	L=350.730
0+800	132.360	134.930	-2.119	L=804.022	K=18200.000
0+900	131.230	134.360	-2.174	L=135.112	L=641.443
1+000	130.050	133.810	-2.188	R: 2040.000	G=-1.151%
1+100	128.820	133.240	-2.420	L=1013.031	L=2381.945
1+200	127.540	132.670	-2.426	L=350.873	
1+300	126.210	132.100	-2.426		
1+400	124.880	131.530	-2.426		
1+500	123.550	130.960	-2.426		
1+600	122.220	130.390	-2.426		
1+700	120.890	129.820	-2.426		
1+800	119.560	129.250	-2.426		
1+900	118.230	128.680	-2.426		
2+000	116.900	128.110	-2.426		
2+100	115.570	127.540	-2.426		
2+200	114.240	126.970	-2.426		
2+300	112.910	126.400	-2.426		
2+400	111.580	125.830	-2.426		
2+500	110.250	125.260	-2.426		
2+600	108.920	124.690	-2.426		
2+700	107.590	124.120	-2.426		
2+800	106.260	123.550	-2.426		
2+900	104.930	122.980	-2.426		
3+000	103.600	122.410	-2.426		
3+100	102.270	121.840	-2.426		
3+200	100.940	121.270	-2.426		
3+300	99.610	120.700	-2.426		
3+400	98.280	120.130	-2.426		
3+500	96.950	119.560	-2.426		
3+600	95.620	118.990	-2.426		
3+700	94.290	118.420	-2.426		
3+800	92.960	117.850	-2.426		
3+900	91.630	117.280	-2.426		
4+000	90.300	116.710	-2.426		
4+100	88.970	116.140	-2.426		
4+200	87.640	115.570	-2.426		
4+300	86.310	115.000	-2.426		
4+400	84.980	114.430	-2.426		
4+500	83.650	113.860	-2.426		
4+600	82.320	113.290	-2.426		
4+700	80.990	112.720	-2.426		
4+800	79.660	112.150	-2.426		
4+900	78.330	111.580	-2.426		
5+000	77.000	111.010	-2.426		
5+100	75.670	110.440	-2.426		
5+200	74.340	109.870	-2.426		
5+300	73.010	109.300	-2.426		
5+400	71.680	108.730	-2.426		
5+500	70.350	108.160	-2.426		

P01	Fit For Information - First Fix Alignments				
	KB	RO	FM	GW	AGF
	23/02/18	23/02/18	23/02/18	19/04/18	19/04/18
Revision	Created	Checked	Reviewed	Approved	Authorised
	dd/mm/yy	dd/mm/yy	dd/mm/yy	dd/mm/yy	dd/mm/yy
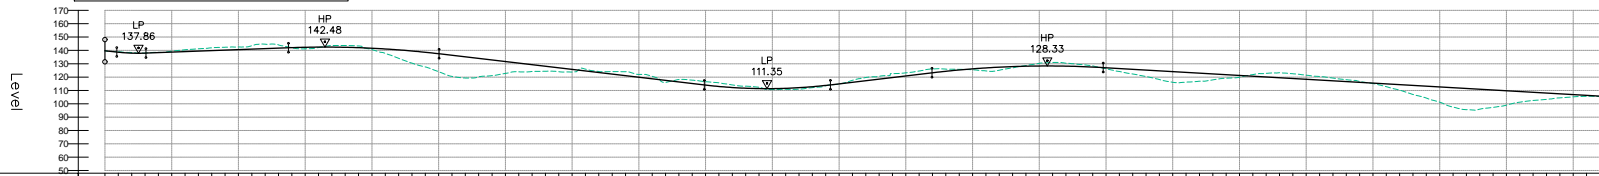
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Project Name
A96 Dualling East of Huntly to Aberdeen

Drawing Title
OLC-002 First Fix Alignment Plan and Profile
Sheet 1 of 3

Project Ref. No.	Stage	Scale
250002-92	2	1:10000H 1:2000V @ A1
Dimensions : M		

Drawing Number	Project	Originator	Volume
A96PEA - AMAR - HGN -	CB	-DR-CH-	101201
Location	Type	Role	Number

Suitability	Suitability Description	Revision
S2	Suitable For Information	P01