



Report



Access to Argyll & Bute [A83]

DMRB Stage 2 Scheme Assessment Report

Volume 2 – Engineering Drawings

Transport Scotland

May 2023

A83AAB-AWJ-GEN-LTS_GEN-RP-ZZ-000004

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Notice

This document and its contents have been prepared and are intended solely as information for Transport Scotland and use in relation to the Access to Argyll and Bute (A83) project.

Atkins WSP Joint Venture assumes no responsibility to any other party in respect of or arising out of or in connection with this document and/or its contents.

This document has 233 pages including the cover.

Revision	Status	Purpose description	Originated	Checked	Reviewed	Authorised	Date
P01	A1	Final	AB	CS	IA	RHG	30/05/23

Client signoff

Client	Transport Scotland
Project	Access to Argyll & Bute [A83]

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1. Existing Conditions

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[A83AAB-AWJ-GEN-LTS_GEN-DR-CX-000002_P01.pdf](#) – Sheet 2

[A83AAB-AWJ-GEN-LTS_GEN-DR-CX-000003_P01.pdf](#) – Sheet 3

[A83AAB-AWJ-GEN-LTS_GEN-DR-CX-000004_P01.pdf](#) – Sheet 4

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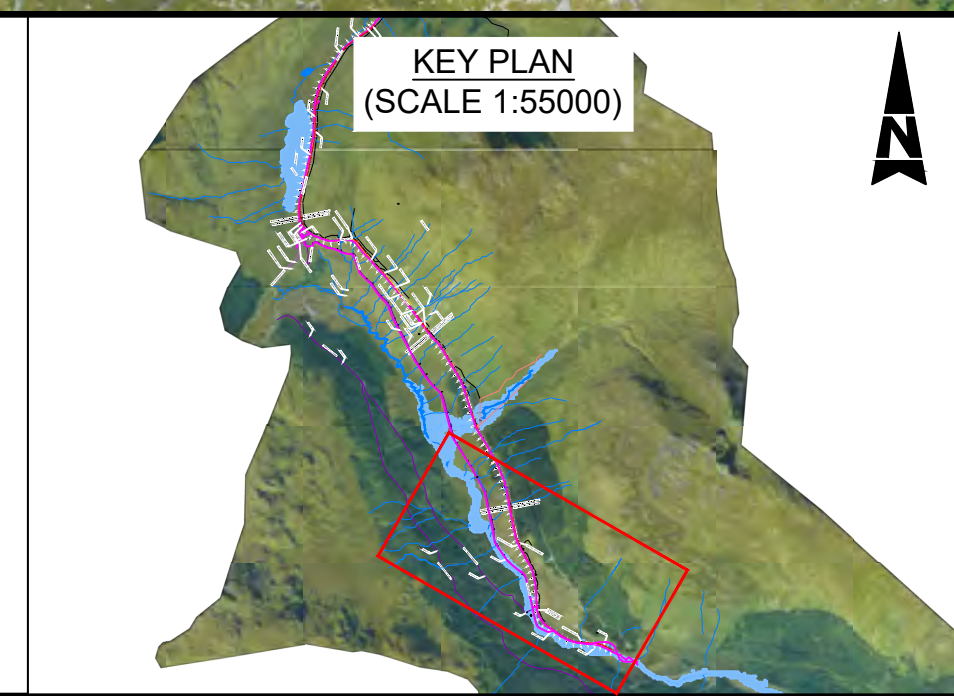
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NOTES:
 1. ALL DIMENSIONS SHOWN ARE IN METRES UNLESS STATED OTHERWISE.

KEY:

WATERCOURSES	ACCESS ROAD
SEPA FLOOD MAPPING (1 IN 200 YEAR)	B CLASS ROAD
CULVERT/WATERCOURSE STRUCTURES	LAY-BY
EXISTING INFRASTRUCTURE	RESIDENTIAL ACCESS
SUSTAINABLE TRAVEL FACILITIES	BT
BRIDGE	
RETAINING WALL	
FENCING	
ROCK FALL FENCING	
VEHICLE RESTRAINT SYSTEMS	



Description	Status	Revision	Drawn	Checked	Reviewed	Authorised	Issue Date
	S4	P01	PW	SL	CS	RHG	31/05/23

Project Stage / Design File: **DMRB Stage 2** State: **Preliminary**

Status: **S4** Drawing Suitability: **FOR STAGE APPROVAL**

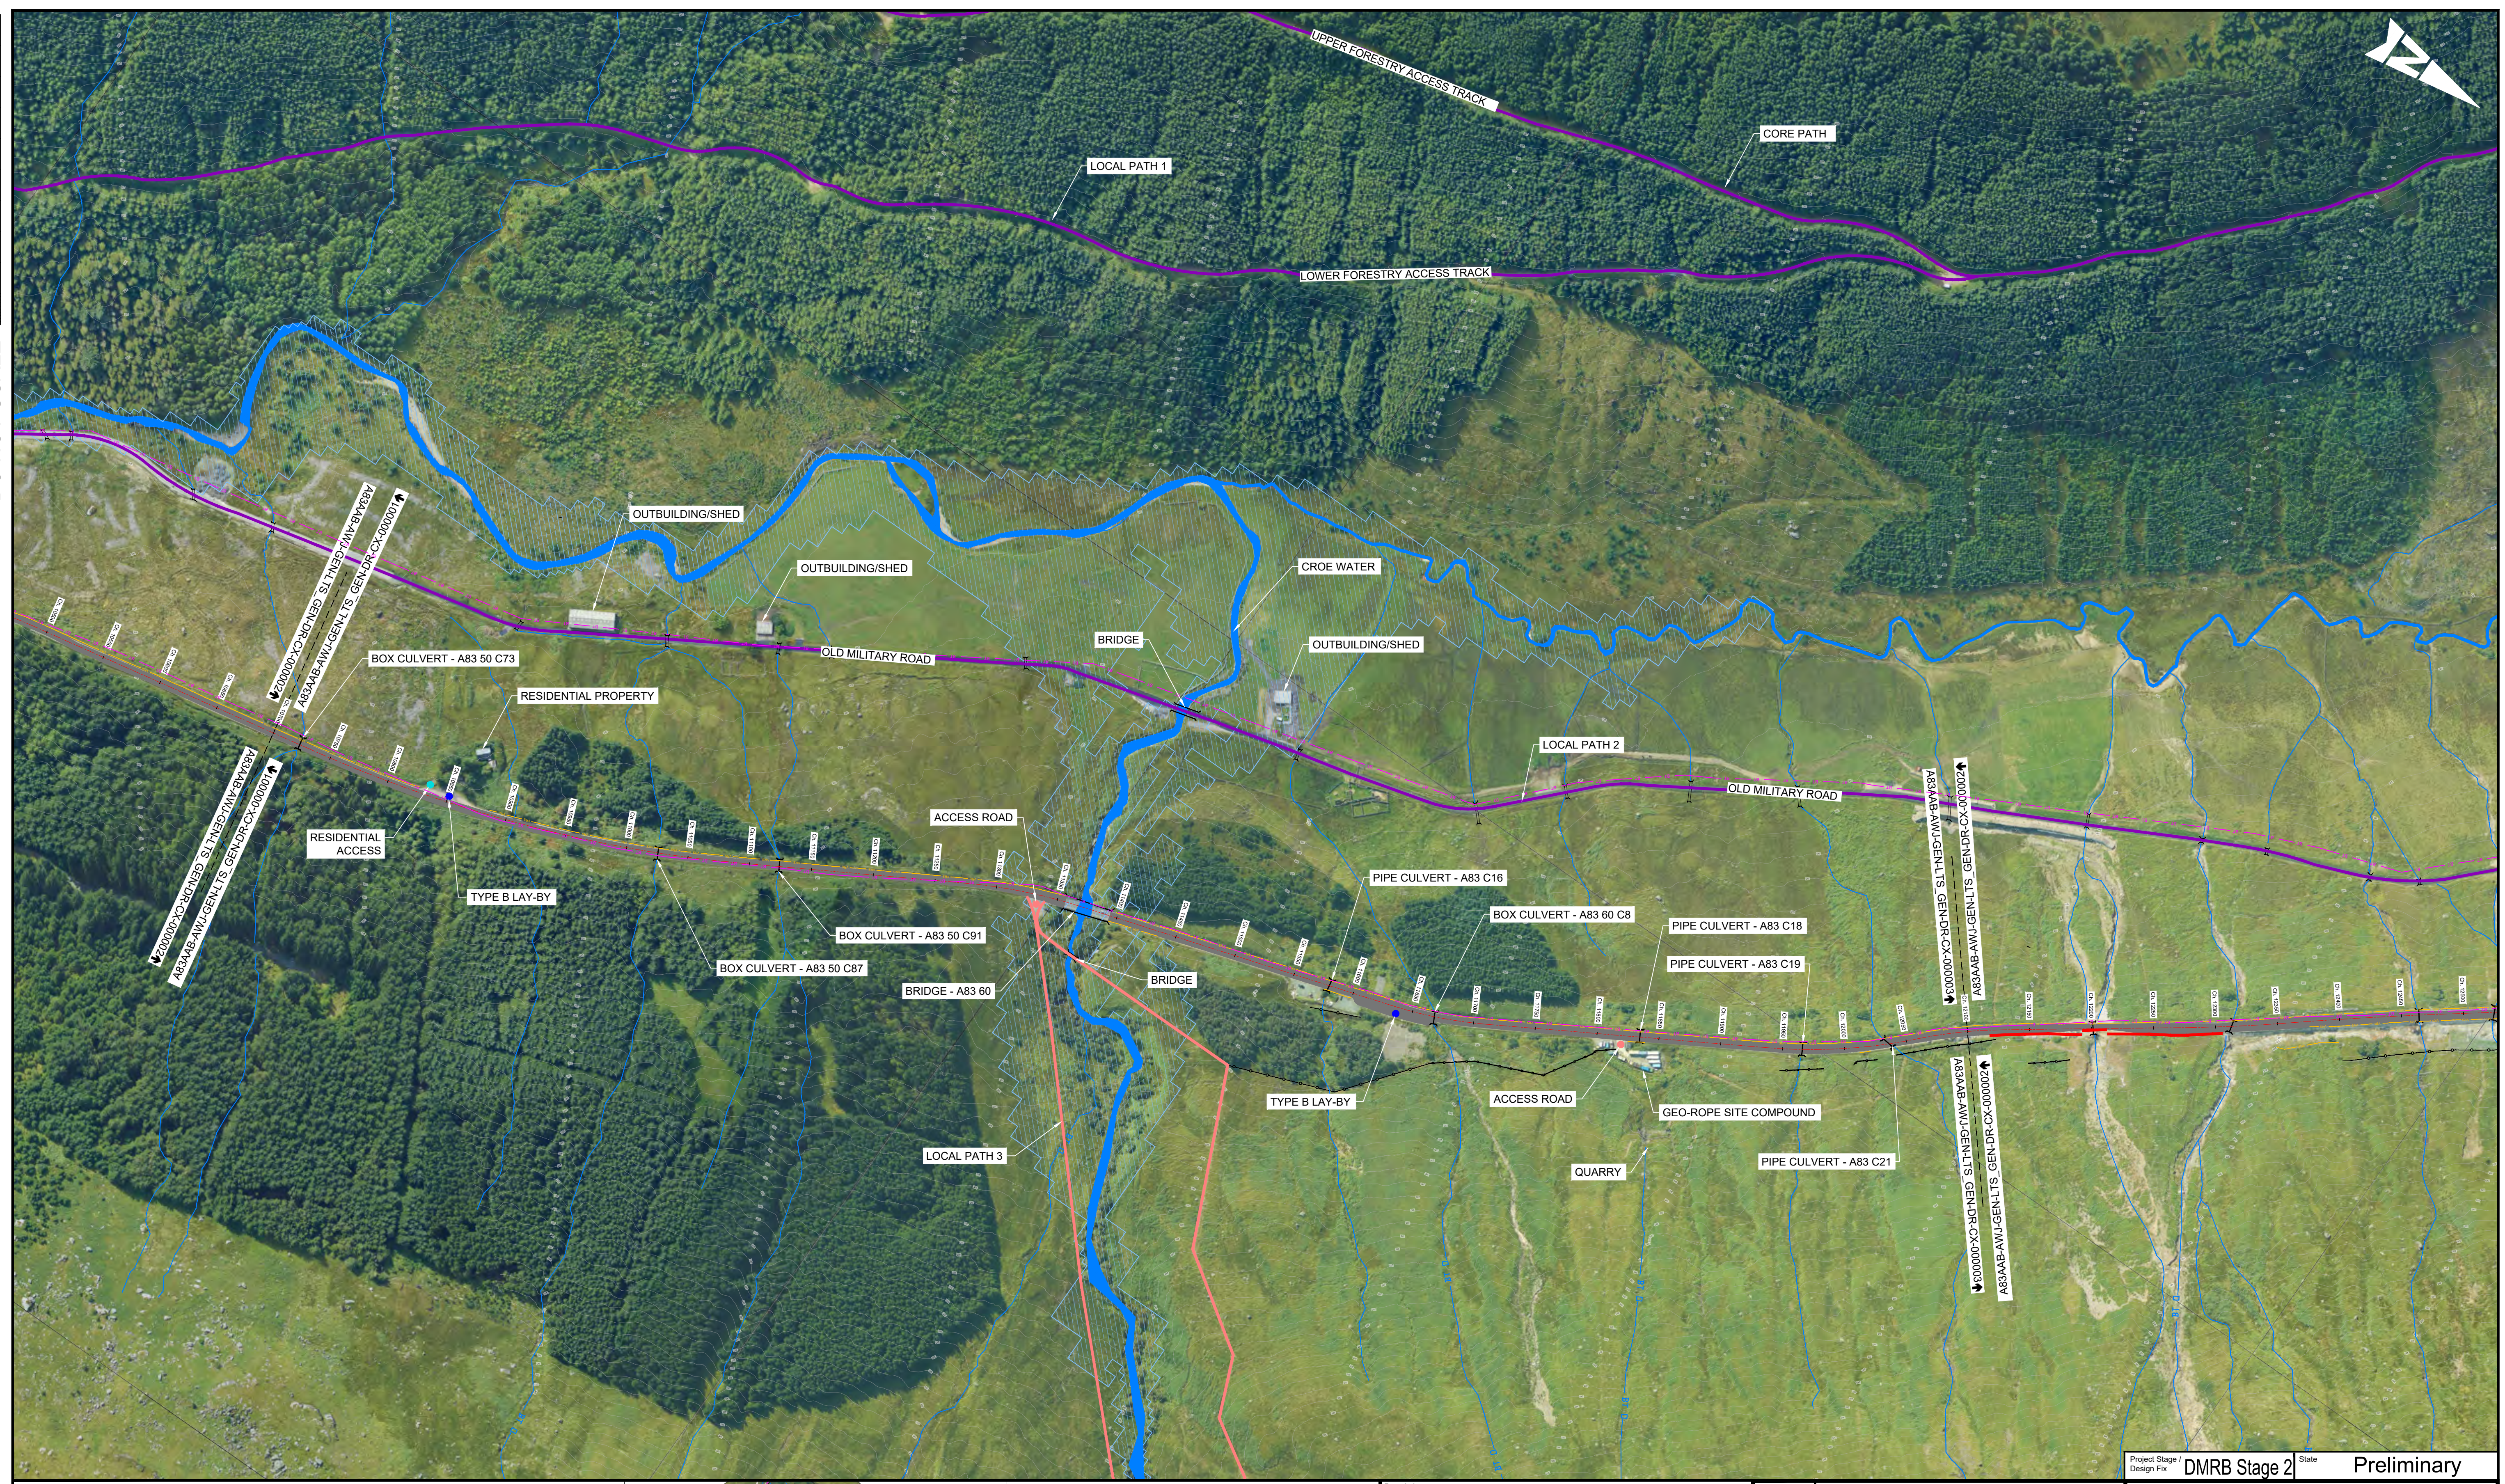
ATKINS **wsp**
 Member of the SNC-Lavalin Group

TRANSPORT SCOTLAND
 COMHDAIL ALBA

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Drawing Title	EXISTING CONDITIONS PLAN		
Drawing Number	Project	Originator	Volume
A83AAB - AWJ - GEN - LTS_GEN - DR - CX - 000001			
Location	Type	Role	Number
A1	Scale: 1:2500	Project Ref. No.: 6204594	Sheet: 1 of 4 Rev: P01

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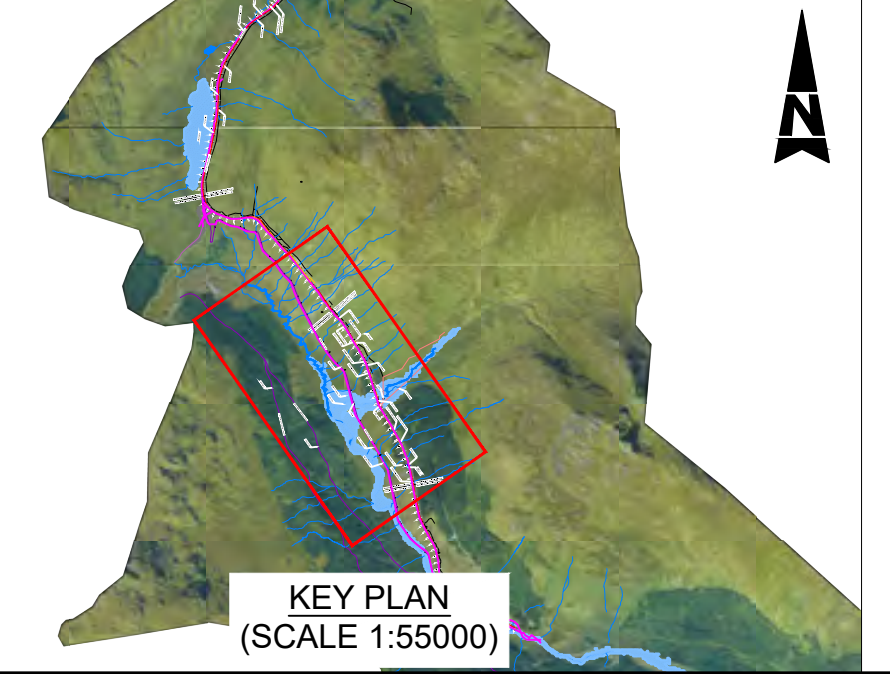
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NOTES:
1. ALL DIMENSIONS SHOWN ARE IN METRES UNLESS STATED OTHERWISE.

KEY:

WATERCOURSES	ACCESS ROAD
SEPA FLOOD MAPPING (1 IN 200 YEAR)	B CLASS ROAD
CULVERT/WATERCOURSE STRUCTURES	LAY-BY
EXISTING INFRASTRUCTURE	RESIDENTIAL ACCESS
SUSTAINABLE TRAVEL FACILITIES	BT
BRIDGE	
RETAINING WALL	
FENCING	
ROCK FALL FENCING	
VEHICLE RESTRAINT SYSTEMS	



Description	Status	Revision	Drawn	Checked	Reviewed	Authorised	Issue Date
	S4	P01	PW	SL	CS	RHG	31/05/23

Project Stage: Design File

Status: S4

Drawing Suitability: FOR STAGE APPROVAL

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TRANSPORT SCOTLAND

COMHDAIL ALBA

Project Title: DMRB Stage 2 Preliminary

Project: A83 AAB

Drawing Title: EXISTING CONDITIONS PLAN

Drawing Number: A83AAB - AWJ - GEN - LTS_GEN - DR - CX - 000002

Originator: AWJ

Volume: LTS_GEN

Client: TRANSPORT SCOTLAND

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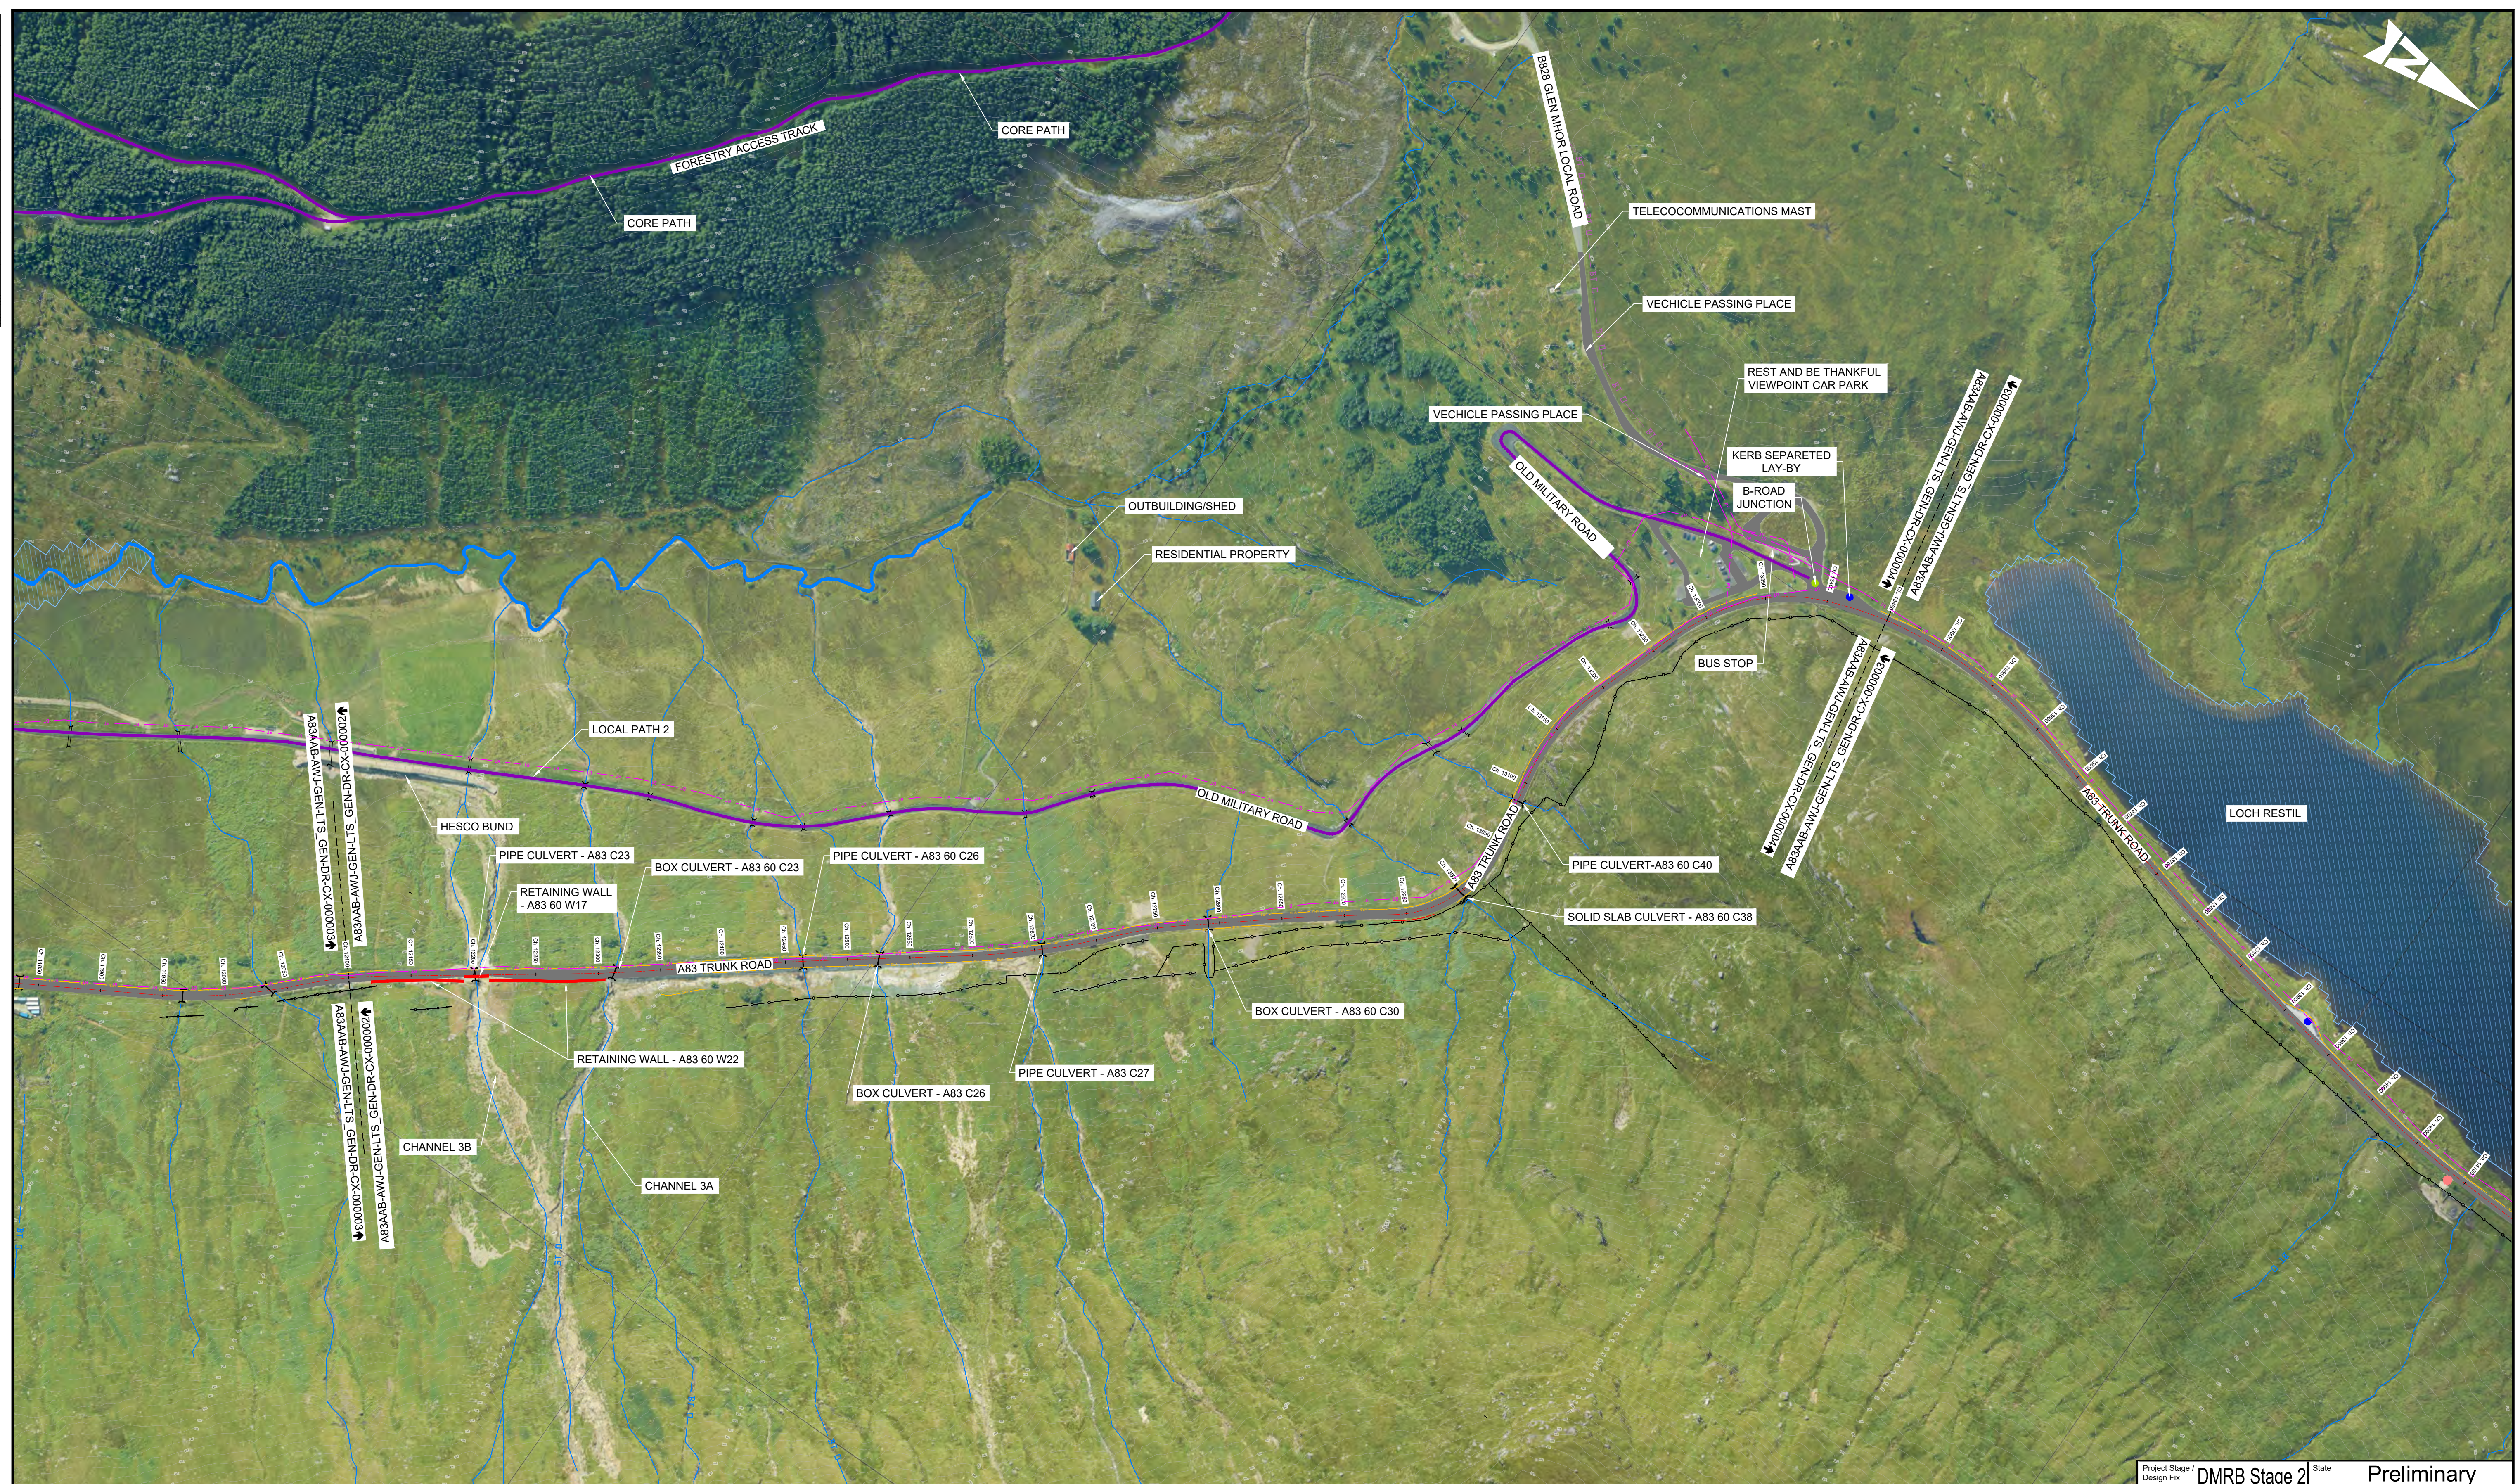
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Sheet: 2 of 4

Rev: P01

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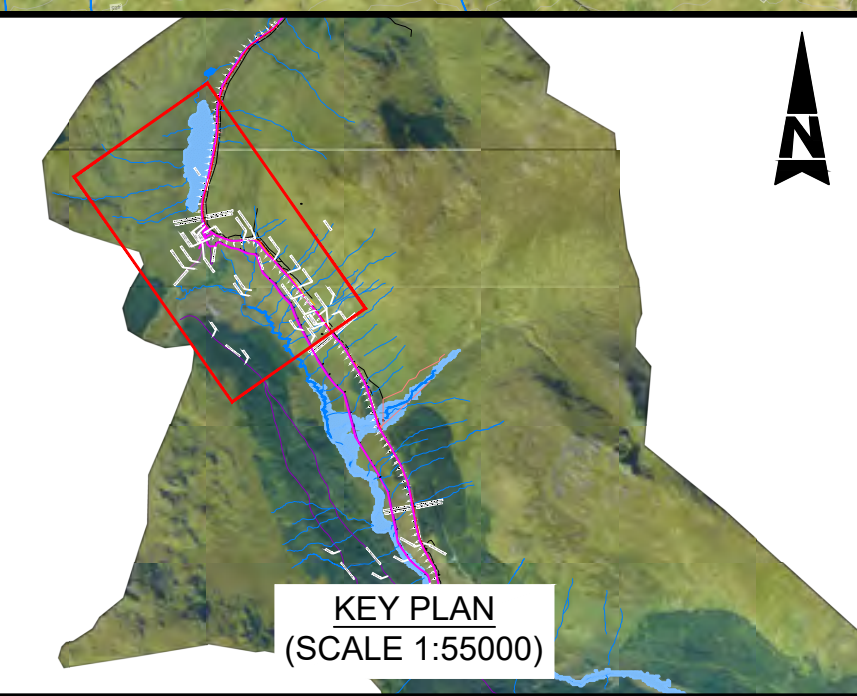
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NOTES:
1. ALL DIMENSIONS SHOWN ARE IN METRES UNLESS STATED OTHERWISE.

KEY:

WATERCOURSES	ACCESS ROAD
SEPA FLOOD MAPPING (1 IN 200 YEAR)	B CLASS ROAD
CULVERT/WATERCOURSE STRUCTURES	LAY-BY
EXISTING INFRASTRUCTURE	RESIDENTIAL ACCESS
SUSTAINABLE TRAVEL FACILITIES	BT
BRIDGE	
RETAINING WALL	
FENCING	
ROCK FALL FENCING	
VEHICLE RESTRAINT SYSTEMS	



Description	Status	Revision	Drawn	Checked	Reviewed	Authorised	Issue Date
Stage 2 Issue	S4	P01	PW	SL	CS	RHG	31/05/23

Project Stage / Design File		DMRB Stage 2		State		Preliminary	
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Sheet		3 of 4		Rev: P01			

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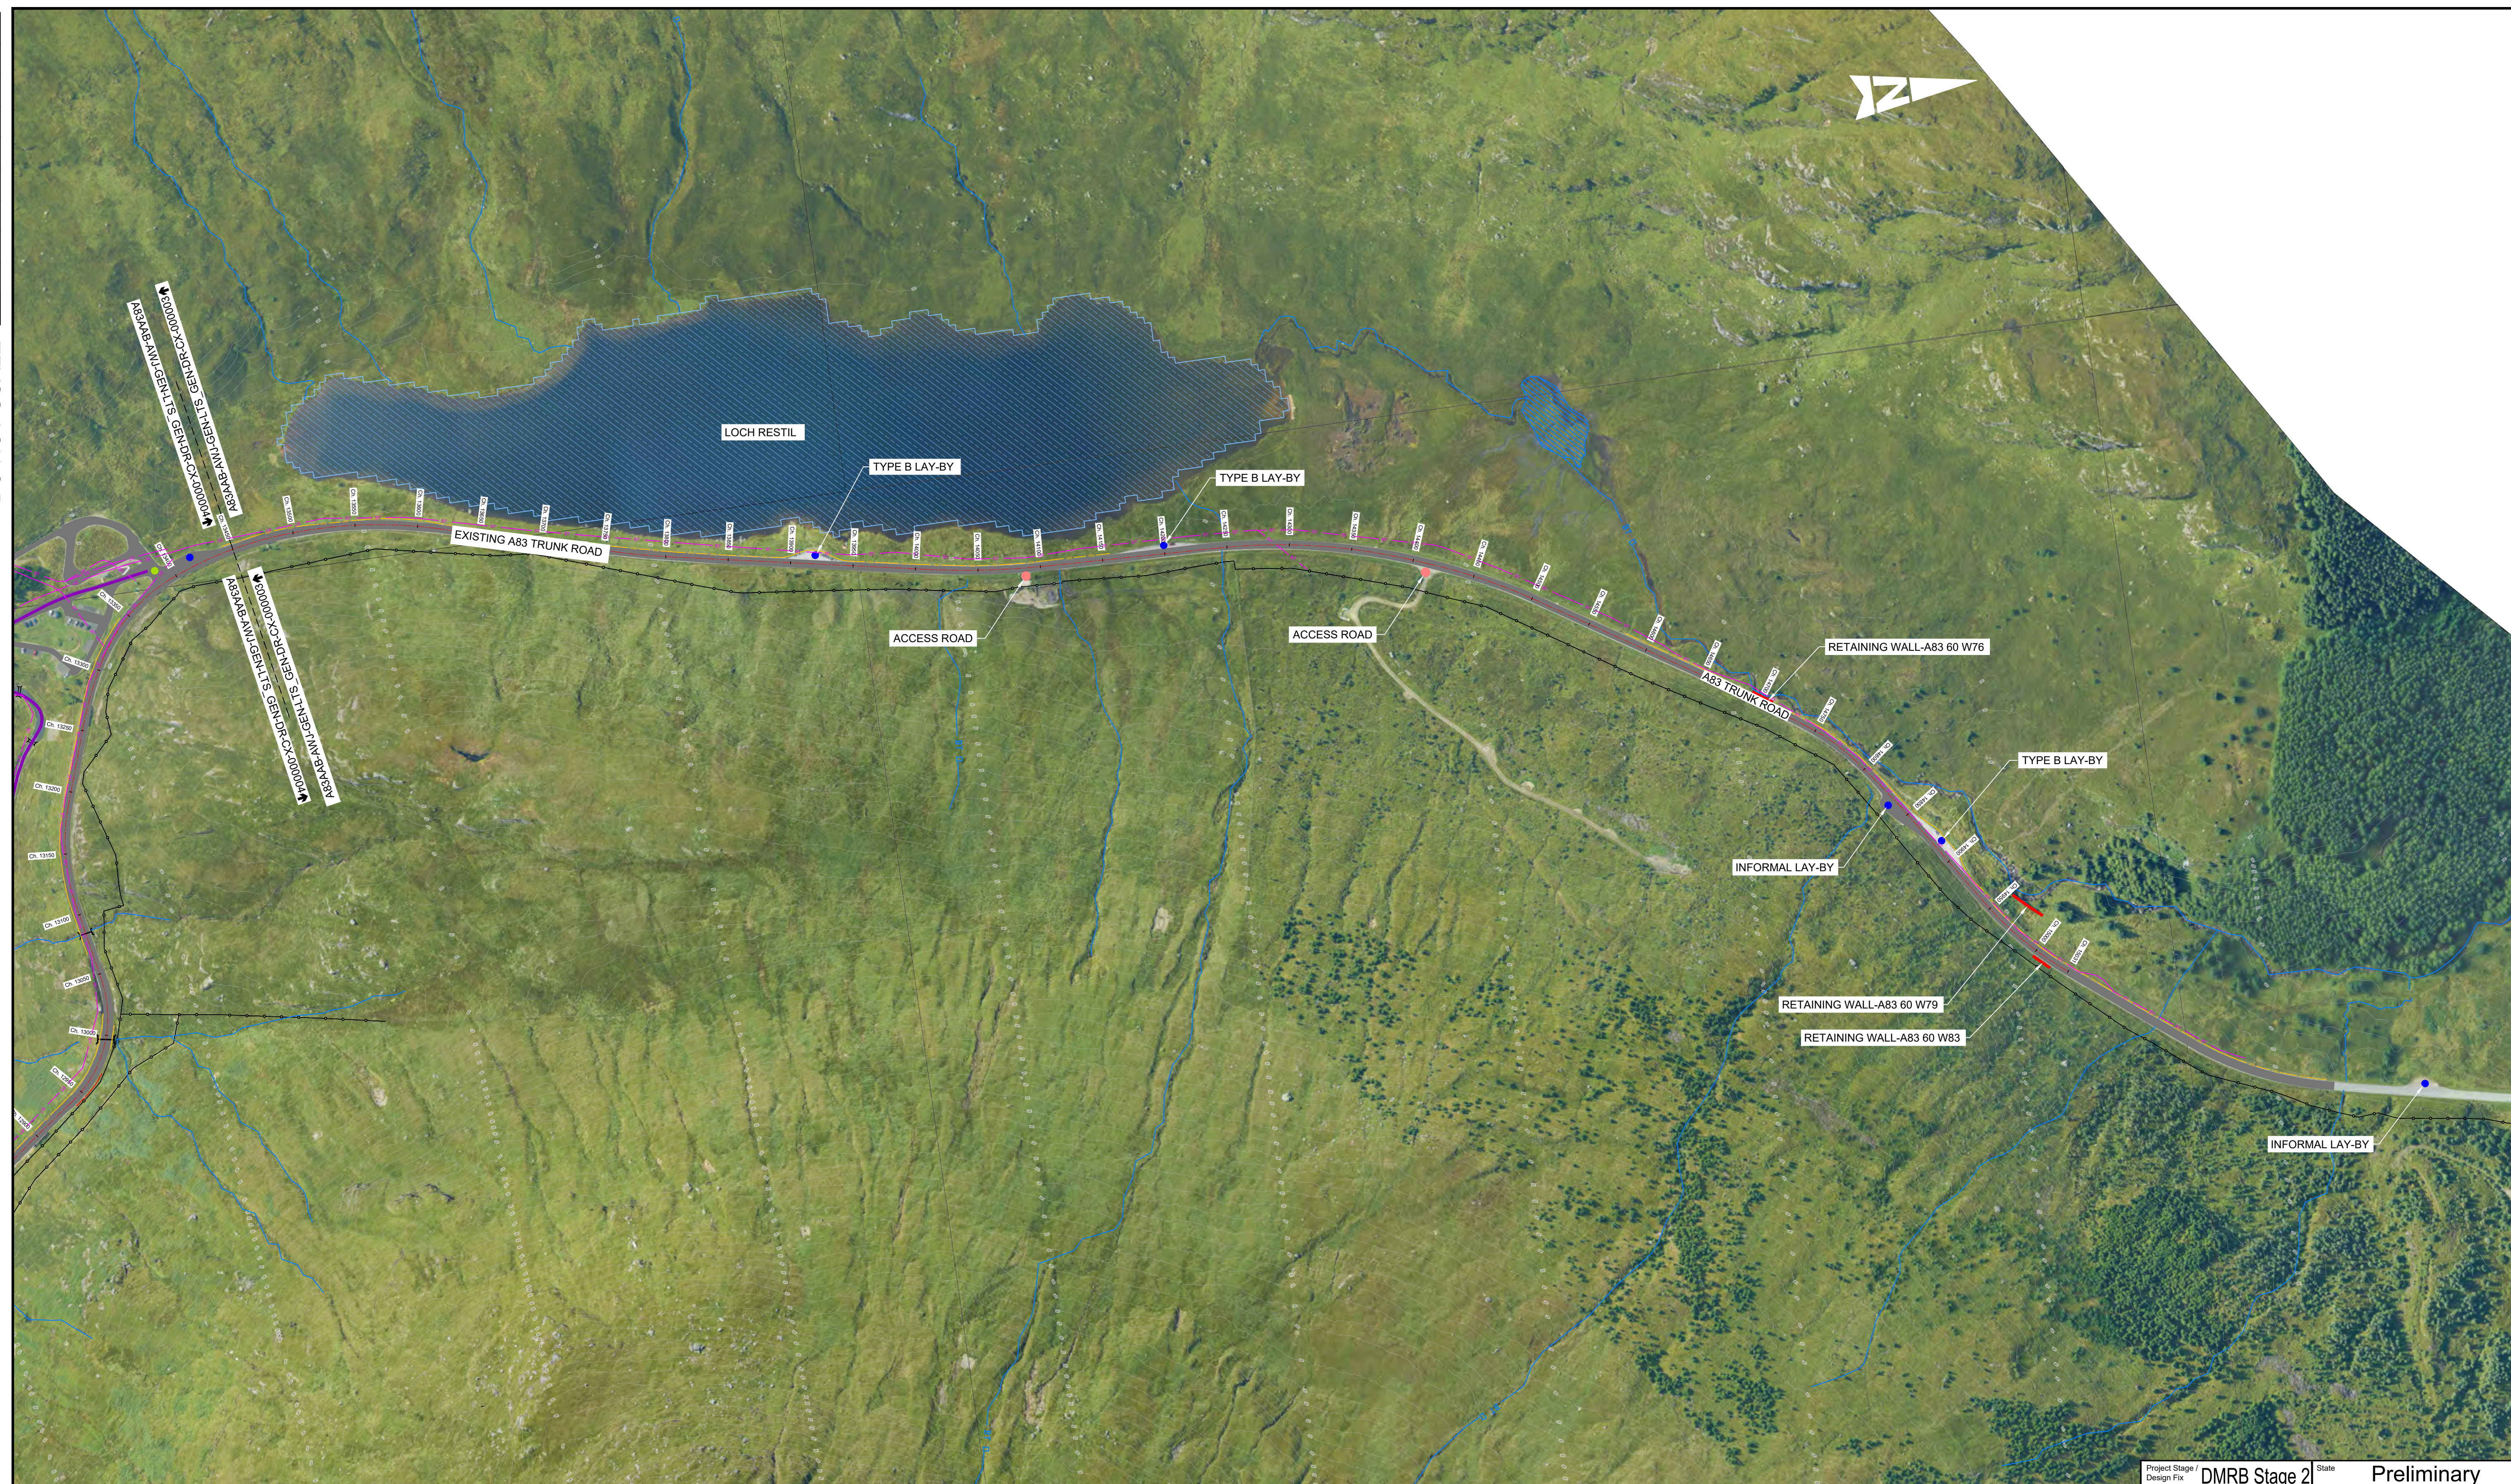
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TRANSPORT SCOTLAND
COMHDAIL ALBA

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Description							
Status		S4		Drawing Suitability		FOR STAGE APPROVAL	
Description							
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Description							

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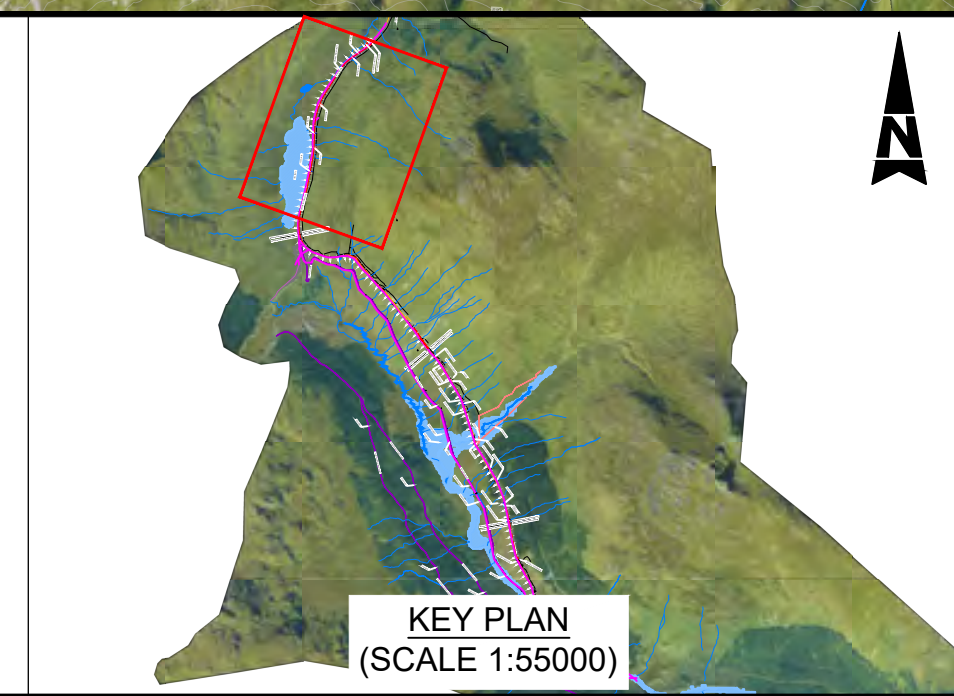
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NOTES:
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KEY:

WATERCOURSES	ACCESS ROAD
SEPA FLOOD MAPPING (1 IN 200 YEAR)	B CLASS ROAD
CULVERT/WATERCOURSE STRUCTURES	LAY-BY
EXISTING INFRASTRUCTURE	RESIDENTIAL ACCESS
SUSTAINABLE TRAVEL FACILITIES	BT
BRIDGE	
RETAINING WALL	
FENCING	
ROCK FALL FENCING	
VEHICLE RESTRAINT SYSTEMS	



Description	Status	Revision	Drawn	Checked	Reviewed	Authorised	Issue Date
	S4	P01	PW	SL	CS	---	31/05/23

Status: S4 Drawing Suitability: FOR STAGE APPROVAL

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Project Stage / Design File: DMRB Stage 2	State: Preliminary
Project Title: A83 AAB	
Drawing Title: EXISTING CONDITIONS PLAN	
Drawing Number: A83AAB - AWJ - GEN - LTS_GEN - DR-CX-000004	Originator: AWJ
Project: A83AAB - AWJ - GEN - LTS_GEN - DR-CX-000004	Volume: 4 of 4
Location: A83 TRUNK ROAD	Client: TRANSPORT SCOTLAND
Original Size: A1	Scale: 1:2500
Project Ref. No.: 6204594	Sheet: 4 of 4
Rev: P01	

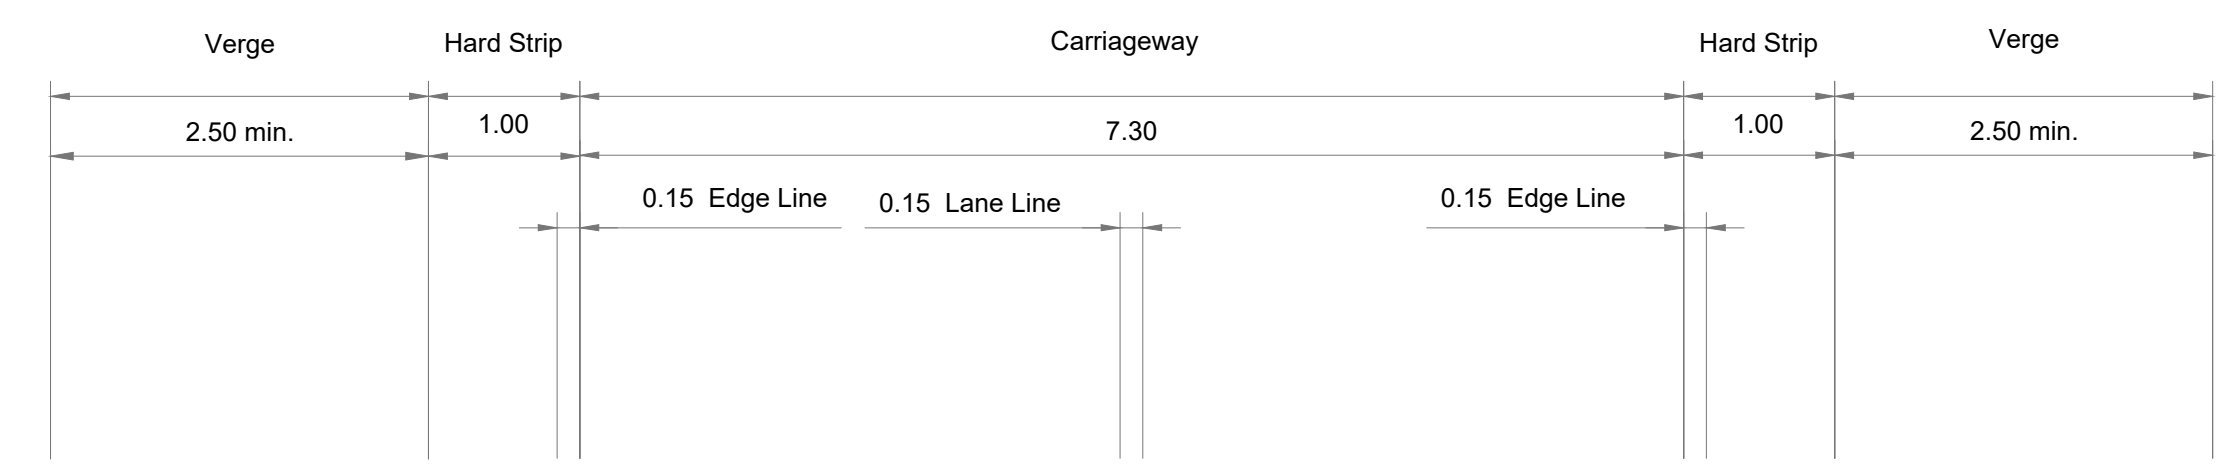
2. Typical Cross Sections

[A83AAB-AWJ-HGN-LTS_GEN-DR-CH-000001_P01.pdf](#) – Typical Mainline Cross Sections

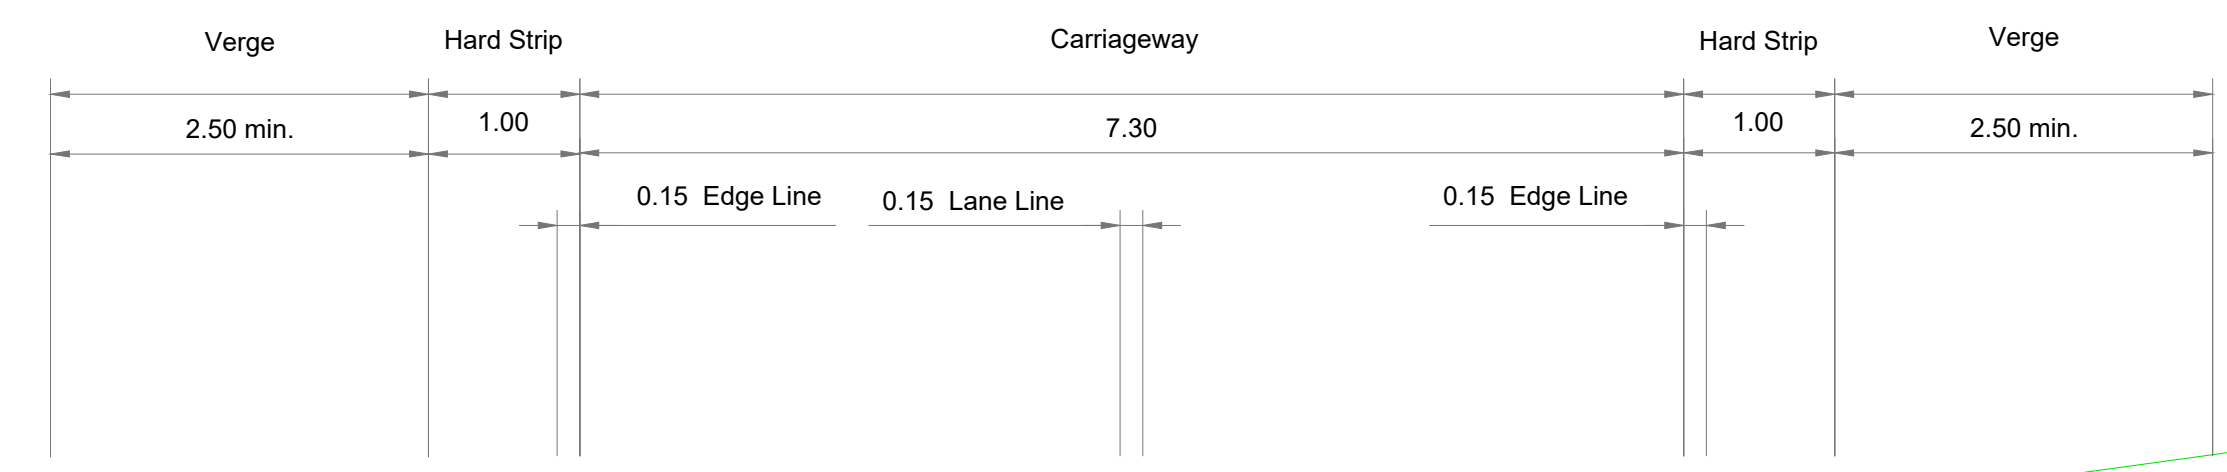
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**TYPICAL CARRIAGEWAY CROSS SECTION
FILL**



**TYPICAL CARRIAGEWAY CROSS SECTION
CUT & FILL**

NOTES:

1. ALL DIMENSIONS SHOWN ARE IN METRES UNLESS STATED OTHERWISE .

Description	Status	Revision	Drawn	Checked	Reviewed	Authorised	Issue Date
Description	S4						
Description	S4	P01	ME	AB	CS	RHG	22/05/23

Status: **S4** Drawing Suitability: **FOR STAGE APPROVAL**



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Project Stage / Design File	DMRB Stage 2	State	Preliminary
Project Title	A83 AAB		
Drawing Title	TYPICAL CROSS SECTIONS		
Drawing Number	A83AAB	Originator	AWJ
Project	LTS_GEN	Volume	HGN - DR-CH-000001
Location		Type	
Original Size	A1	Scale	1:50
Project Ref. No.	6204594	Sheet	1 of 1
		Rev.	P01

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3. Mainline Plan and Profiles

Yellow Option

[A83AAB-AWJ-HML-LTS_LB3-DR-CH-000001_P02.pdf](#) – Location Plan

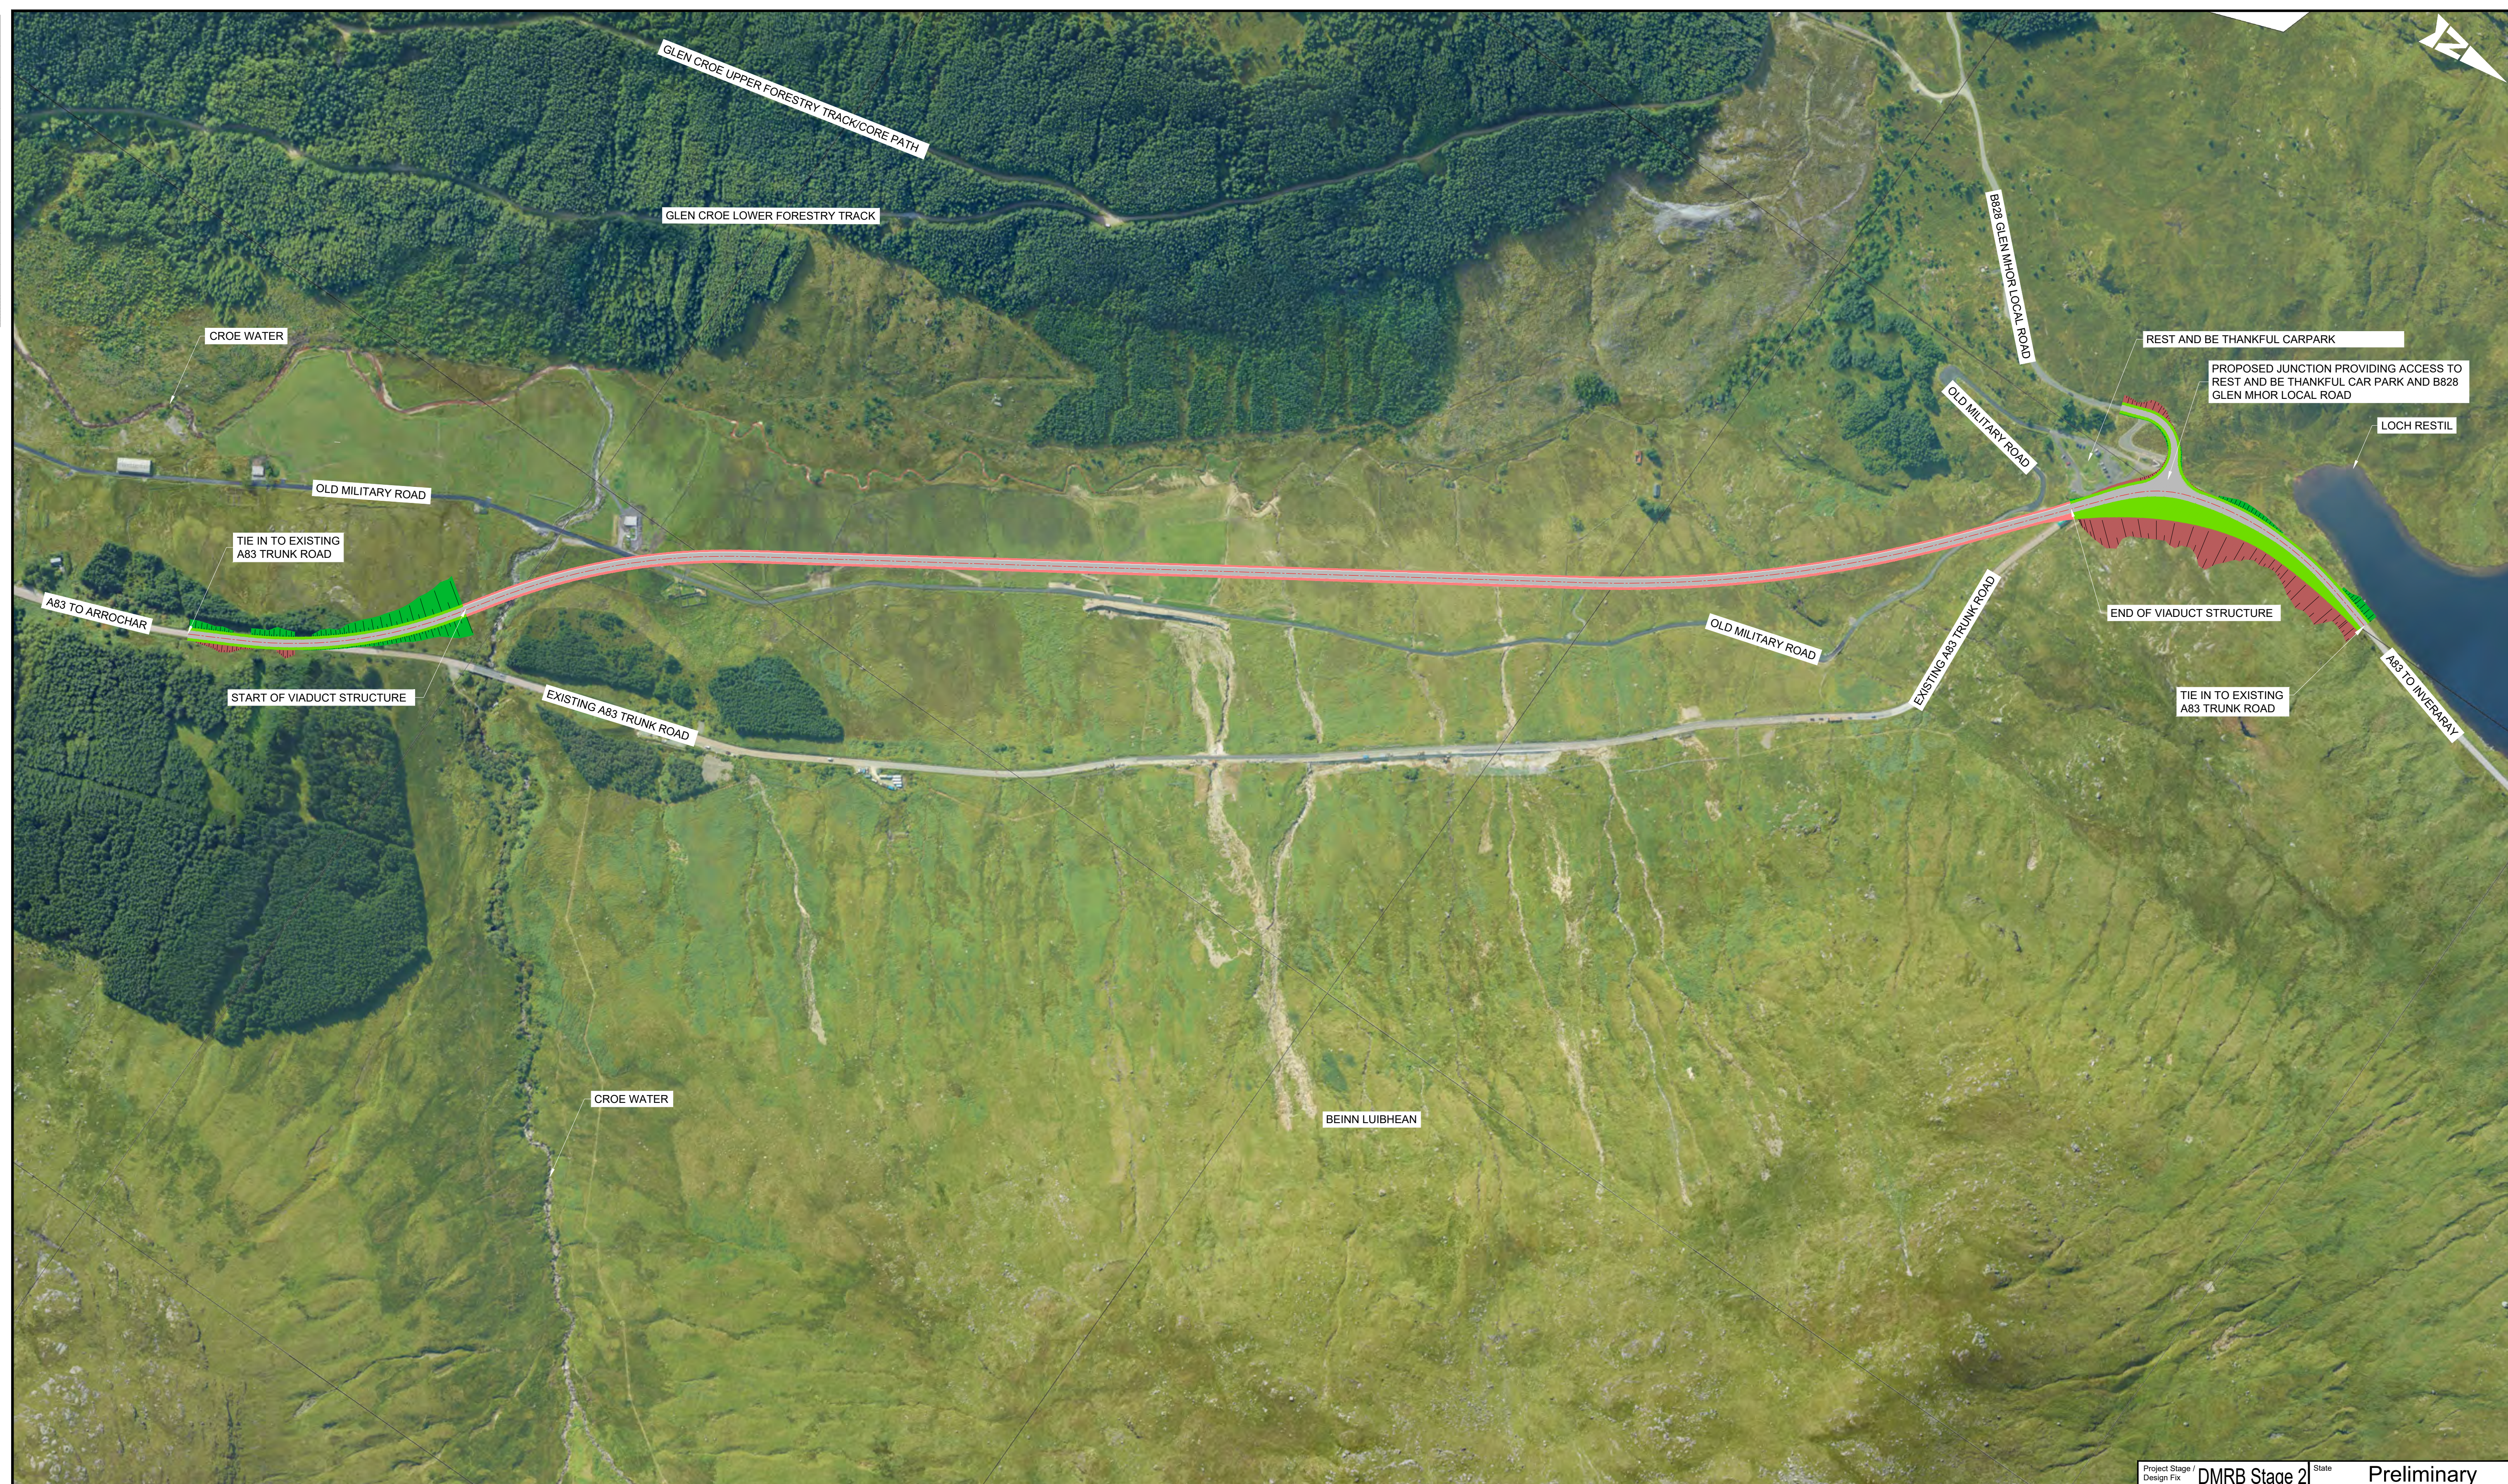
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[A83AAB-AWJ-HML-LTS_LB3-DR-CH-000003_P02.pdf](#) – Plan and Profile – Sheet 2 of 2

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NOTES:

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- ALL DESIGNS ARE PRELIMINARY AND HAVE BEEN DEVELOPED FOR COMPARATIVE ASSESSMENT PURPOSES AT DMRB STAGE 2 ONLY.

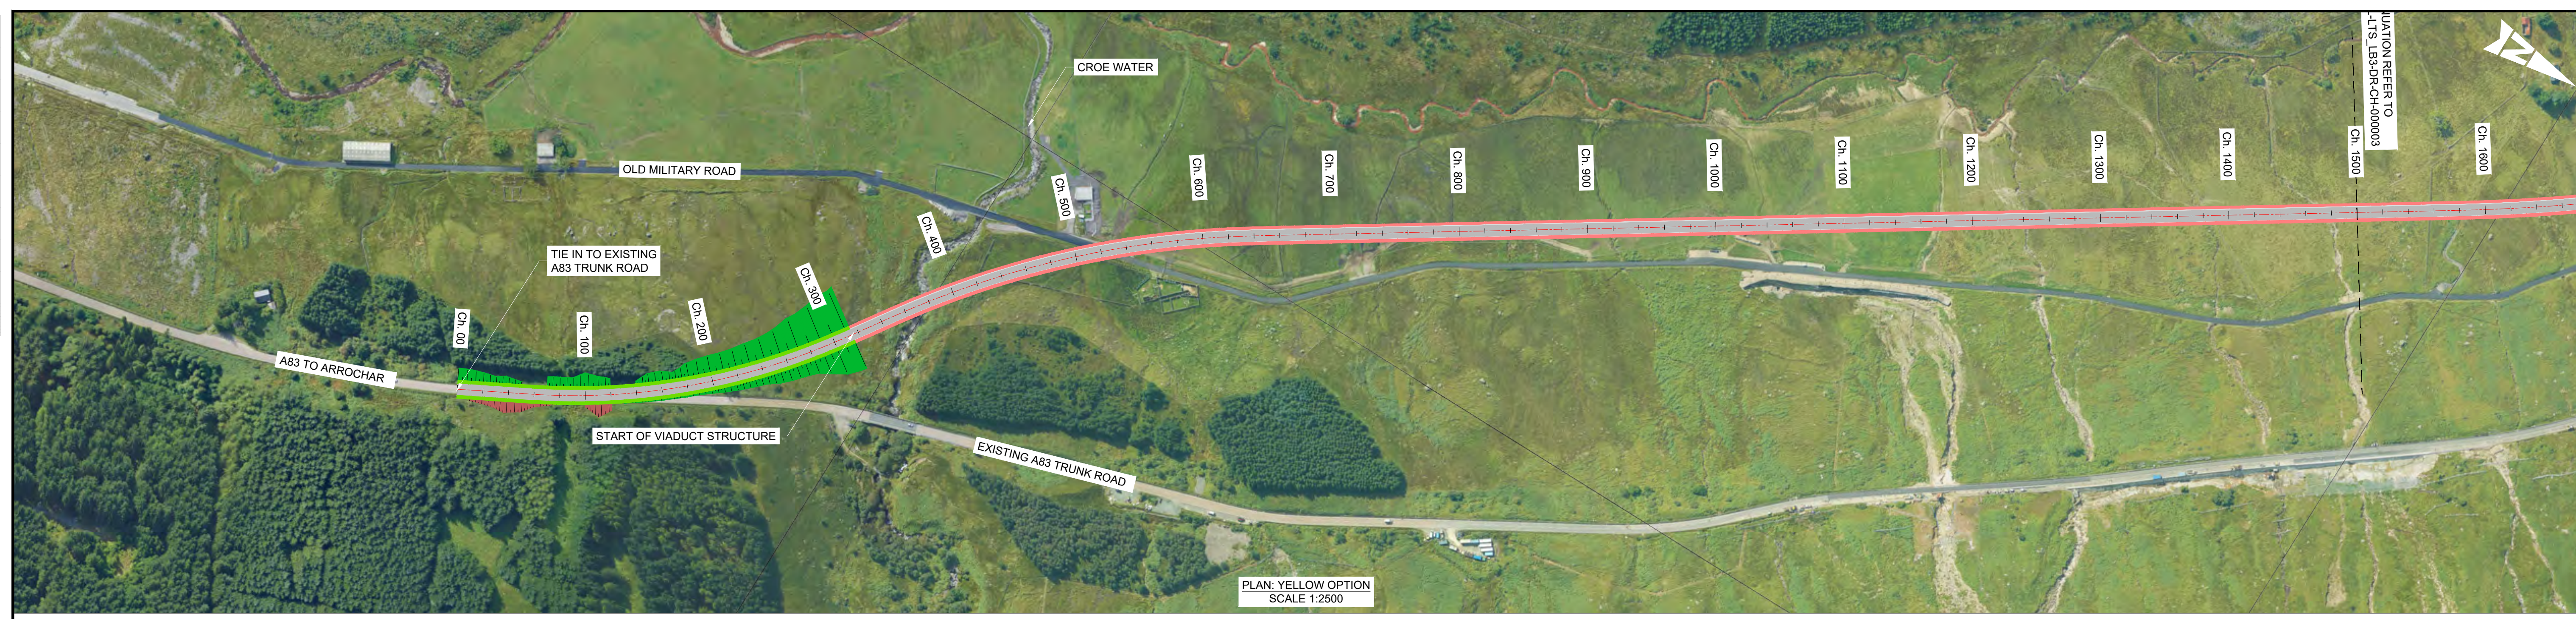
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PROPOSED ALIGNMENT	PROPOSED DESIGN PROFILE
PROPOSED CARRIAGEWAY	EXISTING GROUND PROFILE
PROPOSED VERGE	
PROPOSED FOOTWAY	
PROPOSED KERBS	

Description						
Status	Revision	Drawn	Checked	Reviewed	Authorised	Issue Date
S4						22/05/23
Description						
Status	Revision	Drawn	Checked	Reviewed	Authorised	Issue Date
S3	P01	VR	BM	CS	IA	10/02/23
Description						
Status	Revision	Drawn	Checked	Reviewed	Authorised	Issue Date
S4	P02		BM	CS	IA	22/05/23

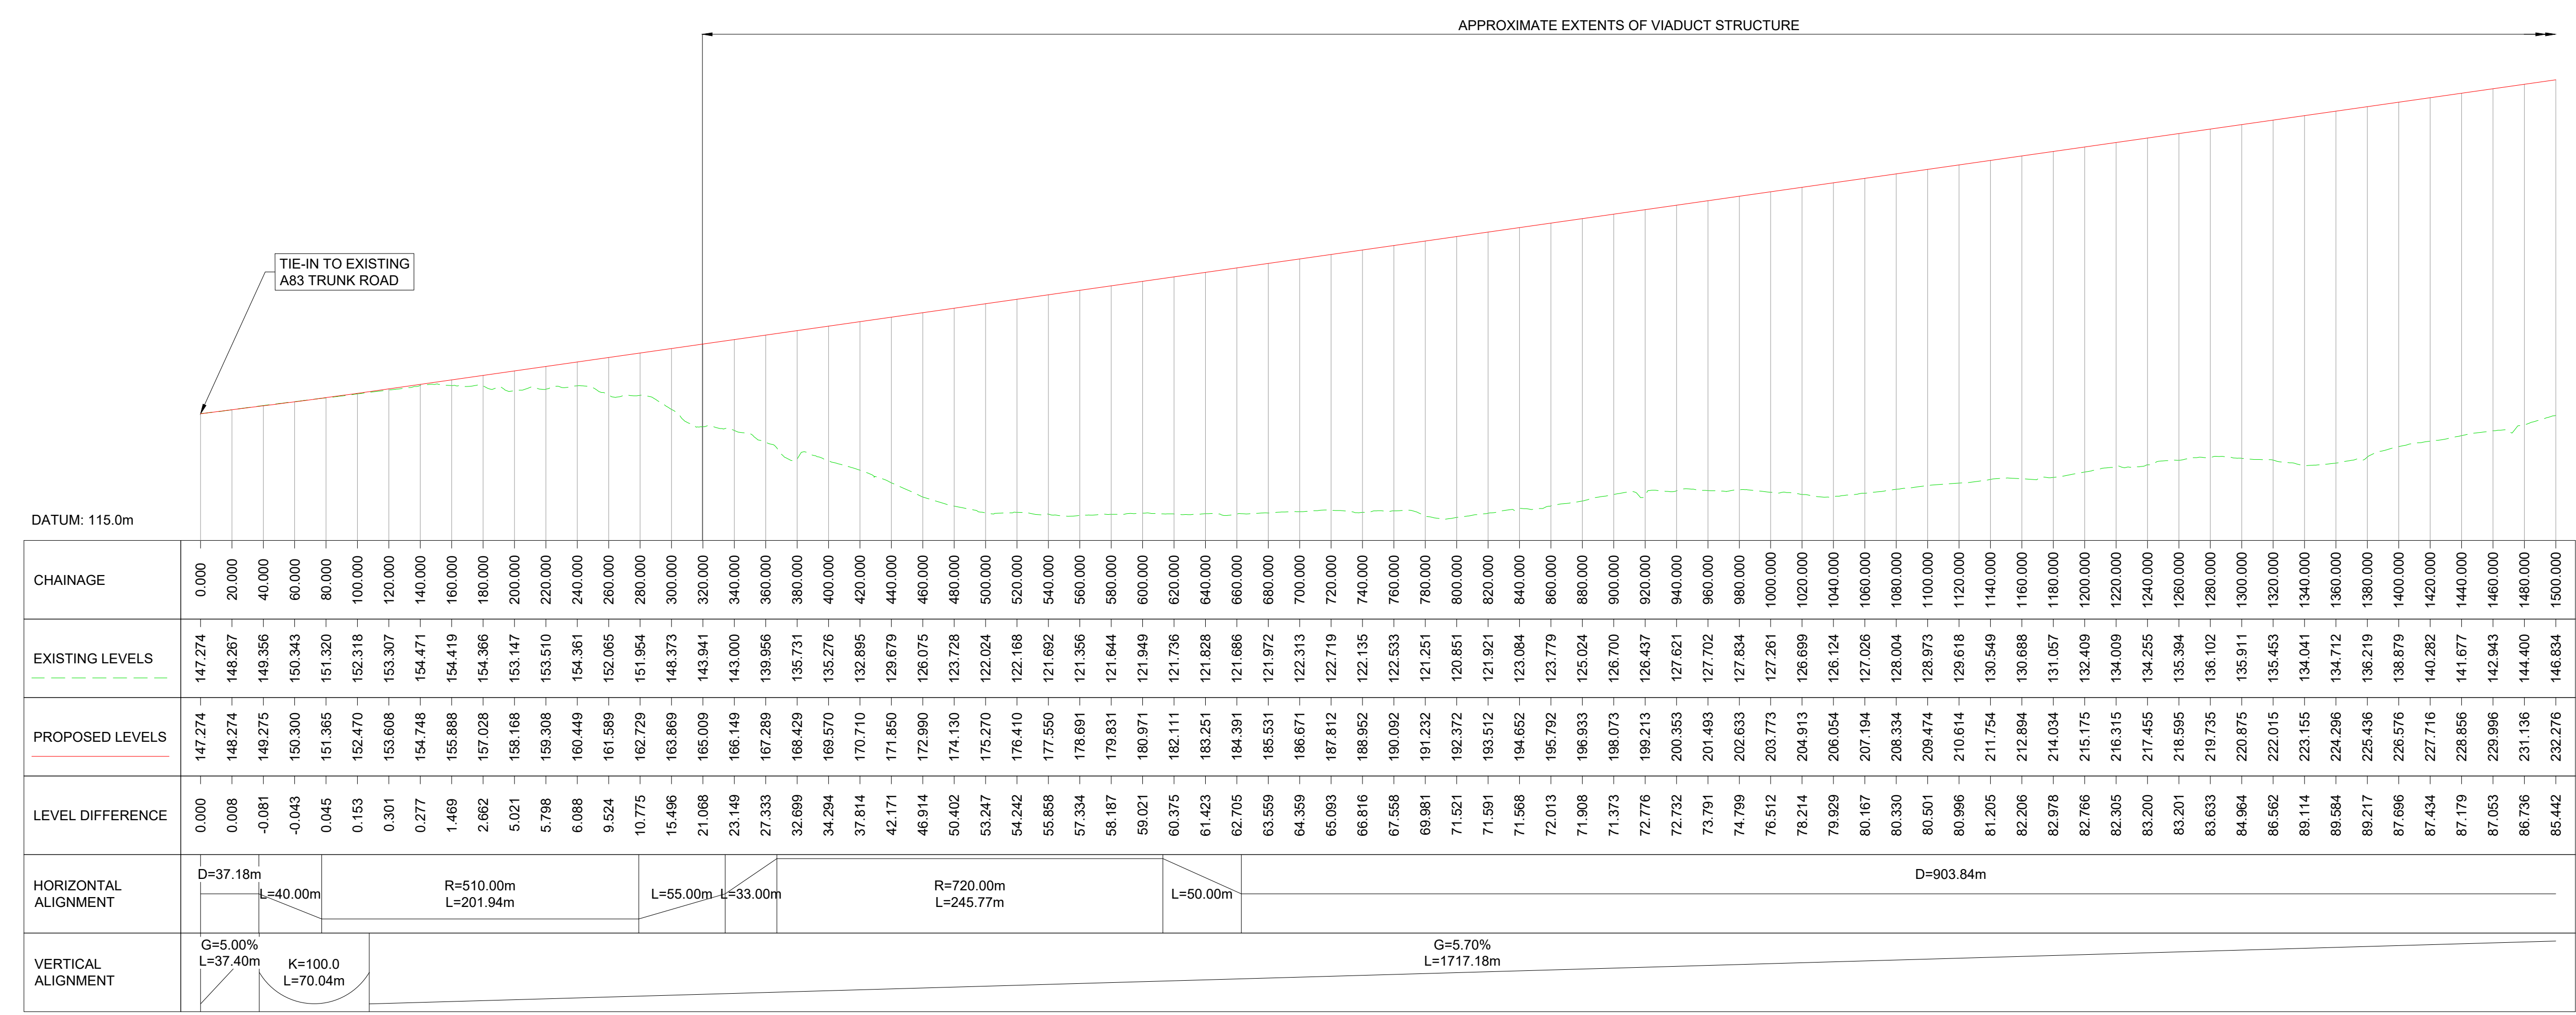
Status	Drawing Suitability
S4	FOR STAGE APPROVAL
 Member of the SNC-Lavalin Group	
 COMHDAIL ALBA	

Project Stage / Design File	DMRB Stage 2	State	Preliminary
Project Title	A83 AAB		
Drawing Title	YELLOW OPTION LOCATION PLAN		
Drawing Number	Project	Originator	Volume
A83AAB	A83AAB - AWJ - HML - LTS_LB3	- DR-CH-000001	
Location	Type	Role	Number
A1	Scale: NTS	Project Ref. No.: 6204594	Sheet: 1 of 1 Rev: P02

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SCALE 1:2500



PROFILE: YELLOW OPTION
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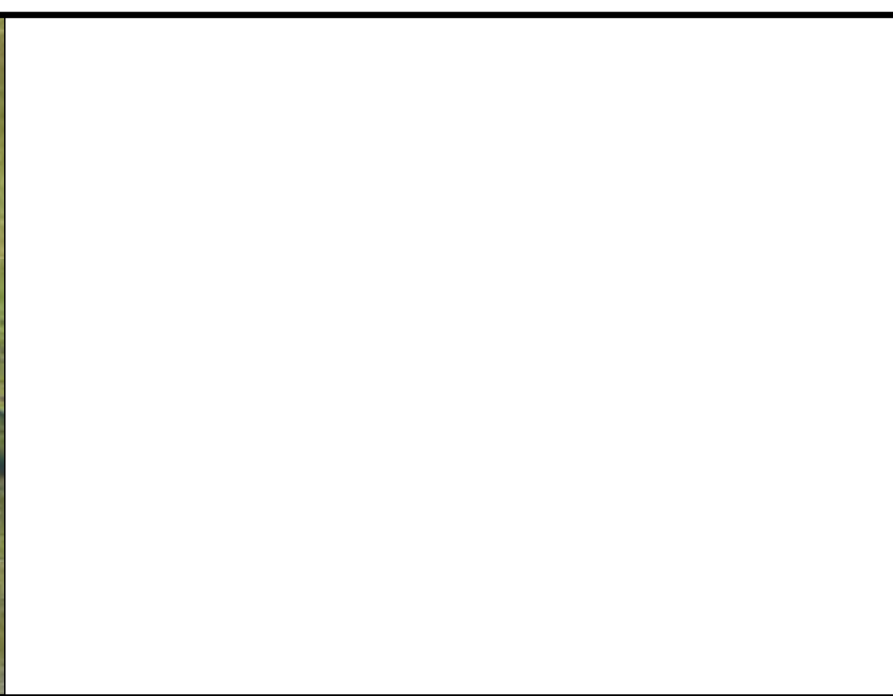
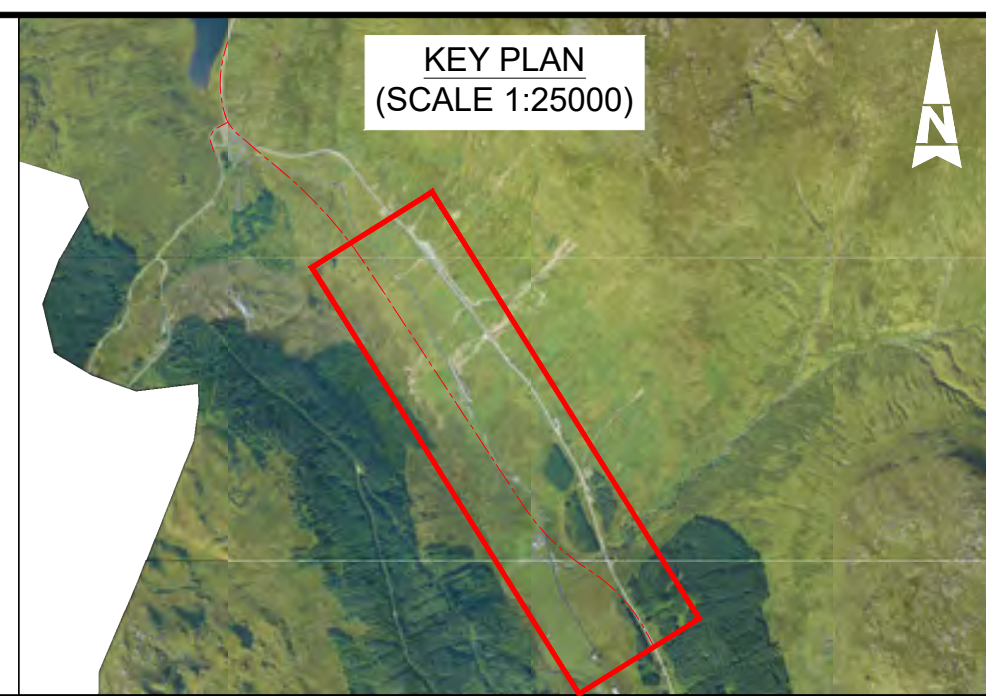
- ALL DIMENSIONS SHOWN ARE IN METRES UNLESS STATED OTHERWISE.
- ALL DESIGNS ARE PRELIMINARY AND HAVE BEEN DEVELOPED FOR COMPARATIVE ASSESSMENT PURPOSES AT DMRB STAGE 2 ONLY.

KEY - PLAN:

- PROPOSED ALIGNMENT
- PROPOSED CARRIAGEWAY
- PROPOSED VERGE
- PROPOSED FOOTWAY
- PROPOSED KERBS
- PROPOSED EARTHWORK EMBANKMENT
- PROPOSED EARTHWORK CUTTING

KEY - PROFILE:

- PROPOSED DESIGN PROFILE
- EXISTING GROUND PROFILE



Description	Status	Revision	Drawn	Checked	Reviewed	Authorised	Issue Date
First Issue	S3	P01	VR	BM	CS	IA	10/02/23
Stage 2 Issue	S4	P02		BM	CS	IA	22/05/23

Status: **S4** Drawing Suitability: **FOR STAGE APPROVAL**

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Client: **TRANSPORT SCOTLAND**
COMHDHAIL ALBA

Project Stage / Design File: **DMRB Stage 2** State: **Preliminary**

Project Title: **A83 AAB**

Drawing Title: **YELLOW OPTION PLAN AND PROFILE**

Drawing Number: **A83AAB - AWJ - HML - LTS_LB3 - DR-CH-000002**

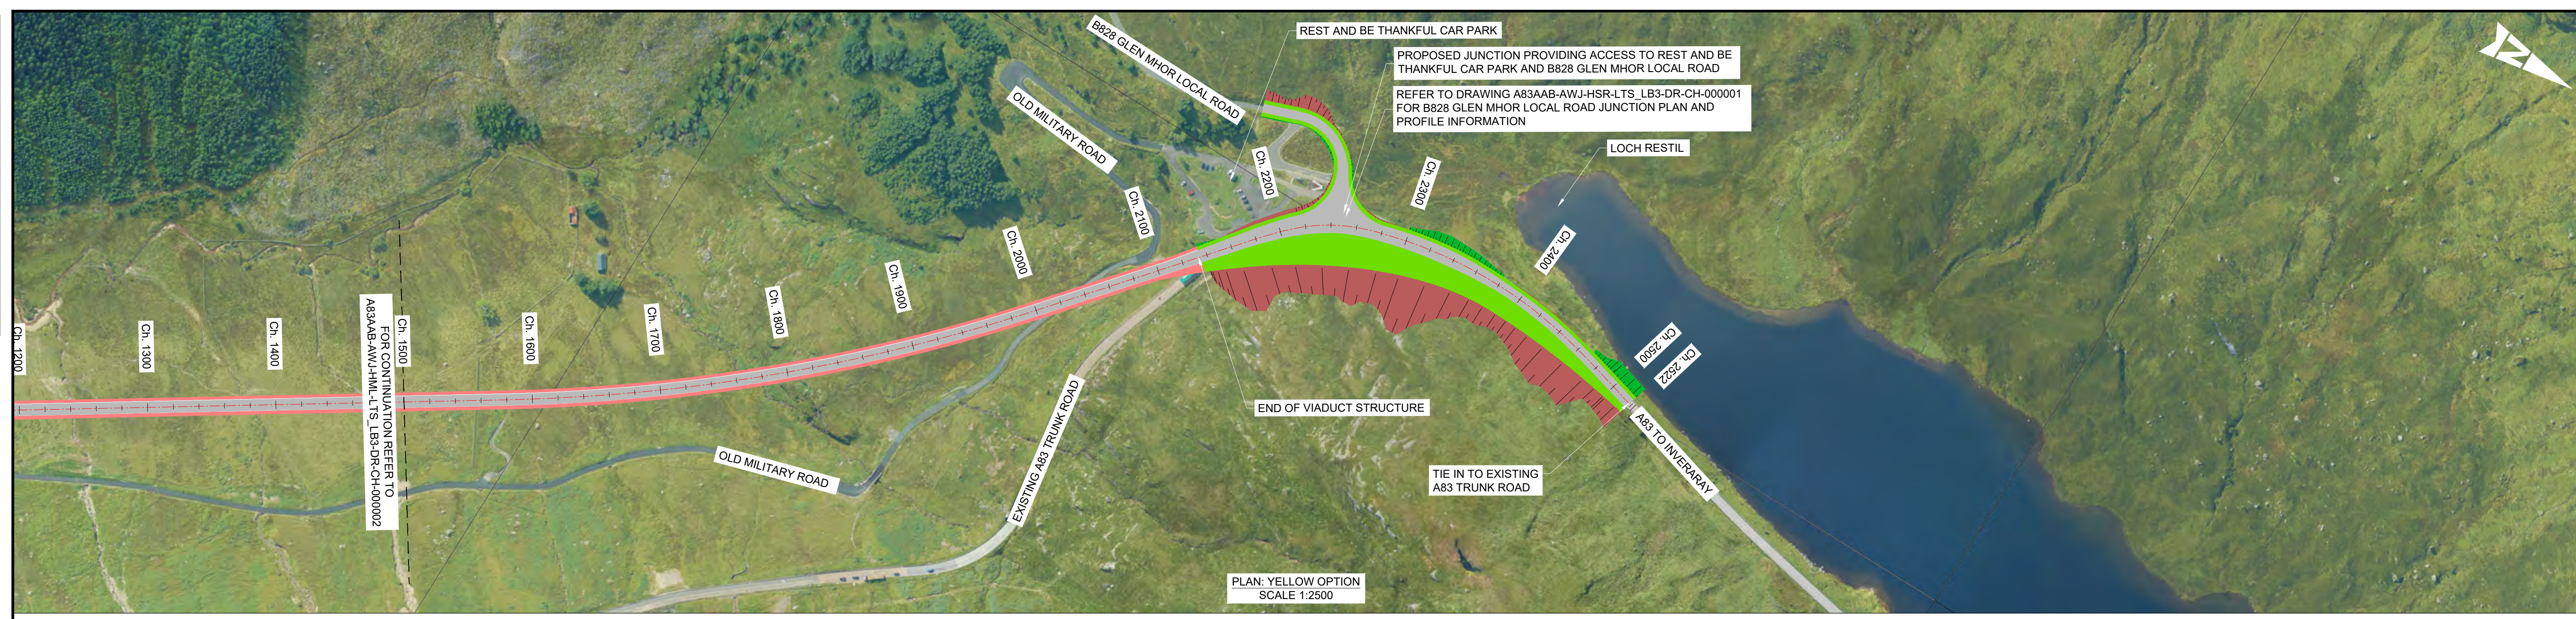
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Location: **LTS_LB3** Type: **DR** Role: **CH** Number: **000002**

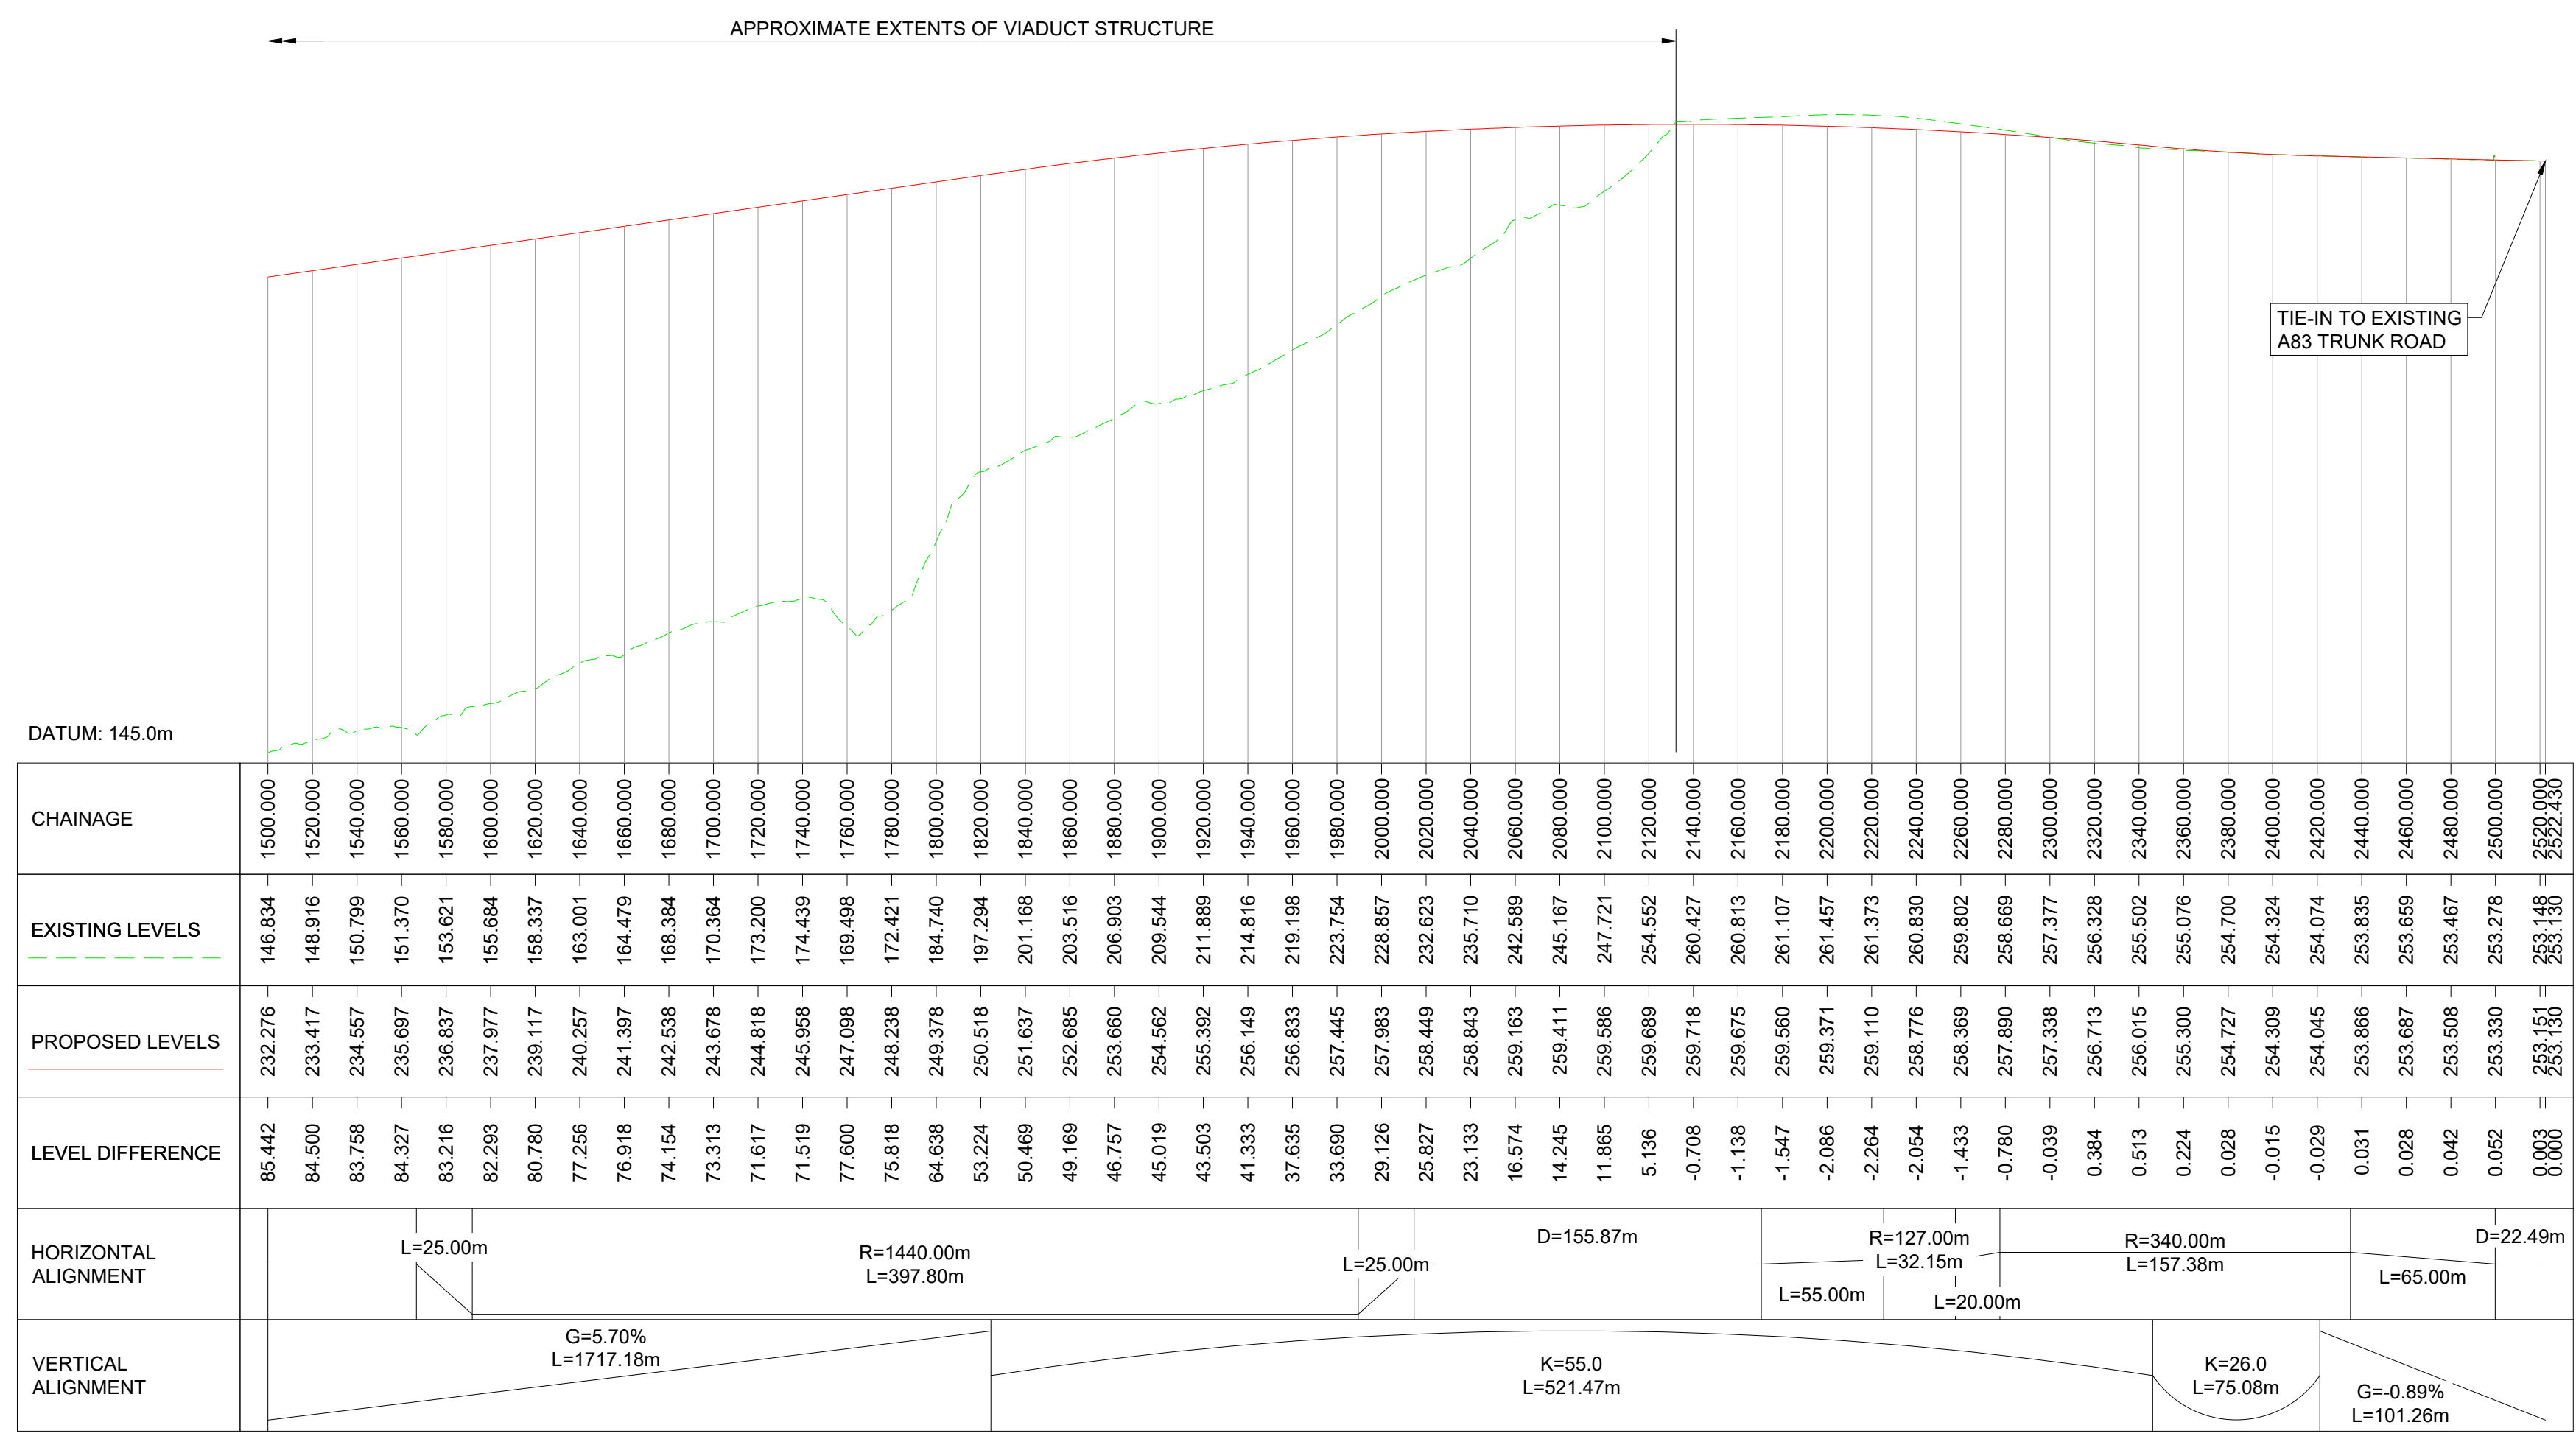
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PLAN: YELLOW OPTION
SCALE 1:2500



PROFILE: YELLOW OPTION
SCALE: H 1:2500, V 1:1000

NOTES:

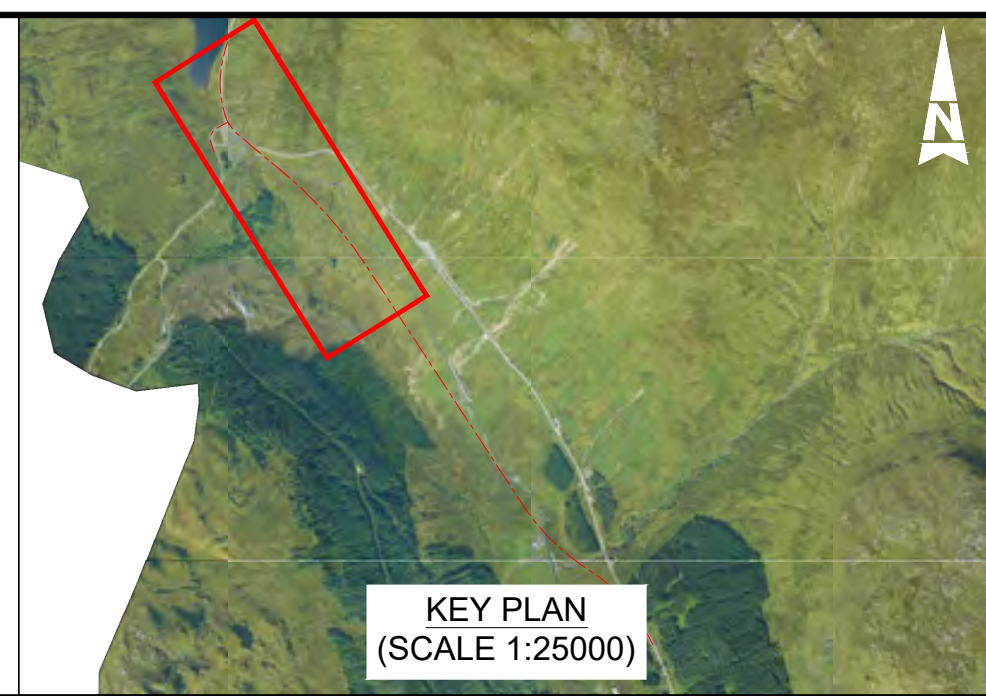
- ALL DIMENSIONS SHOWN ARE IN METRES UNLESS STATED OTHERWISE.
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KEY - PLAN:

- PROPOSED ALIGNMENT
- PROPOSED CARRIAGEWAY
- PROPOSED VERGE
- PROPOSED FOOTWAY
- PROPOSED KERBS
- PROPOSED EARTHWORK EMBANKMENT
- PROPOSED EARTHWORK CUTTING

KEY - PROFILE:

- PROPOSED DESIGN PROFILE
- EXISTING GROUND PROFILE



Description	Status	Revision	Drawn	Checked	Reviewed	Authorised	Issue Date
First Issue	S3	PO1	VR	BM	CS	IA	10/02/23
Stage 2 Issue	S4	PO2		BM	CS	IA	22/05/23

Status: S4 Drawing Suitability: FOR STAGE APPROVAL

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TRANSPORT SCOTLAND
COMHDAIL ALBA

Project Stage / Design File: DMRB Stage 2 Preliminary

Project Title: A83 AAB

Drawing Title: YELLOW OPTION PLAN AND PROFILE

Drawing Number: A83AAB - AWJ - HML - LTS_LB3 - DR-CH-000003

Originator: g204594

Scale: AS SHOWN

Project Ref. No.: g204594

Sheet: 2 of 2

Rev: P02

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Brown Option

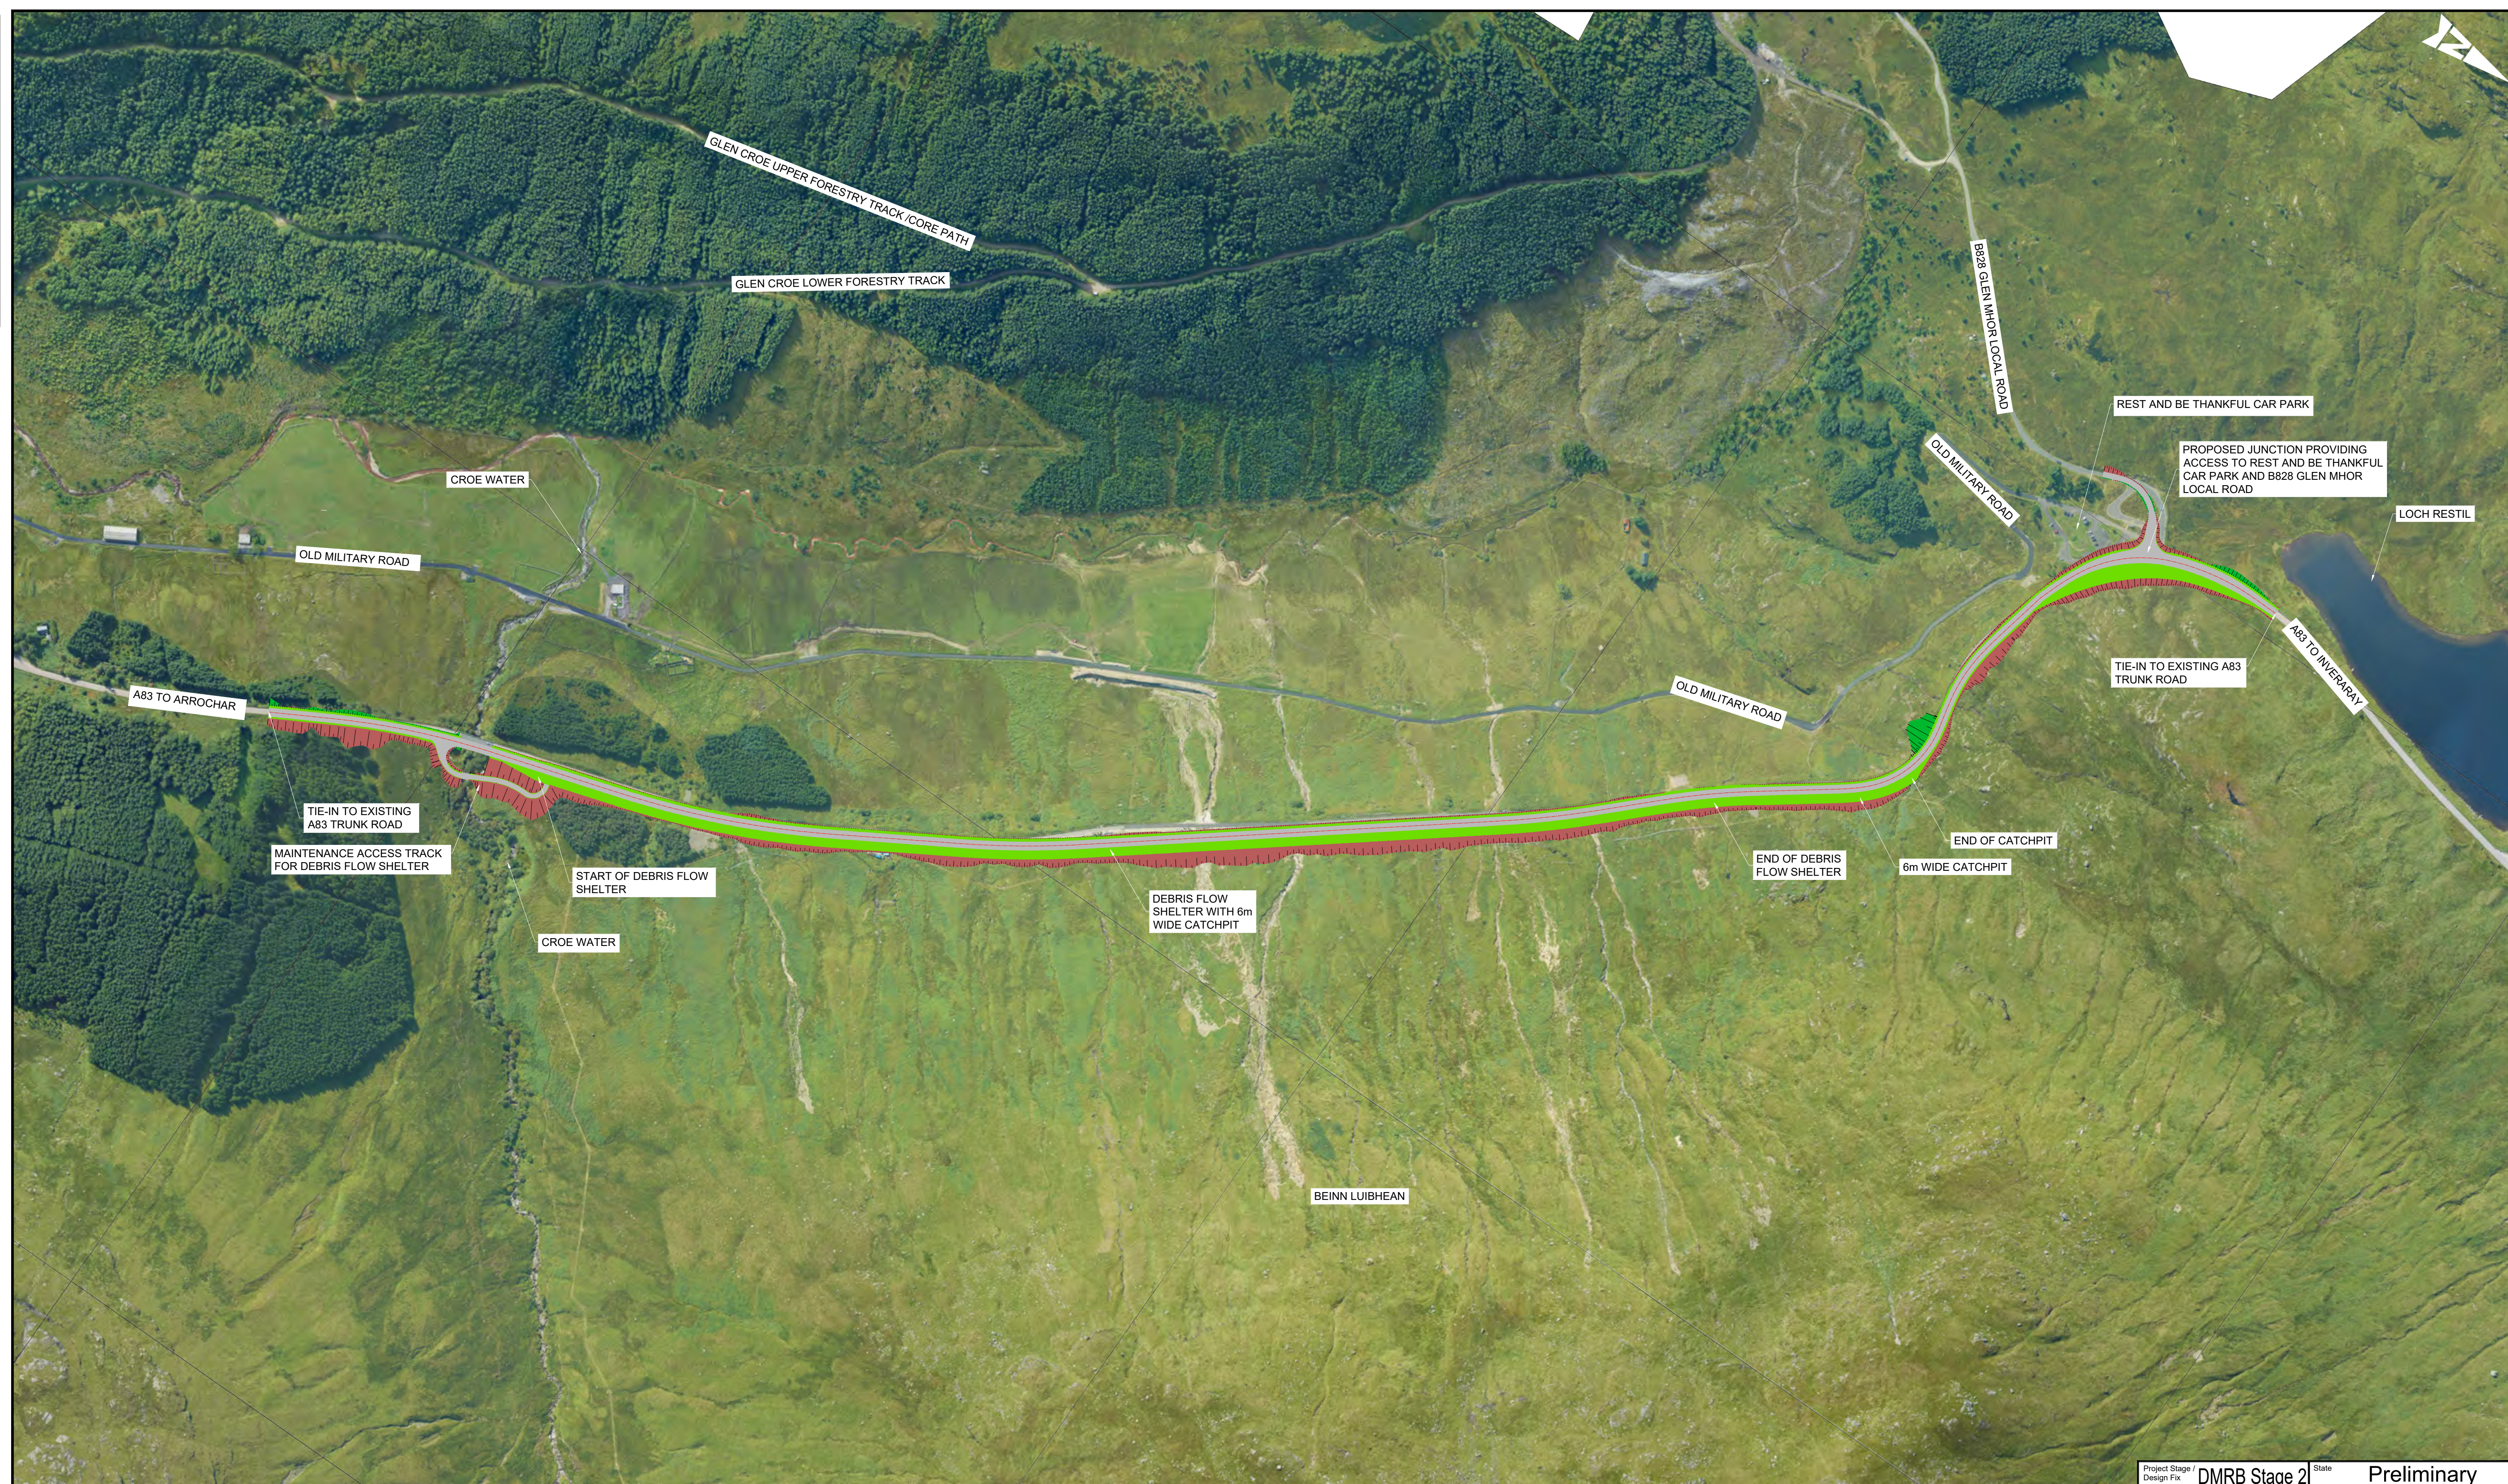
[A83AAB-AWJ-HML-LTS_LC3-DR-CH-000001_P02.pdf](#) – Location Plan

[A83AAB-AWJ-HML-LTS_LC3-DR-CH-000002_P02.pdf](#) – Plan and Profile – Sheet 1 of 2

[A83AAB-AWJ-HML-LTS_LC3-DR-CH-000003_P02.pdf](#) – Plan and Profile – Sheet 2 of 2

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- NOTES:**
- ALL DIMENSIONS SHOWN ARE IN METRES UNLESS STATED OTHERWISE .
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KEY - PLAN:		KEY - PROFILE:	
	PROPOSED ALIGNMENT		PROPOSED DESIGN PROFILE
	PROPOSED CARRIAGEWAY		EXISTING GROUND PROFILE
	PROPOSED VERGE		
	PROPOSED FOOTWAY		
	PROPOSED KERBS		
	PROPOSED EARTHWORK EMBANKMENT		
	PROPOSED EARTHWORK CUTTING		

Description	Status	Revision	Drawn	Checked	Reviewed	Authorised	Issue Date
First Issue	S3	P01	TT	SL	CS	IA	14/02/23
Stage 2 Issue	S4	P02		SL	CS	RHG	22/05/23

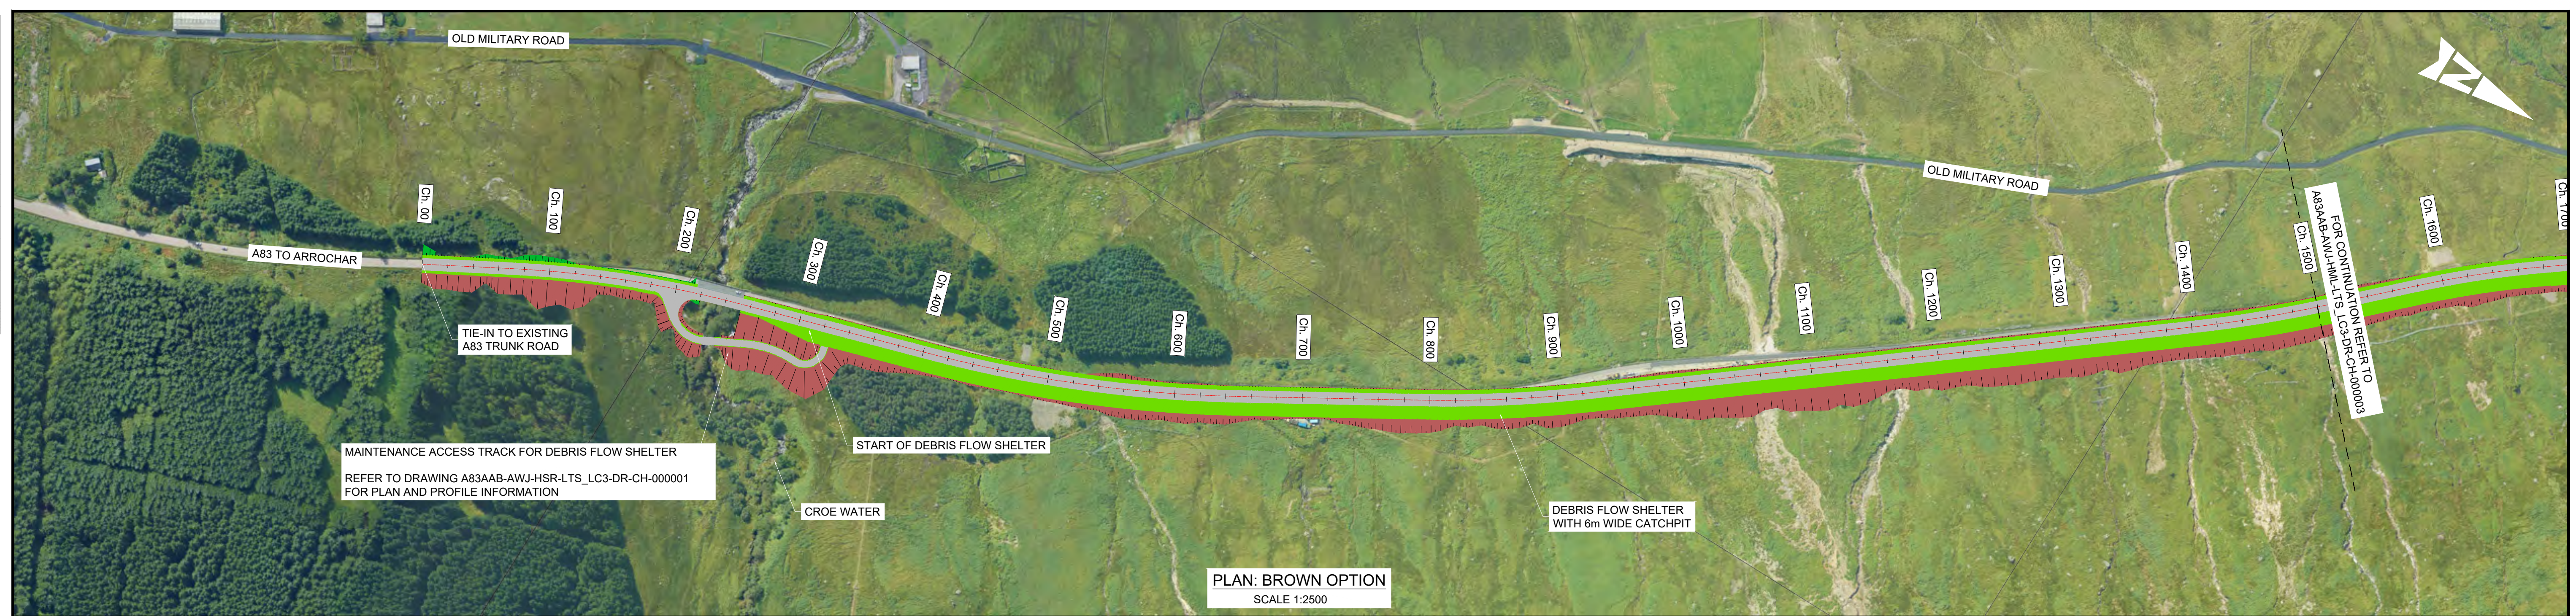
Status: S4
 Drawing Suitability: FOR STAGE APPROVAL

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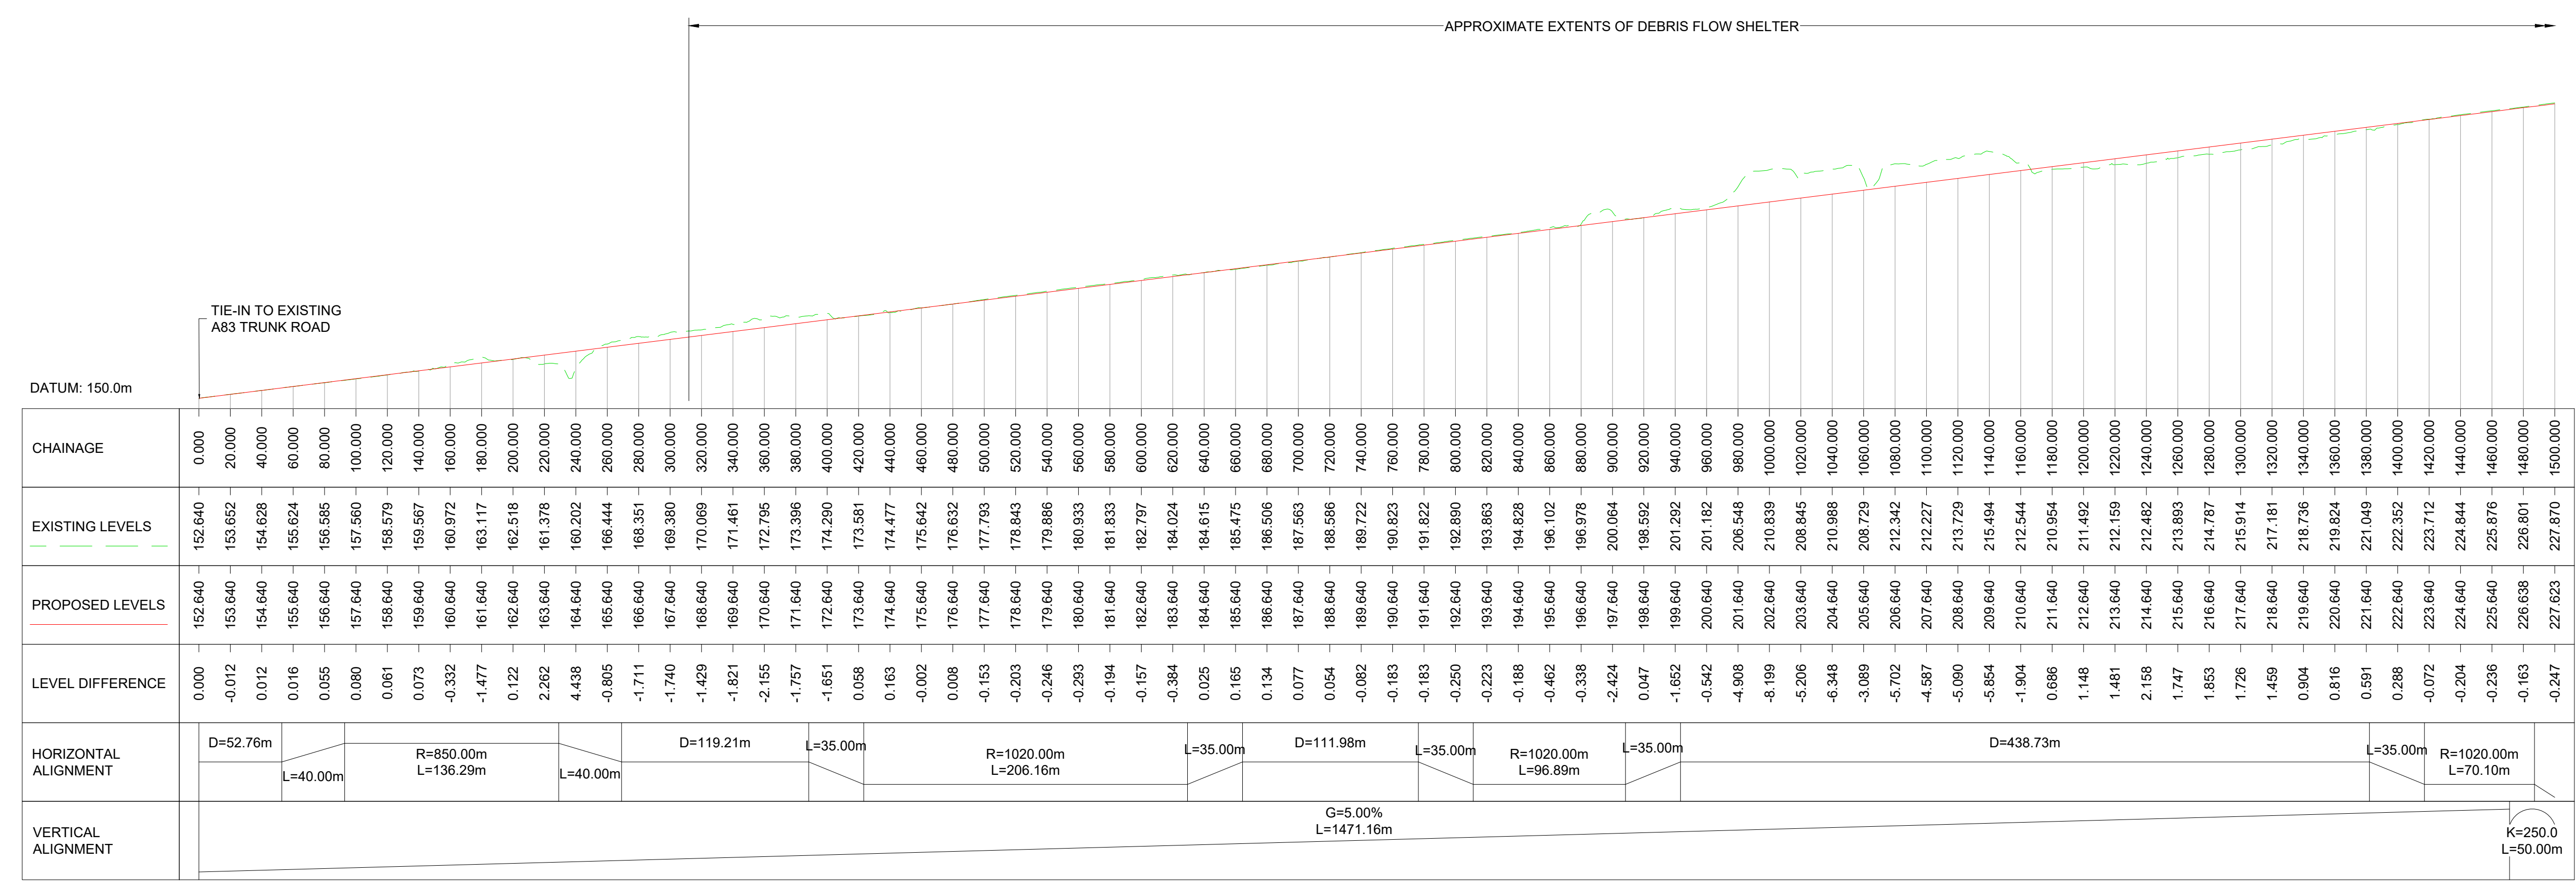
TRANSPORT SCOTLAND
 COMHDAIL ALBA

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Drawing Title: BROWN OPTION LOCATION PLAN	
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Project Ref. No.: g204594	Sheet: 1 of 1
	Rev: P02

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PLAN: BROWN OPTION
SCALE 1:2500



PROFILE: BROWN OPTION
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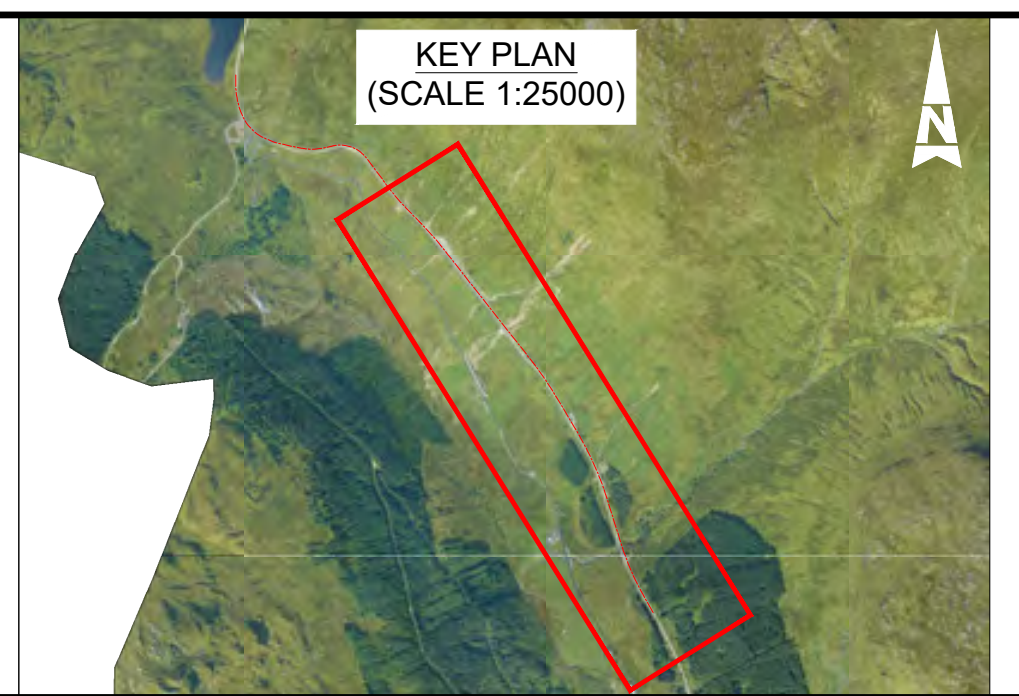
- NOTES:**
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KEY - PLAN:

- PROPOSED ALIGNMENT
- PROPOSED CARRIAGEWAY
- PROPOSED VERGE
- PROPOSED FOOTWAY
- PROPOSED KERBS
- PROPOSED EARTHWORK EMBANKMENT
- PROPOSED EARTHWORK CUTTING

KEY - PROFILE:

- PROPOSED DESIGN PROFILE
- EXISTING GROUND PROFILE



Description	Status	Revision	Drawn	Checked	Reviewed	Authorised	Issue Date
First Issue	S3	P01	TT	SL	CS	IA	14/02/23
Stage 2 Issue	S4	P02		SL	CS	RHG	22/05/23

Status: S4 Drawing Suitability: FOR STAGE APPROVAL

ATKINS **wsp**
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TRANSPORT SCOTLAND
COMHDAIL ALBA

Project Stage / Design File: DMRB Stage 2 State: Preliminary

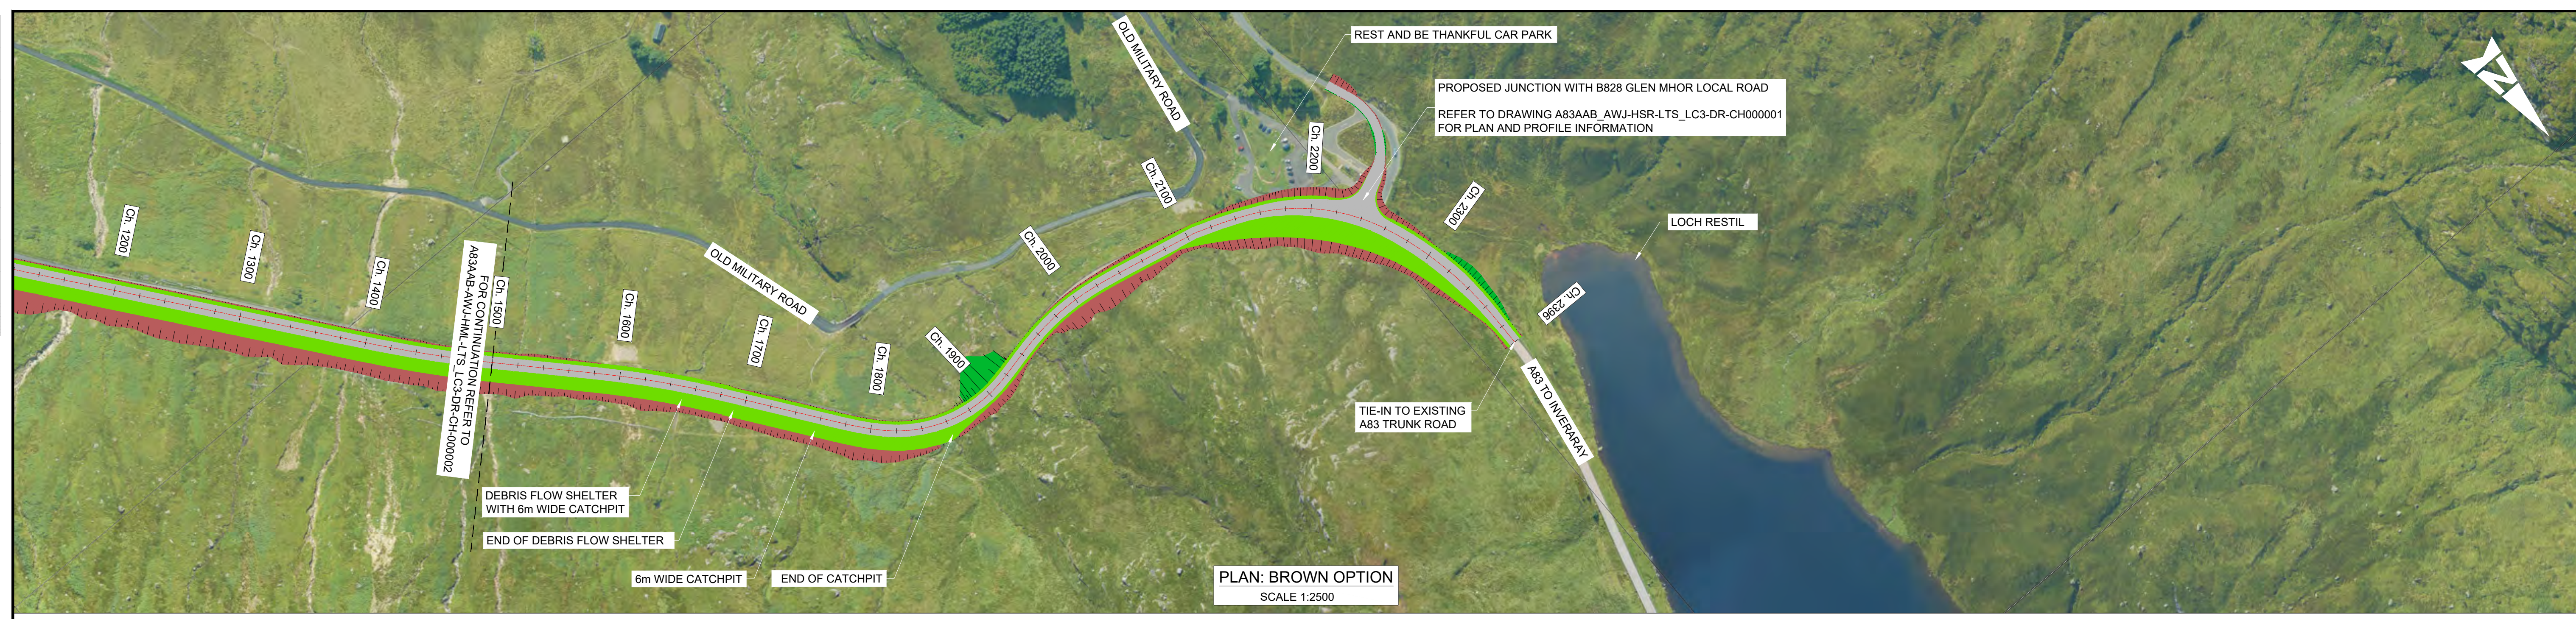
Project Title: A83 AAB

Drawing Title: BROWN OPTION PLAN AND PROFILE

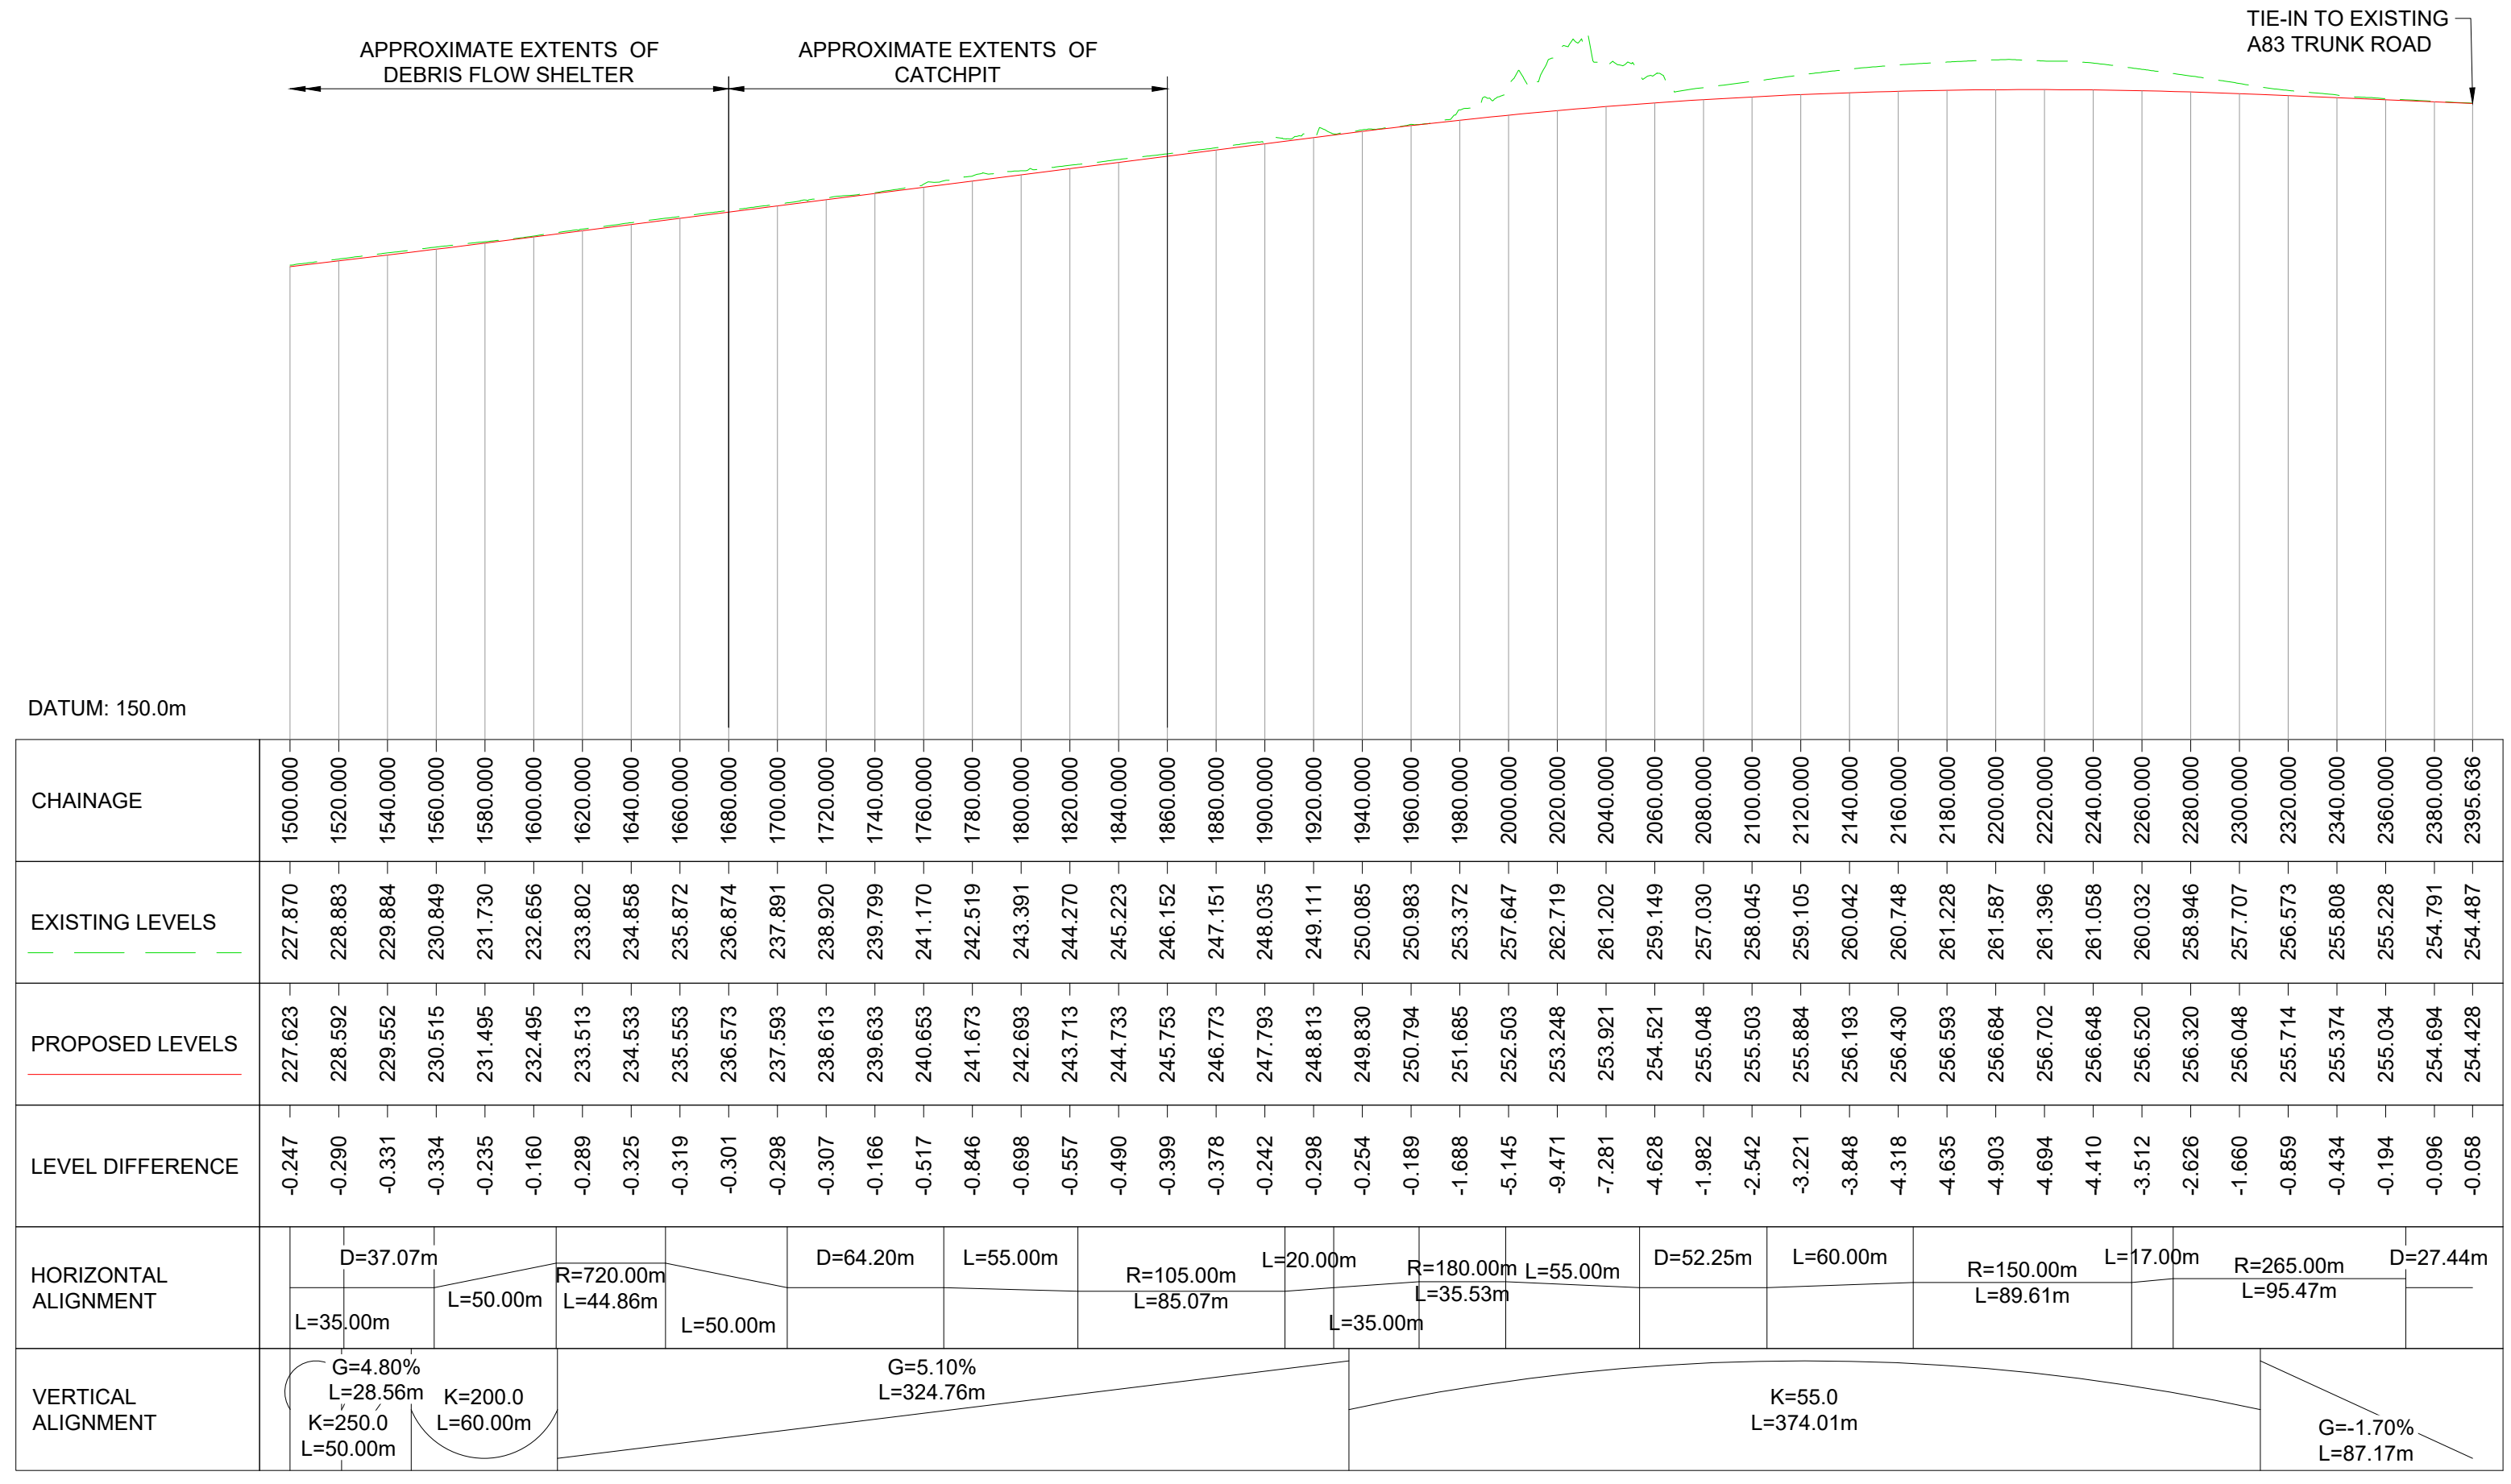
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PLAN: BROWN OPTION
SCALE 1:2500



PROFILE: BROWN OPTION
SCALE: H 1:2500, V 1:1000

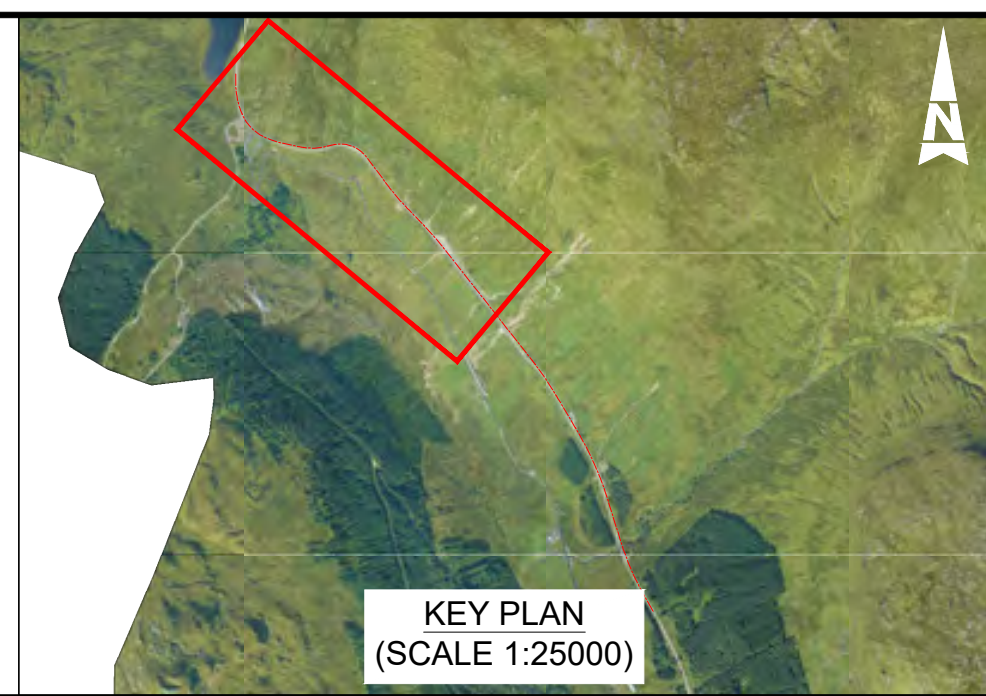
- NOTES:
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KEY - PLAN:

- PROPOSED ALIGNMENT
- PROPOSED CARRIAGEWAY
- PROPOSED VERGE
- PROPOSED FOOTWAY
- PROPOSED KERBS
- PROPOSED EARTHWORK EMBANKMENT
- PROPOSED EARTHWORK CUTTING

KEY - PROFILE:

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- EXISTING GROUND PROFILE



Description	Status	Revision	Drawn	Checked	Reviewed	Authorised	Issue Date
First Issue	S3	P01	TT	SL	CS	IA	14/02/23
Stage 2 Issue	S4	P02		SL	CS	RHG	22/05/23

Status: S4 Drawing Suitability: FOR STAGE APPROVAL

ATKINS **wsp**
Member of the SNC-Lavalin Group

TRANSPORT SCOTLAND
COMHDAIL ALBA

Project Stage / Design File: DMRB Stage 2 Preliminary

Project Title: A83 AAB

Drawing Title: BROWN OPTION PLAN AND PROFILE

Drawing Number: A83AAB - AWJ - HML - LTS_LC3 - DR-CH-000003

Originator: AWJ - HML - DR-CH-000003

Location: LTS_LC3

Original Size: A1 Scale: AS SHOWN Project Ref. No.: 6204594 Sheet: 2 of 2 Rev: P02

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Green Option

[A83AAB-AWJ-HML-LTS_LA0-DR-CH-000001_P03.pdf](#) – Location Plan

[A83AAB-AWJ-HML-LTS_LA0-DR-CH-000002_P03.pdf](#) – Plan and Profile – Sheet 1 of 3

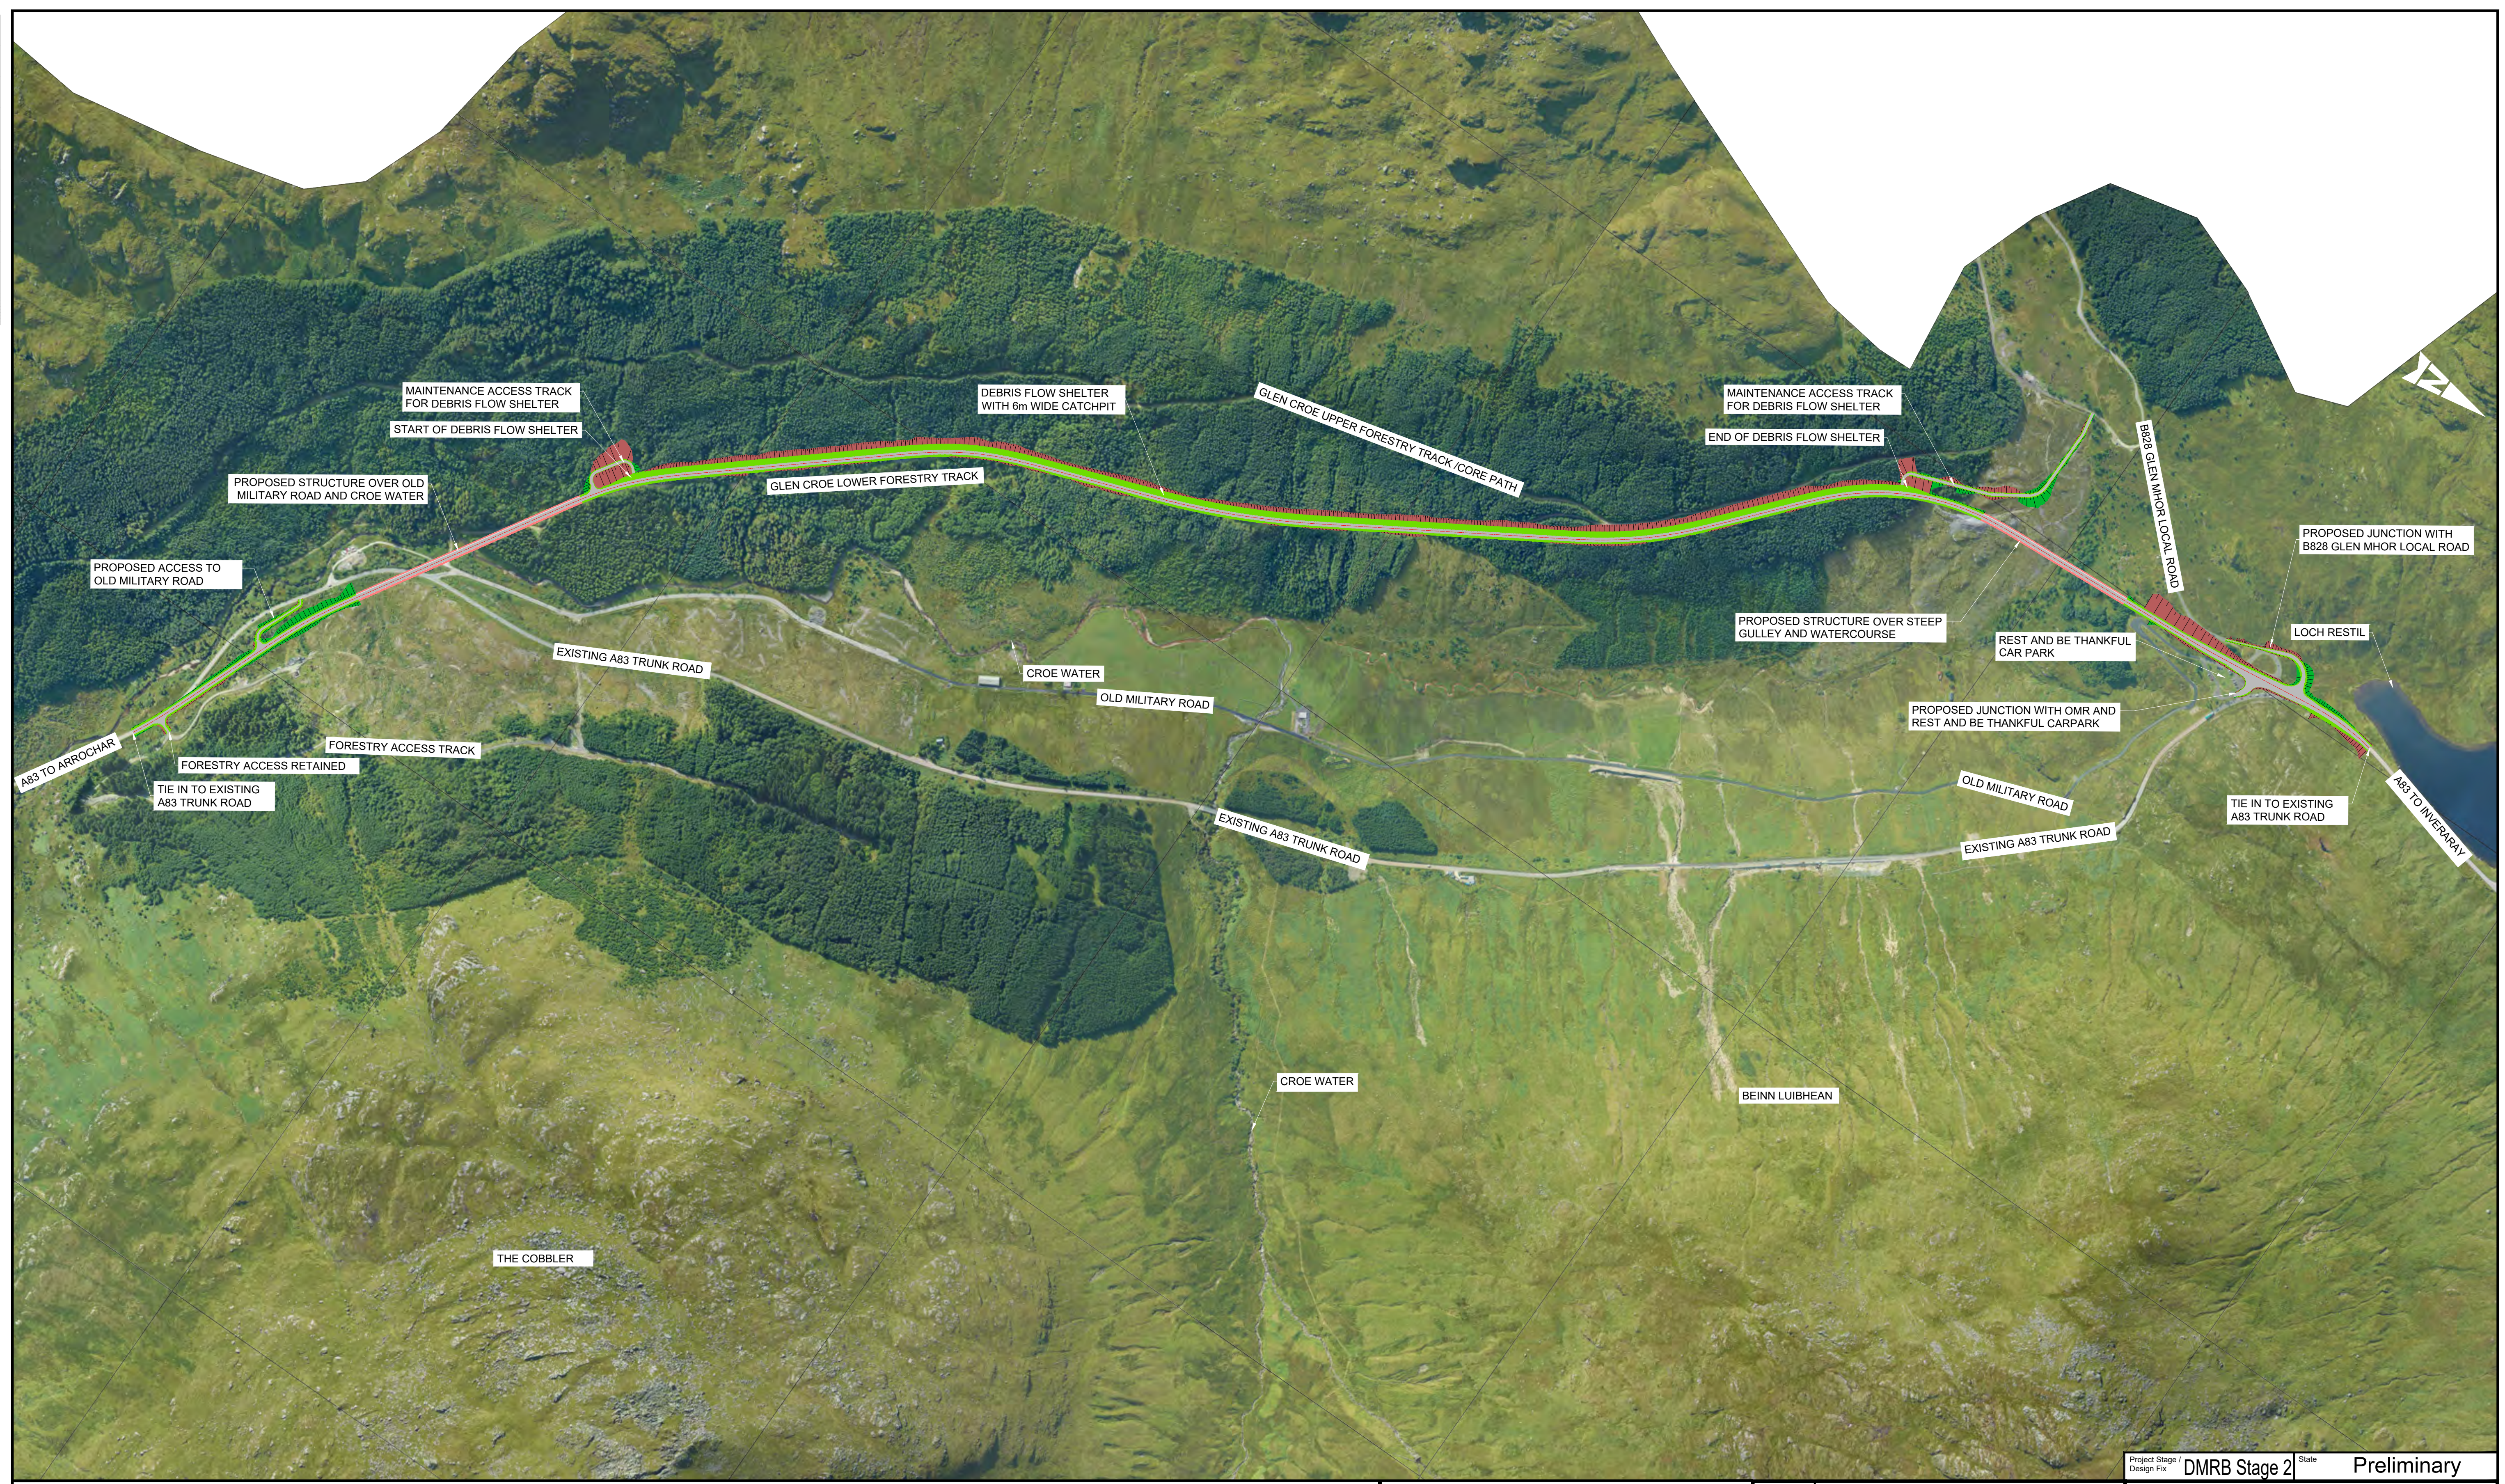
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[A83AAB-AWJ-HML-LTS_LA0-DR-CH-000004_P03.pdf](#) – Plan and Profile – Sheet 3 of 3

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 - ALL DESIGNS ARE PRELIMINARY AND HAVE BEEN DEVELOPED FOR COMPARATIVE ASSESSMENT PURPOSES AT DMRB STAGE 2 ONLY.

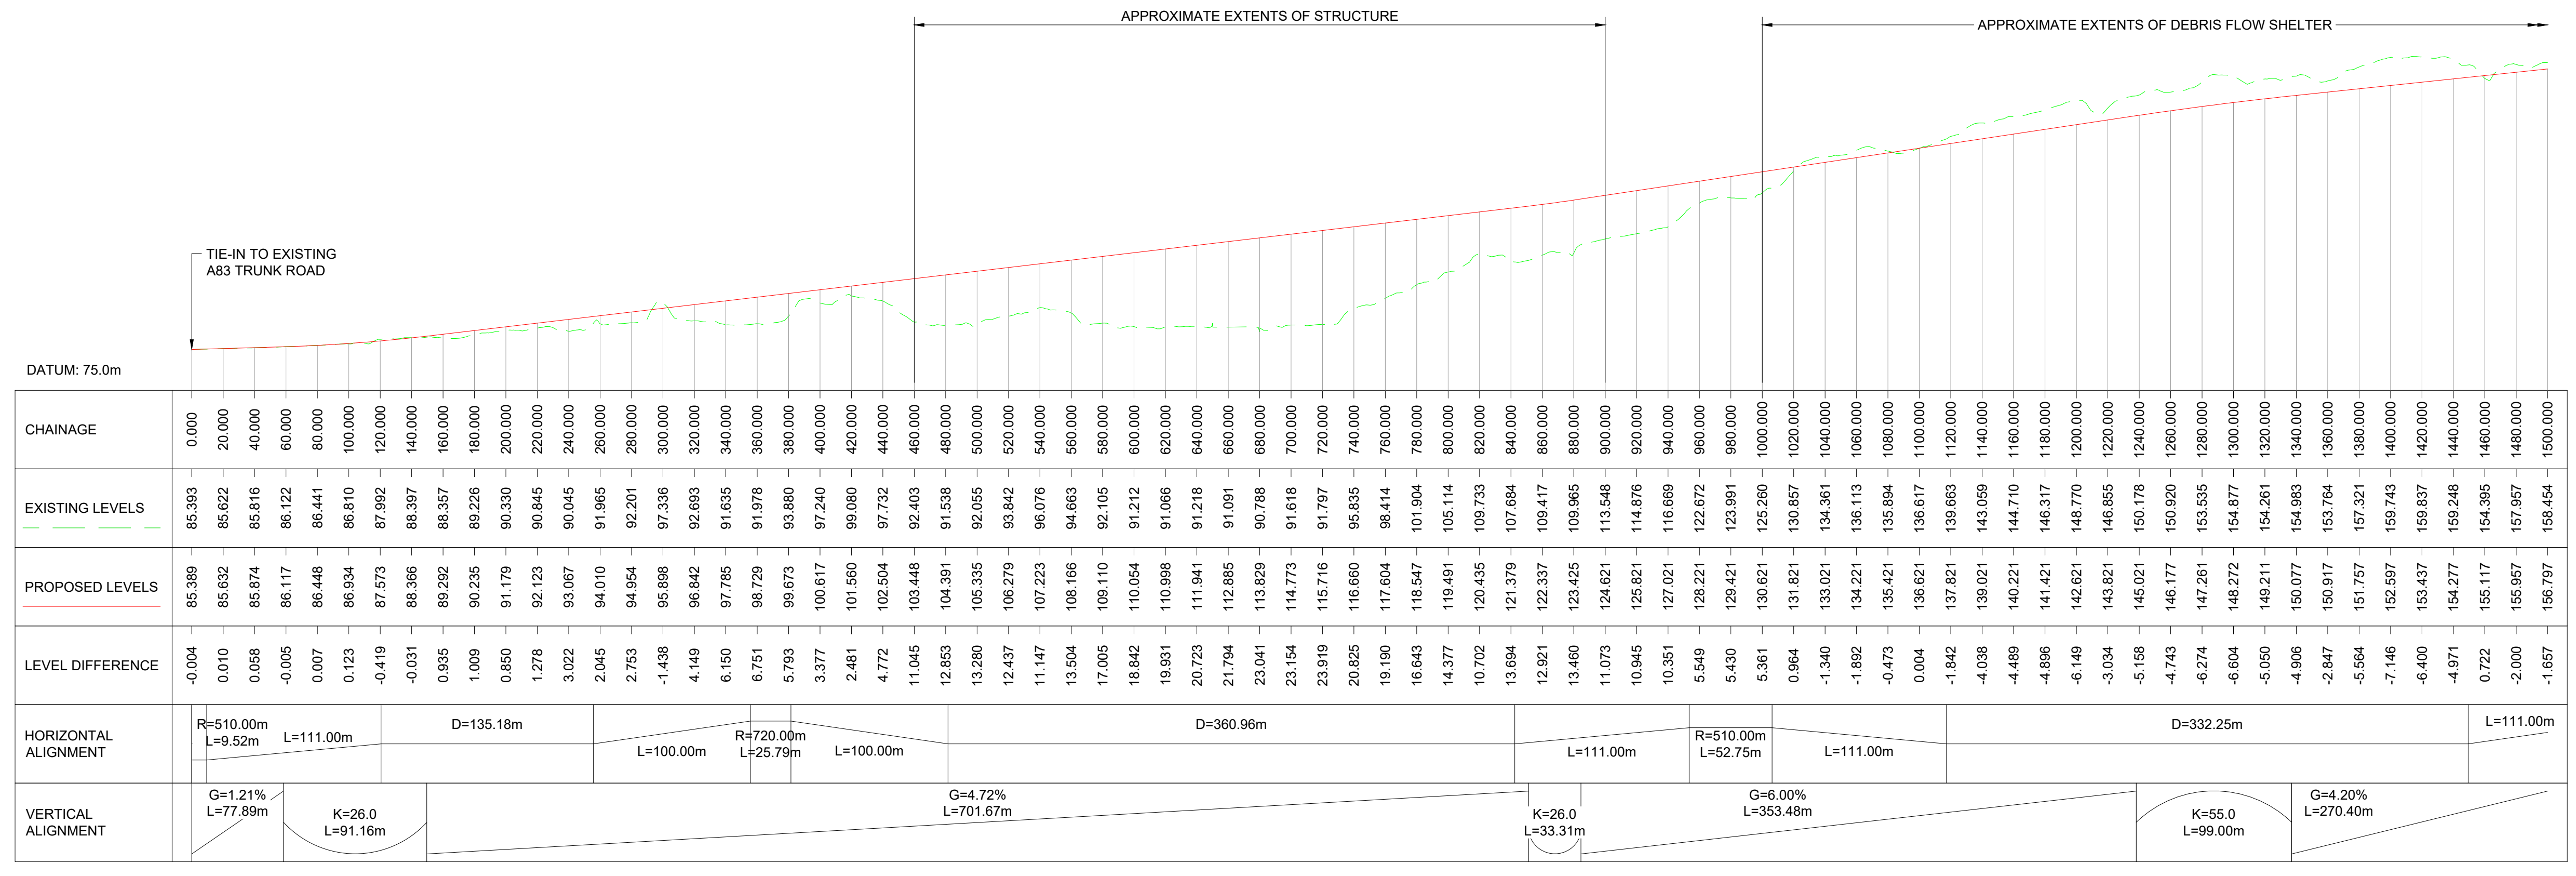
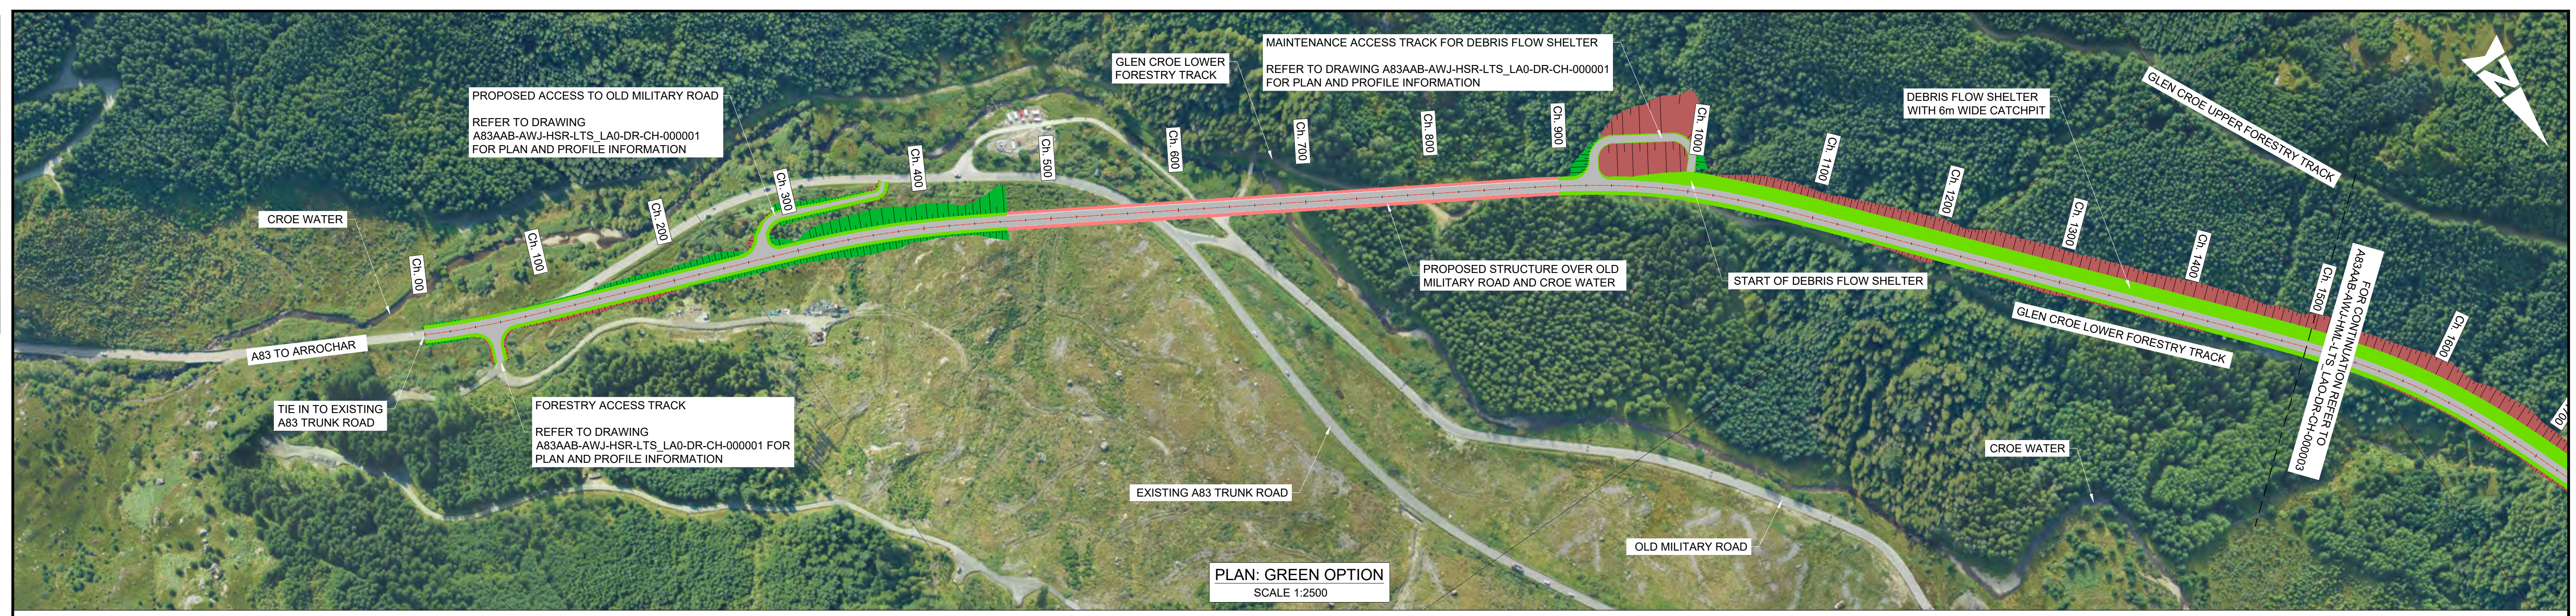
KEY - PLAN:	KEY - PROFILE:
— PROPOSED ALIGNMENT	— PROPOSED DESIGN PROFILE
 PROPOSED CARRIAGEWAY	— EXISTING GROUND PROFILE
 PROPOSED VERGE	
 PROPOSED FOOTWAY	
 PROPOSED KERBS	

Description							
Status	Revision	Drawn	Checked	Reviewed	Authorised	Issue Date	
First Issue							
S3	P01	VR	SL	CS	RHG	13/02/23	
Second Issue							
S3	P02	CS	SL	CS	IA	24/02/23	
Stage 2 Issue							
S4	P03		SL	CS	IA	22/05/23	

Status	Drawing Suitability
S4	FOR STAGE APPROVAL
 Member of the SNC-Lavalin Group	
	

Project Stage / Design File	DMRB Stage 2	State	Preliminary
Project Title	A83 AAB		
Drawing Title	GREEN OPTION LOCATION PLAN		
Drawing Number	Project	Originator	Volume
A83AAB	- AWJ	- HML	-
LTS_LA0	- DR-CH	- 000001	
Location	Type	Role	Number
A1	Scale: NTS	Project Ref. No.: 2204594	Sheet: 1 of 1 Rev: P03

DO NOT SCALE



NOTES:

- ALL DIMENSIONS SHOWN ARE IN METRES UNLESS STATED OTHERWISE.
- ALL DESIGNS ARE PRELIMINARY AND HAVE BEEN DEVELOPED FOR COMPARATIVE ASSESSMENT PURPOSES AT DMRB STAGE 2 ONLY.

KEY - PLAN:

- PROPOSED ALIGNMENT
- PROPOSED CARRIAGEWAY
- PROPOSED VERGE
- PROPOSED FOOTWAY
- PROPOSED KERBS
- PROPOSED EARTHWORK EMBANKMENT
- PROPOSED EARTHWORK CUTTING

KEY - PROFILE:

- PROPOSED DESIGN PROFILE
- EXISTING GROUND PROFILE

DESCRIPTION

Status	Revision	Drawn	Checked	Reviewed	Authorised	Issue Date
S4						

DESCRIPTION

Status	Revision	Drawn	Checked	Reviewed	Authorised	Issue Date
S3	P01	VR	SL	CS	RHG	13/02/23

DESCRIPTION

Status	Revision	Drawn	Checked	Reviewed	Authorised	Issue Date
S3	P02	CS	SL	CS	IA	24/02/23

DESCRIPTION

Status	Revision	Drawn	Checked	Reviewed	Authorised	Issue Date
S4	P03		SL	CS	IA	22/05/23

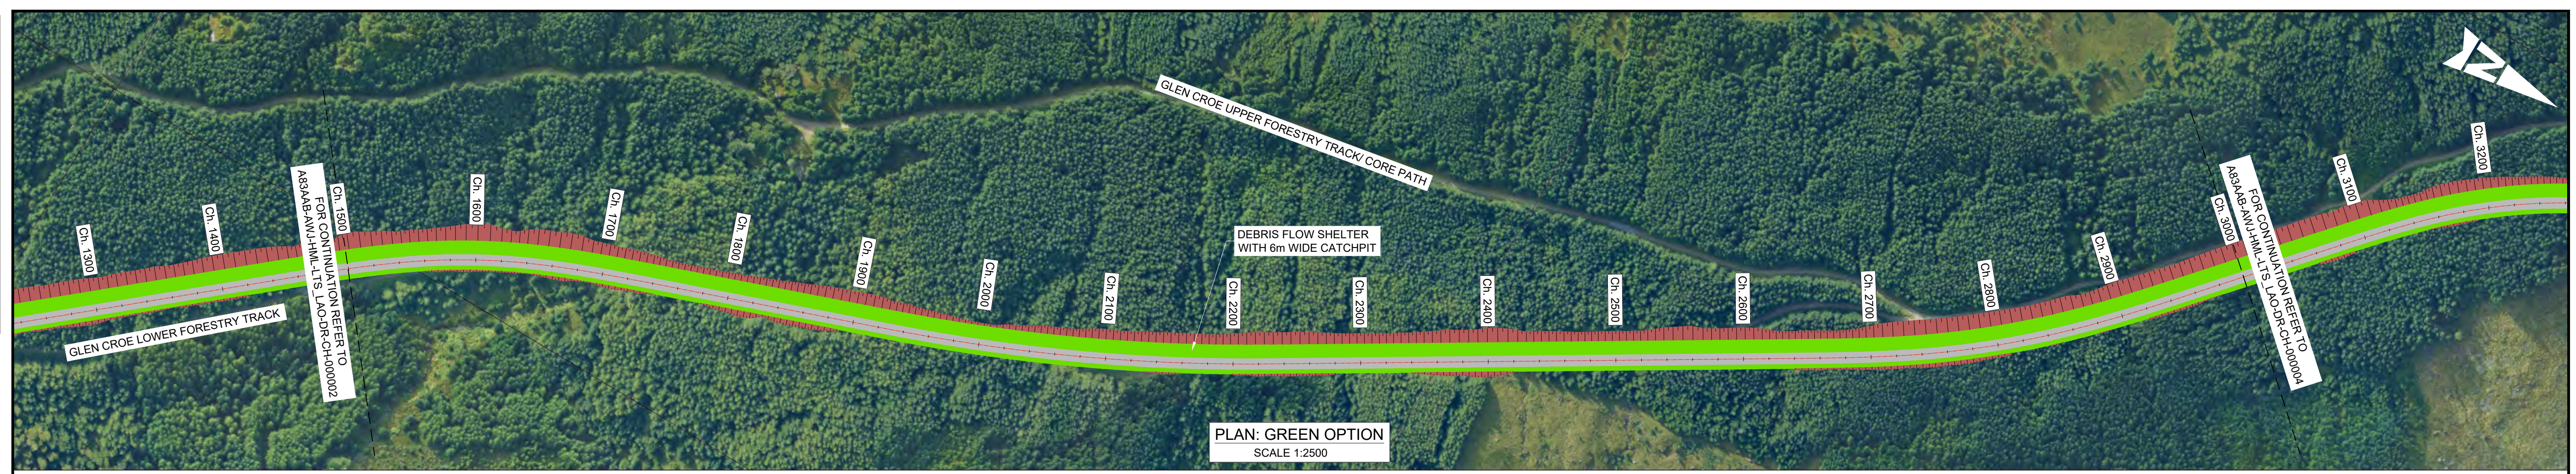
Project Stage / Design File	DMRB Stage 2	State	Preliminary
Project Title	A83 AAB		
Drawing Title	GREEN OPTION PLAN AND PROFILE		
Drawing Number	Project	Originator	Volume
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Location	Type	Role	Number
Original Size	Scale	Project Ref. No.	Sheet / Rev.
A1	AS SHOWN	g204594	1 of 3 / P03

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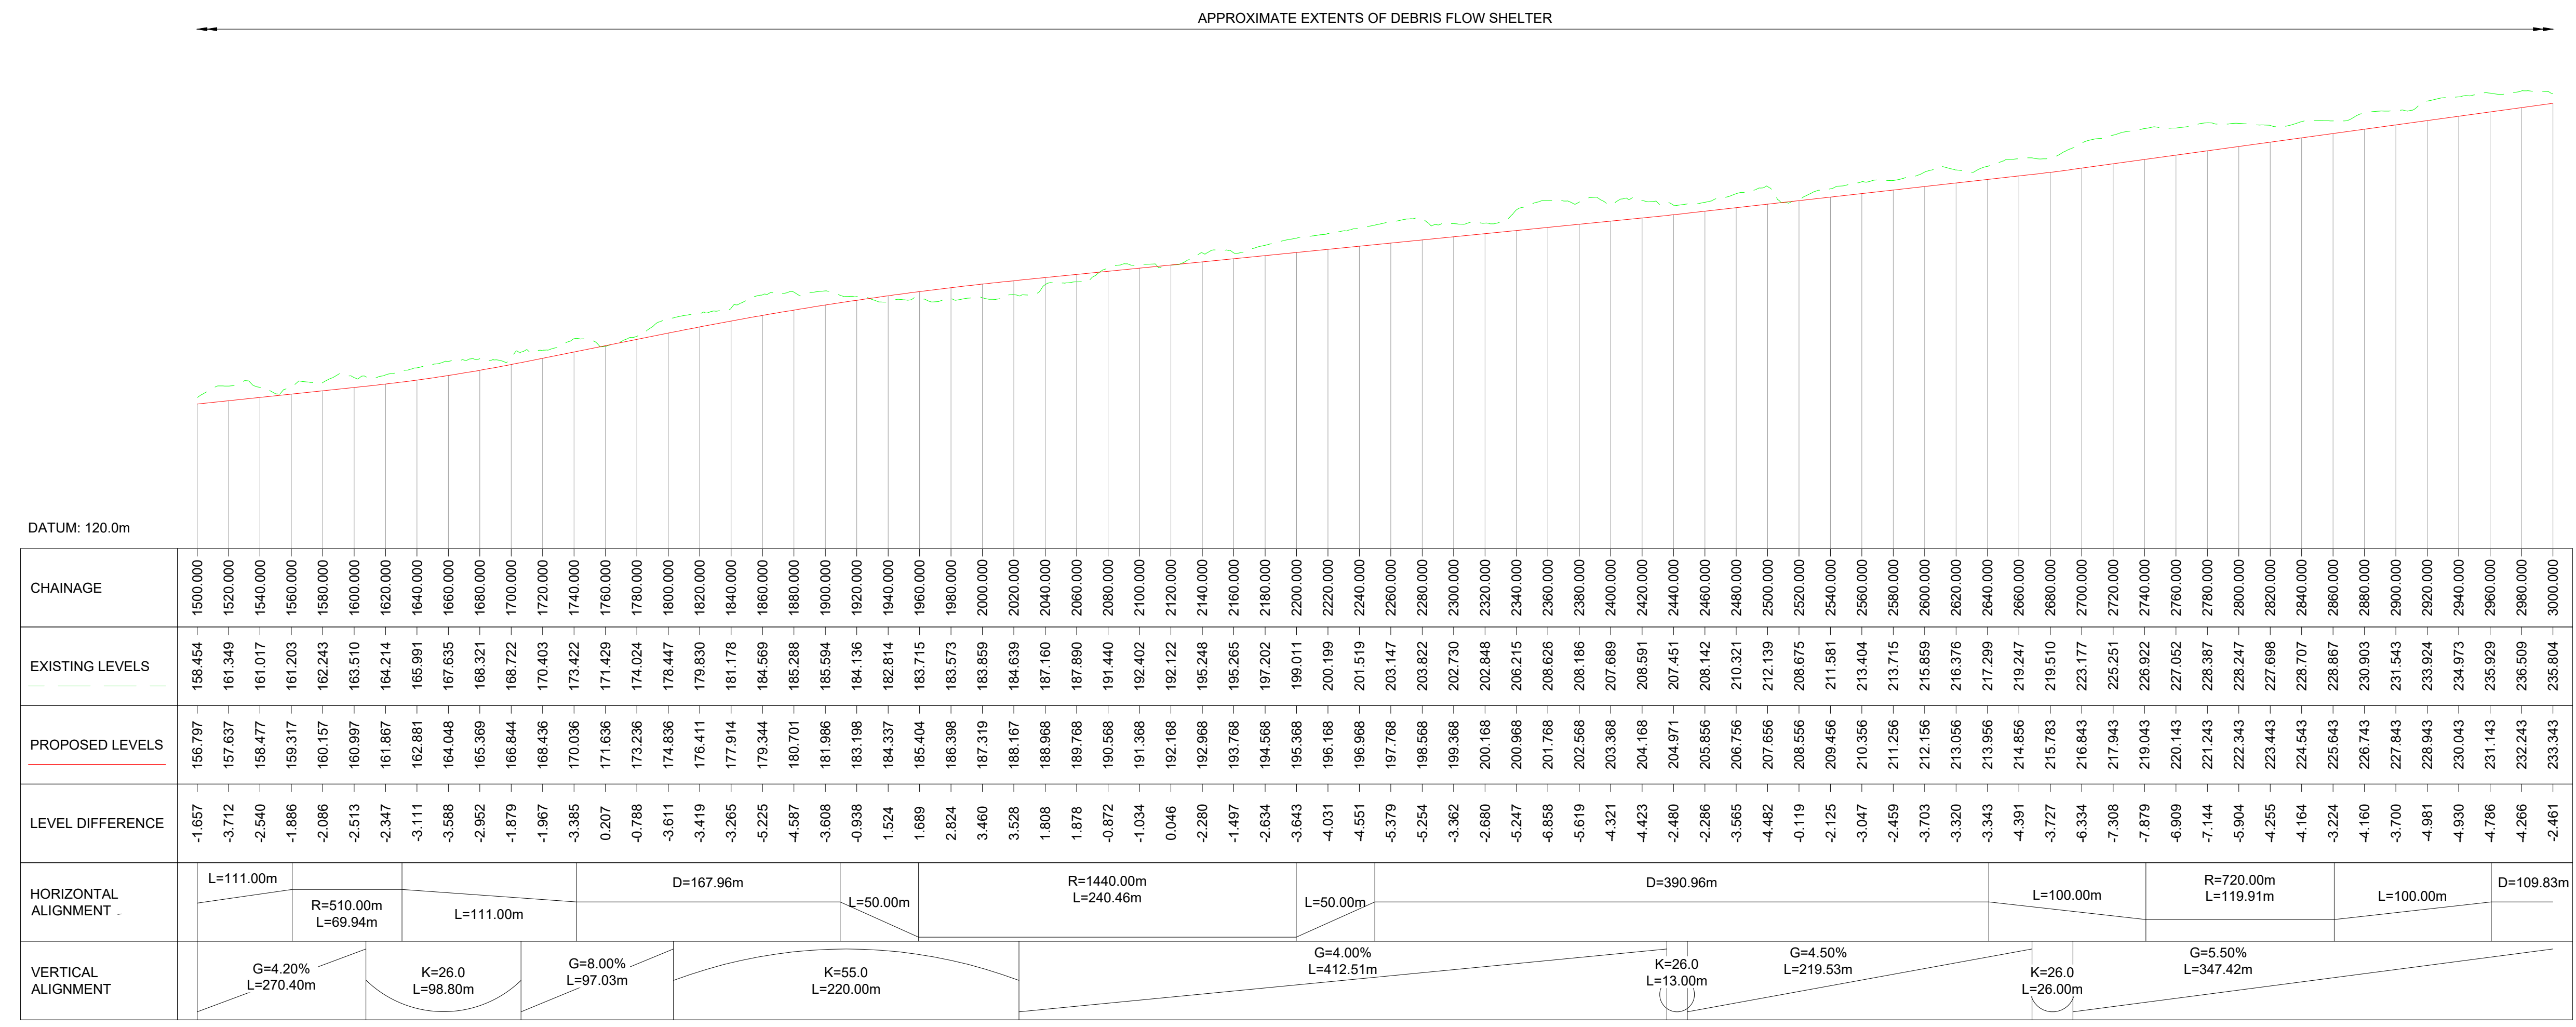
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DO NOT SCALE

Millimetres
0 10 100



PLAN: GREEN OPTION
SCALE 1:2500



PROFILE: GREEN OPTION
SCALE: H 1:2500, V 1:1000

NOTES:

- ALL DIMENSIONS SHOWN ARE IN METRES UNLESS STATED OTHERWISE.
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KEY - PLAN:

- PROPOSED ALIGNMENT
- PROPOSED CARRIAGEWAY
- PROPOSED VERGE
- PROPOSED FOOTWAY
- PROPOSED KERBS
- PROPOSED EARTHWORK EMBANKMENT
- PROPOSED EARTHWORK CUTTING

KEY - PROFILE:

- PROPOSED DESIGN PROFILE
- EXISTING GROUND PROFILE



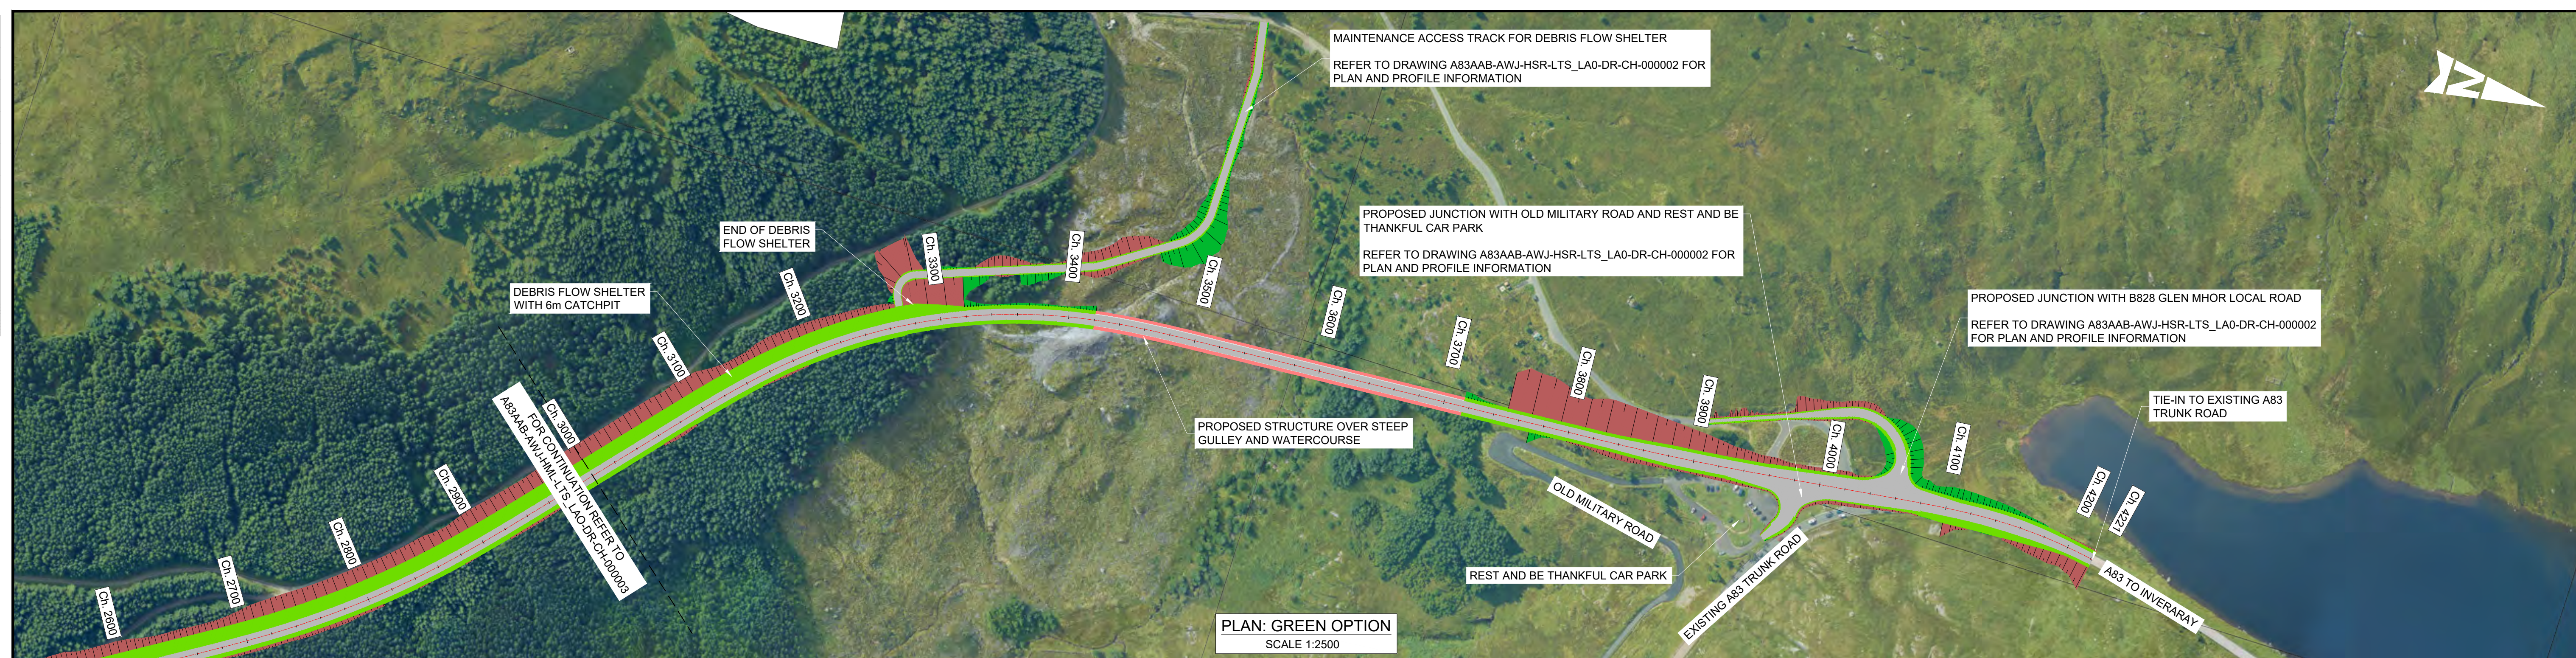
Description	Status	Revision	Drawn	Checked	Reviewed	Authorised	Issue Date
First Issue	S3	P01	VR	SL	CS	RHG	13/02/23
Second Issue	S3	P02	CS	SL	CS	IA	24/02/23
Stage 2 Issue	S4	P03		SL	CS	IA	22/05/23

Status	S4	Drawing Suitability	FOR STAGE APPROVAL

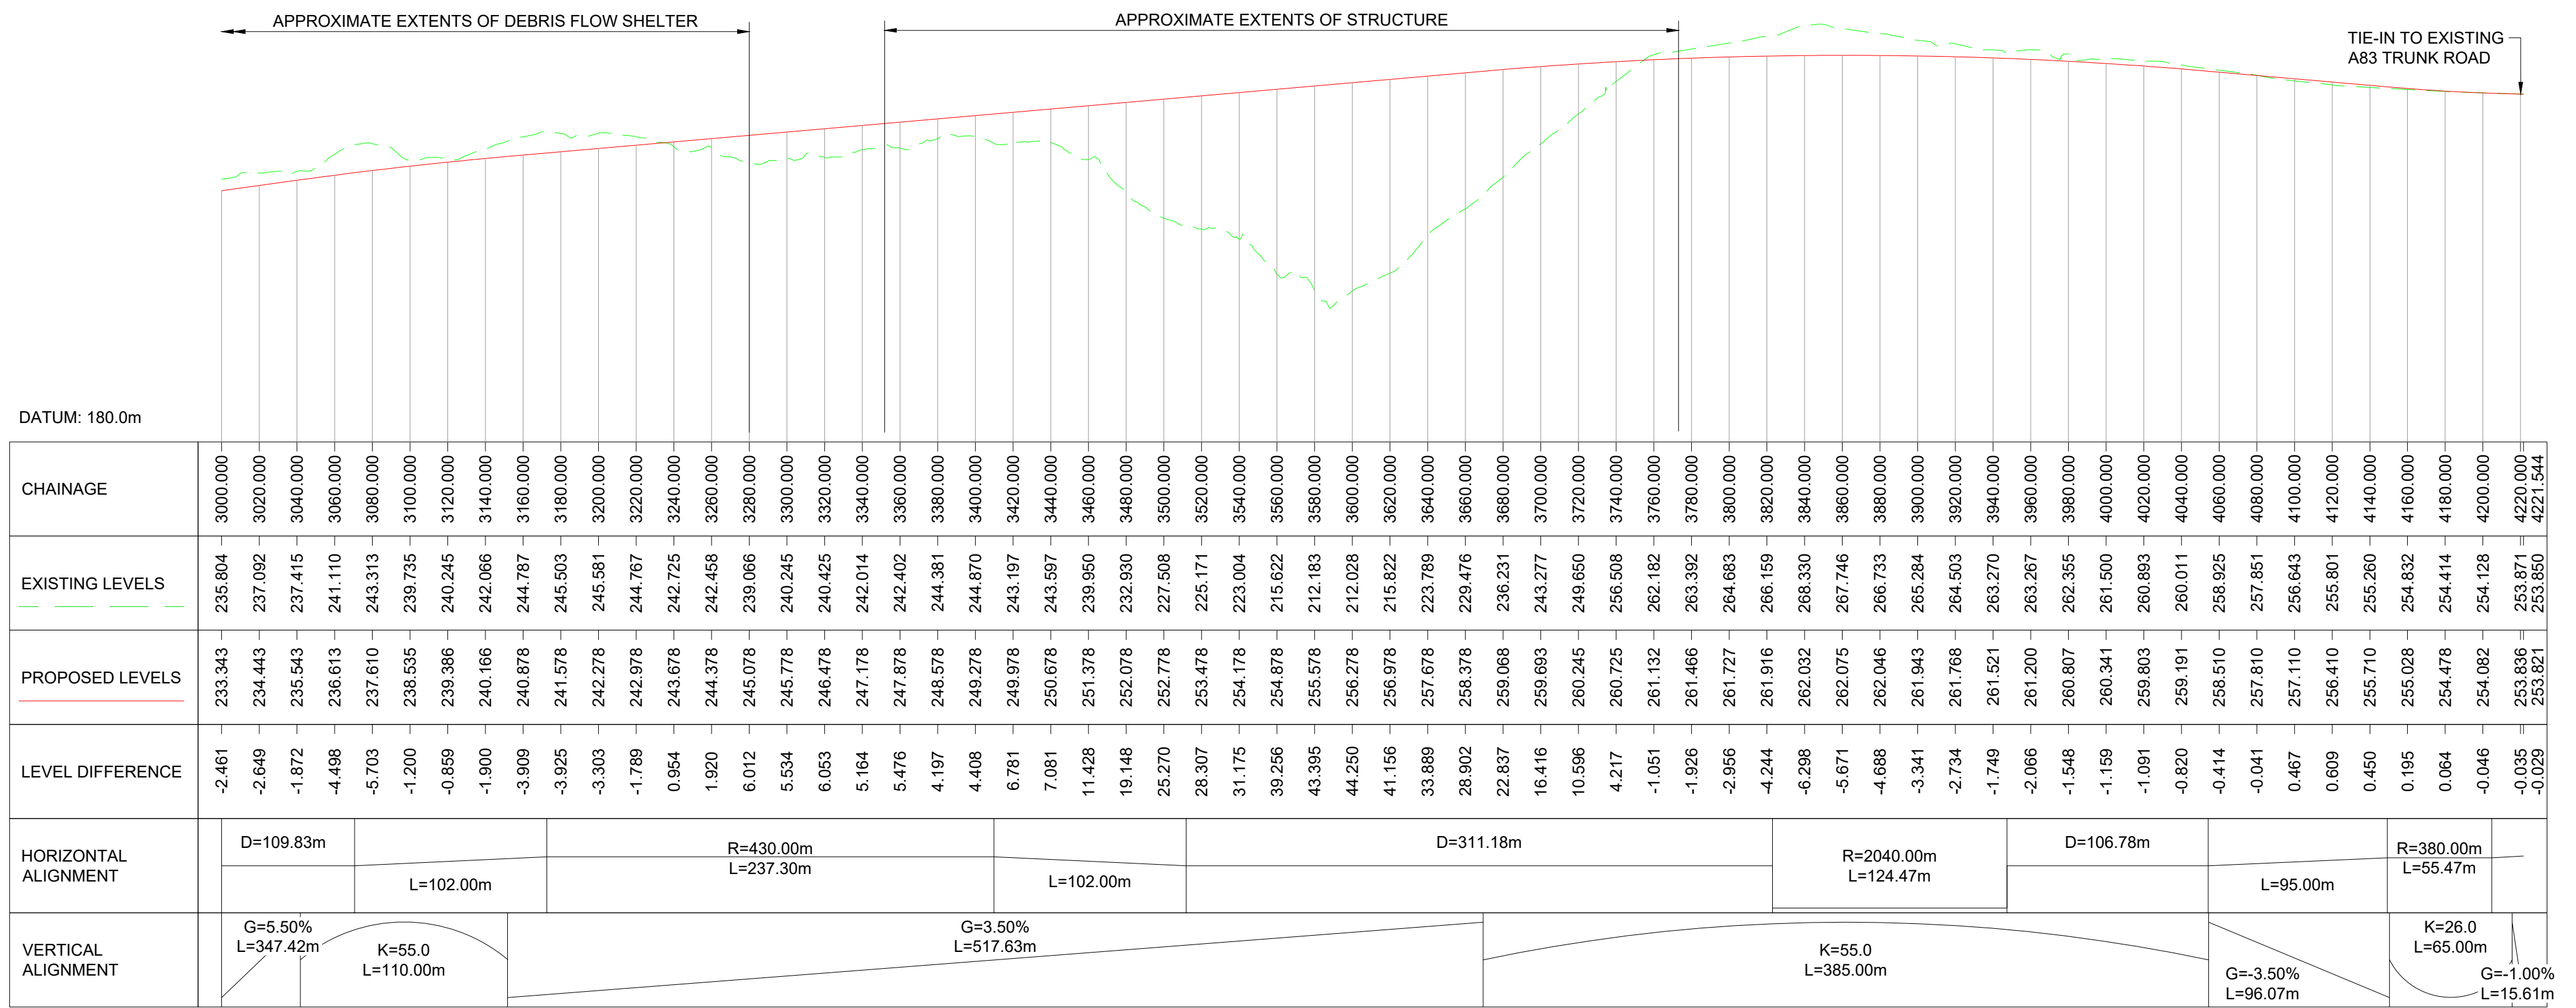
Project Stage / Design File	DMRB Stage 2	State	Preliminary
Project Title	A83 AAB		
Drawing Title	GREEN OPTION PLAN AND PROFILE		
Drawing Number / Project	A83AAB - AWJ - HML - LTS_LA0	Originator	DR-CH-000003
Location	Type / Role / Number		
Original Size	A1	Scale	AS SHOWN
Project Ref. No.	6204594	Sheet	2 of 3
Rev.	P03		

DO NOT SCALE

Millimetres

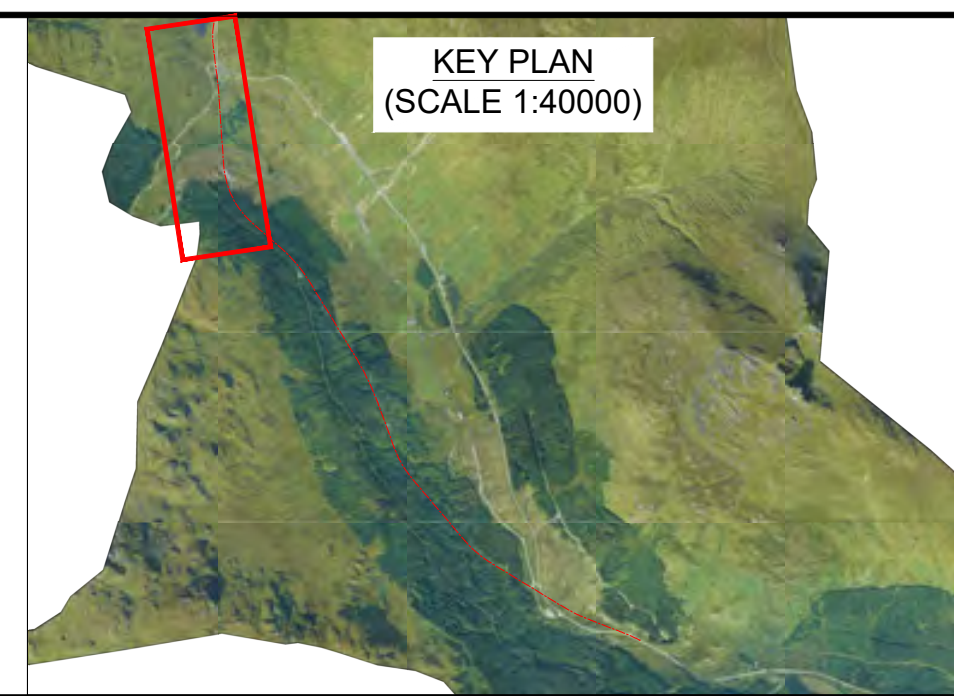


PLAN: GREEN OPTION
SCALE 1:2500



PROFILE: GREEN OPTION
SCALE: H 1:2500, V 1:1000

NOTES:
1. ALL DIMENSIONS SHOWN ARE IN METRES UNLESS STATED OTHERWISE.
2. ALL DESIGNS ARE PRELIMINARY AND HAVE BEEN DEVELOPED FOR COMPARATIVE ASSESSMENT PURPOSES AT DMRB STAGE 2 ONLY.



KEY - PLAN:		KEY - PROFILE:	
	PROPOSED ALIGNMENT		PROPOSED DESIGN PROFILE
	PROPOSED CARRIAGEWAY		EXISTING GROUND PROFILE
	PROPOSED VERGE		
	PROPOSED FOOTWAY		
	PROPOSED KERBS		
	PROPOSED EARTHWORK EMBANKMENT		
	PROPOSED EARTHWORK CUTTING		

Description	Status	Revision	Drawn	Checked	Reviewed	Authorised	Issue Date
First Issue	S3	P01	VR	SL	CS	RHG	13/02/23
Second Issue	S3	P02	CS	SL	CS	IA	24/02/23
Stage 2 Issue	S4	P03		SL	CS	IA	22/05/23

Status: **S4** Drawing Suitability: **FOR STAGE APPROVAL**

ATKINS **wsp**
Member of the SNC-Lavalin Group

TRANSPORT SCOTLAND
COMHDAIL ALBA

Project Stage / Design File: DMRB Stage 2	State: Preliminary
Project Title: A83 AAB	Drawing Title: GREEN OPTION PLAN AND PROFILE
Drawing Number: A83AAB - AWJ - HML - LTS_LA0 - DR-CH-000004	Originator: IA
Location: LTS_LA0	Volume: 3 of 3
Original Size: A1	Scale: AS SHOWN
Project Ref. No.: 6204594	Sheet: 3 of 3
Rev. No.: P03	

Purple Option

[A83AAB-AWJ-HML-LTS_LD1-DR-CH-000001_P02.pdf](#) – Location Plan

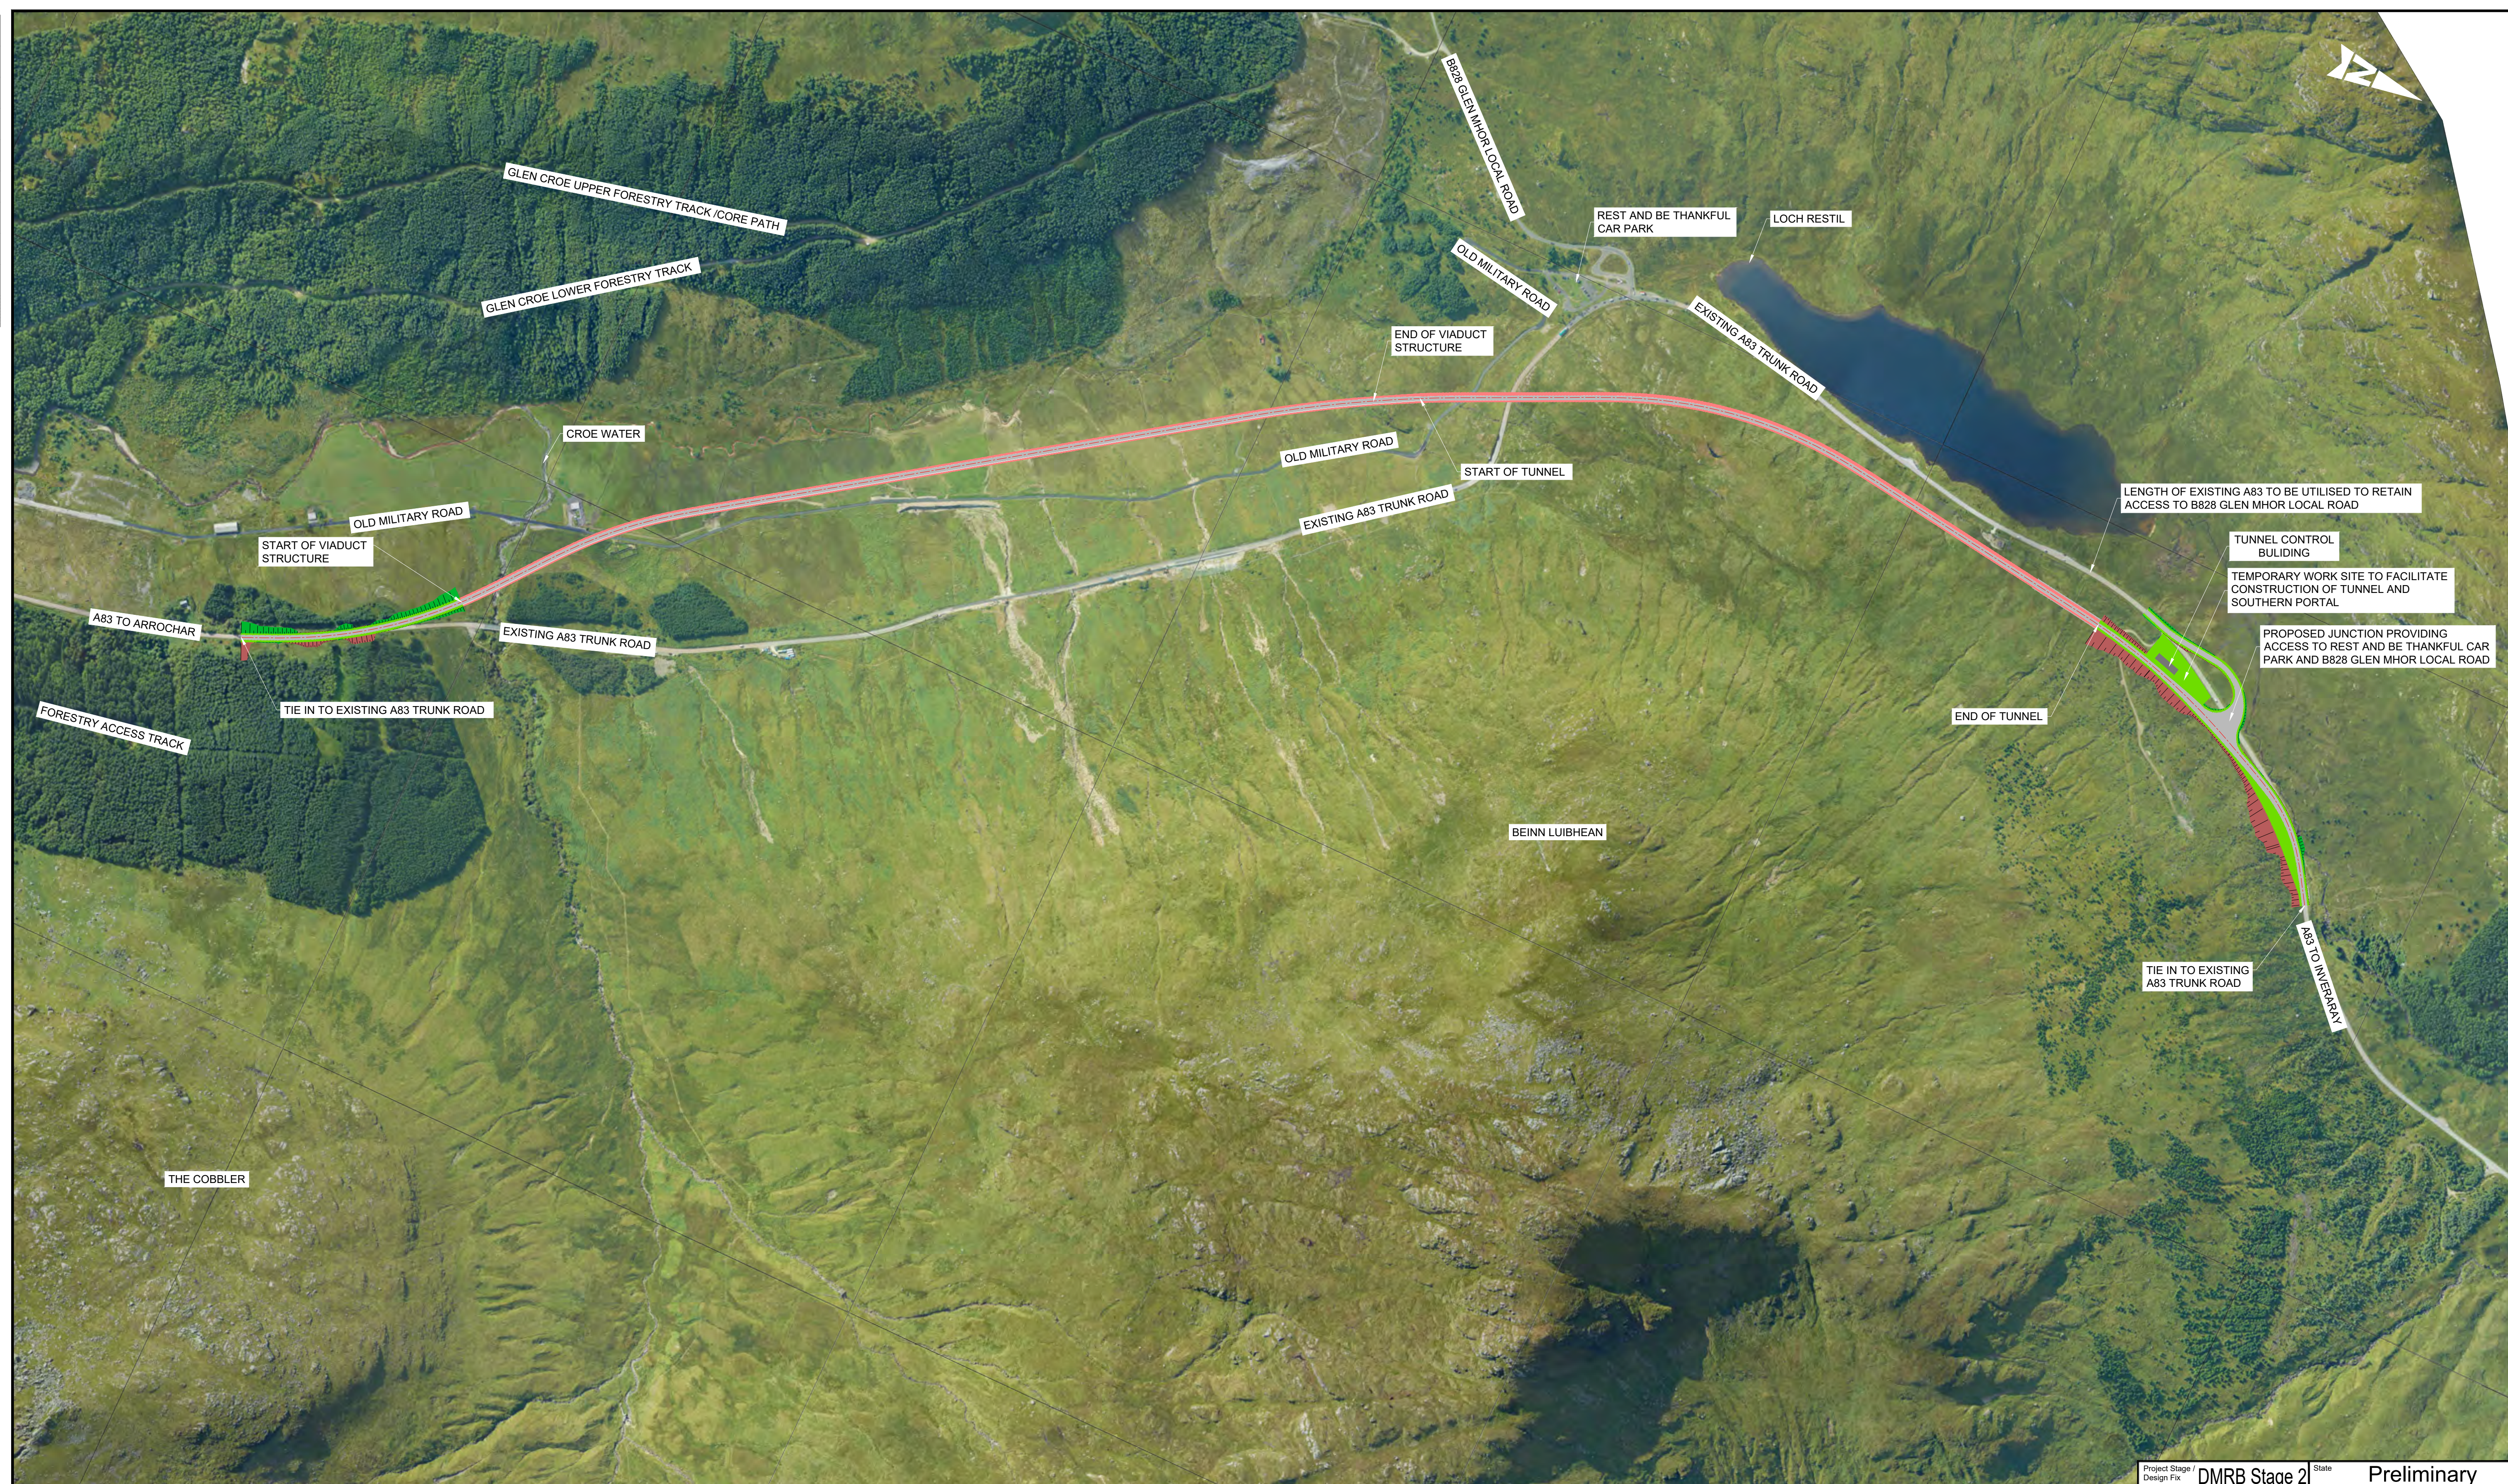
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[A83AAB-AWJ-HML-LTS_LD1-DR-CH-000003_P02.pdf](#) – Plan and Profile – Sheet 2 of 3

[A83AAB-AWJ-HML-LTS_LD1-DR-CH-000004_P02.pdf](#) – Plan and Profile – Sheet 3 of 3

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DO NOT SCALE
 Millimetres
 0 10 100



NOTES:
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 2. ALL DESIGNS ARE PRELIMINARY AND HAVE BEEN DEVELOPED FOR COMPARATIVE ASSESSMENT PURPOSES AT DMRB STAGE 2 ONLY.

KEY - PLAN:		KEY - PROFILE:	
	PROPOSED ALIGNMENT		PROPOSED DESIGN PROFILE
	PROPOSED CARRIAGEWAY		EXISTING GROUND PROFILE
	PROPOSED VERGE		
	PROPOSED FOOTWAY		
	PROPOSED KERBS		

Description							
Status	Revision	Drawn	Checked	Reviewed	Authorised	Issue Date	
Description							
Status	Revision	Drawn	Checked	Reviewed	Authorised	Issue Date	
Description							
Status	Revision	Drawn	Checked	Reviewed	Authorised	Issue Date	
Description							
First Issue							
Status	Revision	Drawn	Checked	Reviewed	Authorised	Issue Date	
S3	P01	VR	BM	CS	IA	10/02/23	
Description							
Stage 2 Issue							
Status	Revision	Drawn	Checked	Reviewed	Authorised	Issue Date	
S4	P02		BM	CS	IA	22/05/23	

Status	Design Suitability
S4	FOR STAGE APPROVAL
 Member of the SNC-Lavalin Group	

Project Stage / Design File	DMRB Stage 2	State	Preliminary
Project Title	A83 AAB		
Drawing Title	LOCATION PLAN PURPLE OPTION		
Drawing Number	Project	Originator	Volume
	A83AAB - AWJ - HML - LTS_LD1	- DR-CH-000001	
Location	Type	Role	Number
Original Size	Scale	Project Ref. No.	Sheet
A1	1:5000	5204594	1 of 1
			Rev. P02