





## A737 Improvements at Beith

**Environmental Statement** 

**Volume 2 Figures and Drawings** 

CO25000199 001 FINAL October 2016



## **Index of Drawings**

25000199/WP10/000/001 layout1 - Location Plan

25000199/100/CPO/LRP/CPO No. 1 - Compulsory Purchase Order

25000199/100/050 - Option A Single Roundabout Barmill Road General Layout

25000199/100/051 – Option B Two Roundabouts – Barrmill Offline General Layout

25000199/100/052 - Option C Two Roundabouts Barrmill Road Online General Layout

25000199/100/053 – Option D Traffic Signals Options General Layout

25000199/100/145 B706 - Re-aligned Barrmill Road East Cross Sections (m06q) Sheet 1 of 5

25000199/100/146 B706 - Re-aligned Barrmill Road East Cross Sections (m06g) Sheet 2 of 5

25000199/100/147 B706 - Re-aligned Barrmill Road East Cross Sections (m06q) Sheet 3 of 5

25000199/100/148 B706 – Re-aligned Barrmill Road East Cross Sections (m06q) Sheet 4 of 5

25000199/100/197 B706 - Re-aligned Barrmill Road East Cross Sections (m06q) Sheet 5 of 5

25000199/100/150 B706 - Re-aligned Barrmill Rd West Cross Sections (m07q) Sheet 1 of 2

25000199/100/151 B706 - Re-aligned Barrmill Rd West Cross Sections (m07g) Sheet 2 of 2

25000199/100/158 - VfM3 Plan and Profile

25000199/100/166 - Landscape Proposals

25000199/100/167 - Photomontages

A737/A738 Trunk Road (Improvements at Beith) Open Space Exchange Proposals

## **Index of Figures**

Figure 2.1 – S-Paramics Traffic Model Extents

Figure 6.1 – Air Quality: Temporary Impacts 350 Metre Buffer

Figure 6.2 – Air Quality: Permanent Impacts 200 Metre Buffer

Figure 7.1 – Cultural Heritage

Figure 7.2 – Historic Landscape Assessment (HLA) areas

Figure 8.1 – Zone of Visual Influence (ZVI)

Figure 8.2 – A737 Improvements at Beith

Figure 9.1 – Phase 1 Habitat Survey

Figure 10.1 – Solid Geology

Figure 10.2 – Drift Geology

Figure 10.3 – European Soil Database (ESDB) Soils

Figure 10.4 - Contaminated Land

Figure 12.1 – Noise and Vibration Study and Calculation Area

Figure 12.2 – Baseline Noise Monitoring Locations

Figure 12.3 – Short Term Do-Something Comparison without Mitigation (Do-Something 2018 - Do-Minimum 2018)

Figure 12.4 – Long Term Do-Minimum Comparison without mitigation – Day (Do-Minimum 2022 - Do-Minimum 2018)

Figure 12.5 – Long Term Do-Minimum Comparison without mitigation - Night-time (Do-Minimum 2022 - Do-Minimum 2018)

Figure 12.6 – Long Term Do-Something Comparison without Mitigation – Day (Do-Something 2022 - Do-Minimum 2018)

Figure 12.7 – Short Term Do-Something Comparison with Mitigation (Do-Something 2018 - Do-Minimum 2018)

Figure 12.8 – Short Term Do-Something Comparison with Mitigation (Do-Something 2018 - Do-Minimum 2018)

Figure 12.9 – Long Term Do-Something Comparison with Mitigation (Do-Something 2022 - Do-Minimum 2018)

Figure 12.10 – Long Term Do-Something Comparison with Mitigation - Night-time (Do-

Something 2022 - Do-Minimum 2018)

Figure 13.1 – Community Facilities

Figure 13.2 – Beith Primary School Catchment Area


Figure 13.3 – Changes in NMU journey lengths at Barrmill Road junction


Figure 13.4 – NMU Routes


Figure 14.1 – Land Capability for Agriculture


Figure 15.1 – Water environment


Figure 15.2 – Storm water route plans

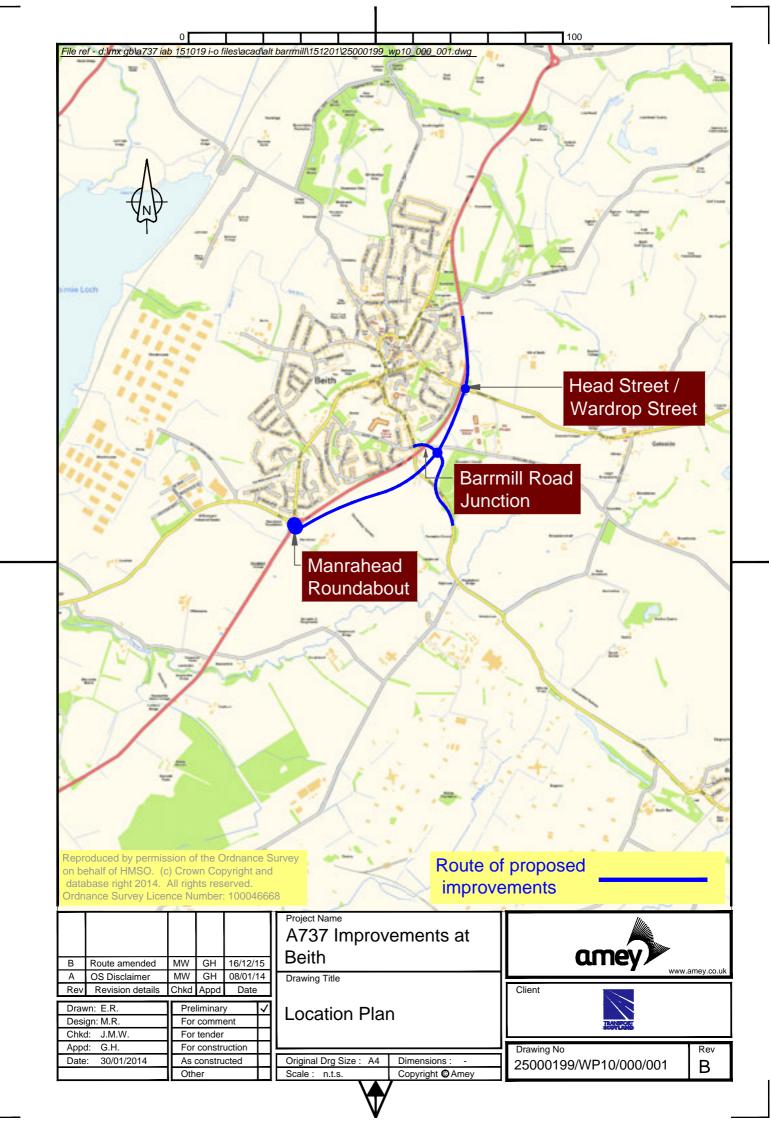


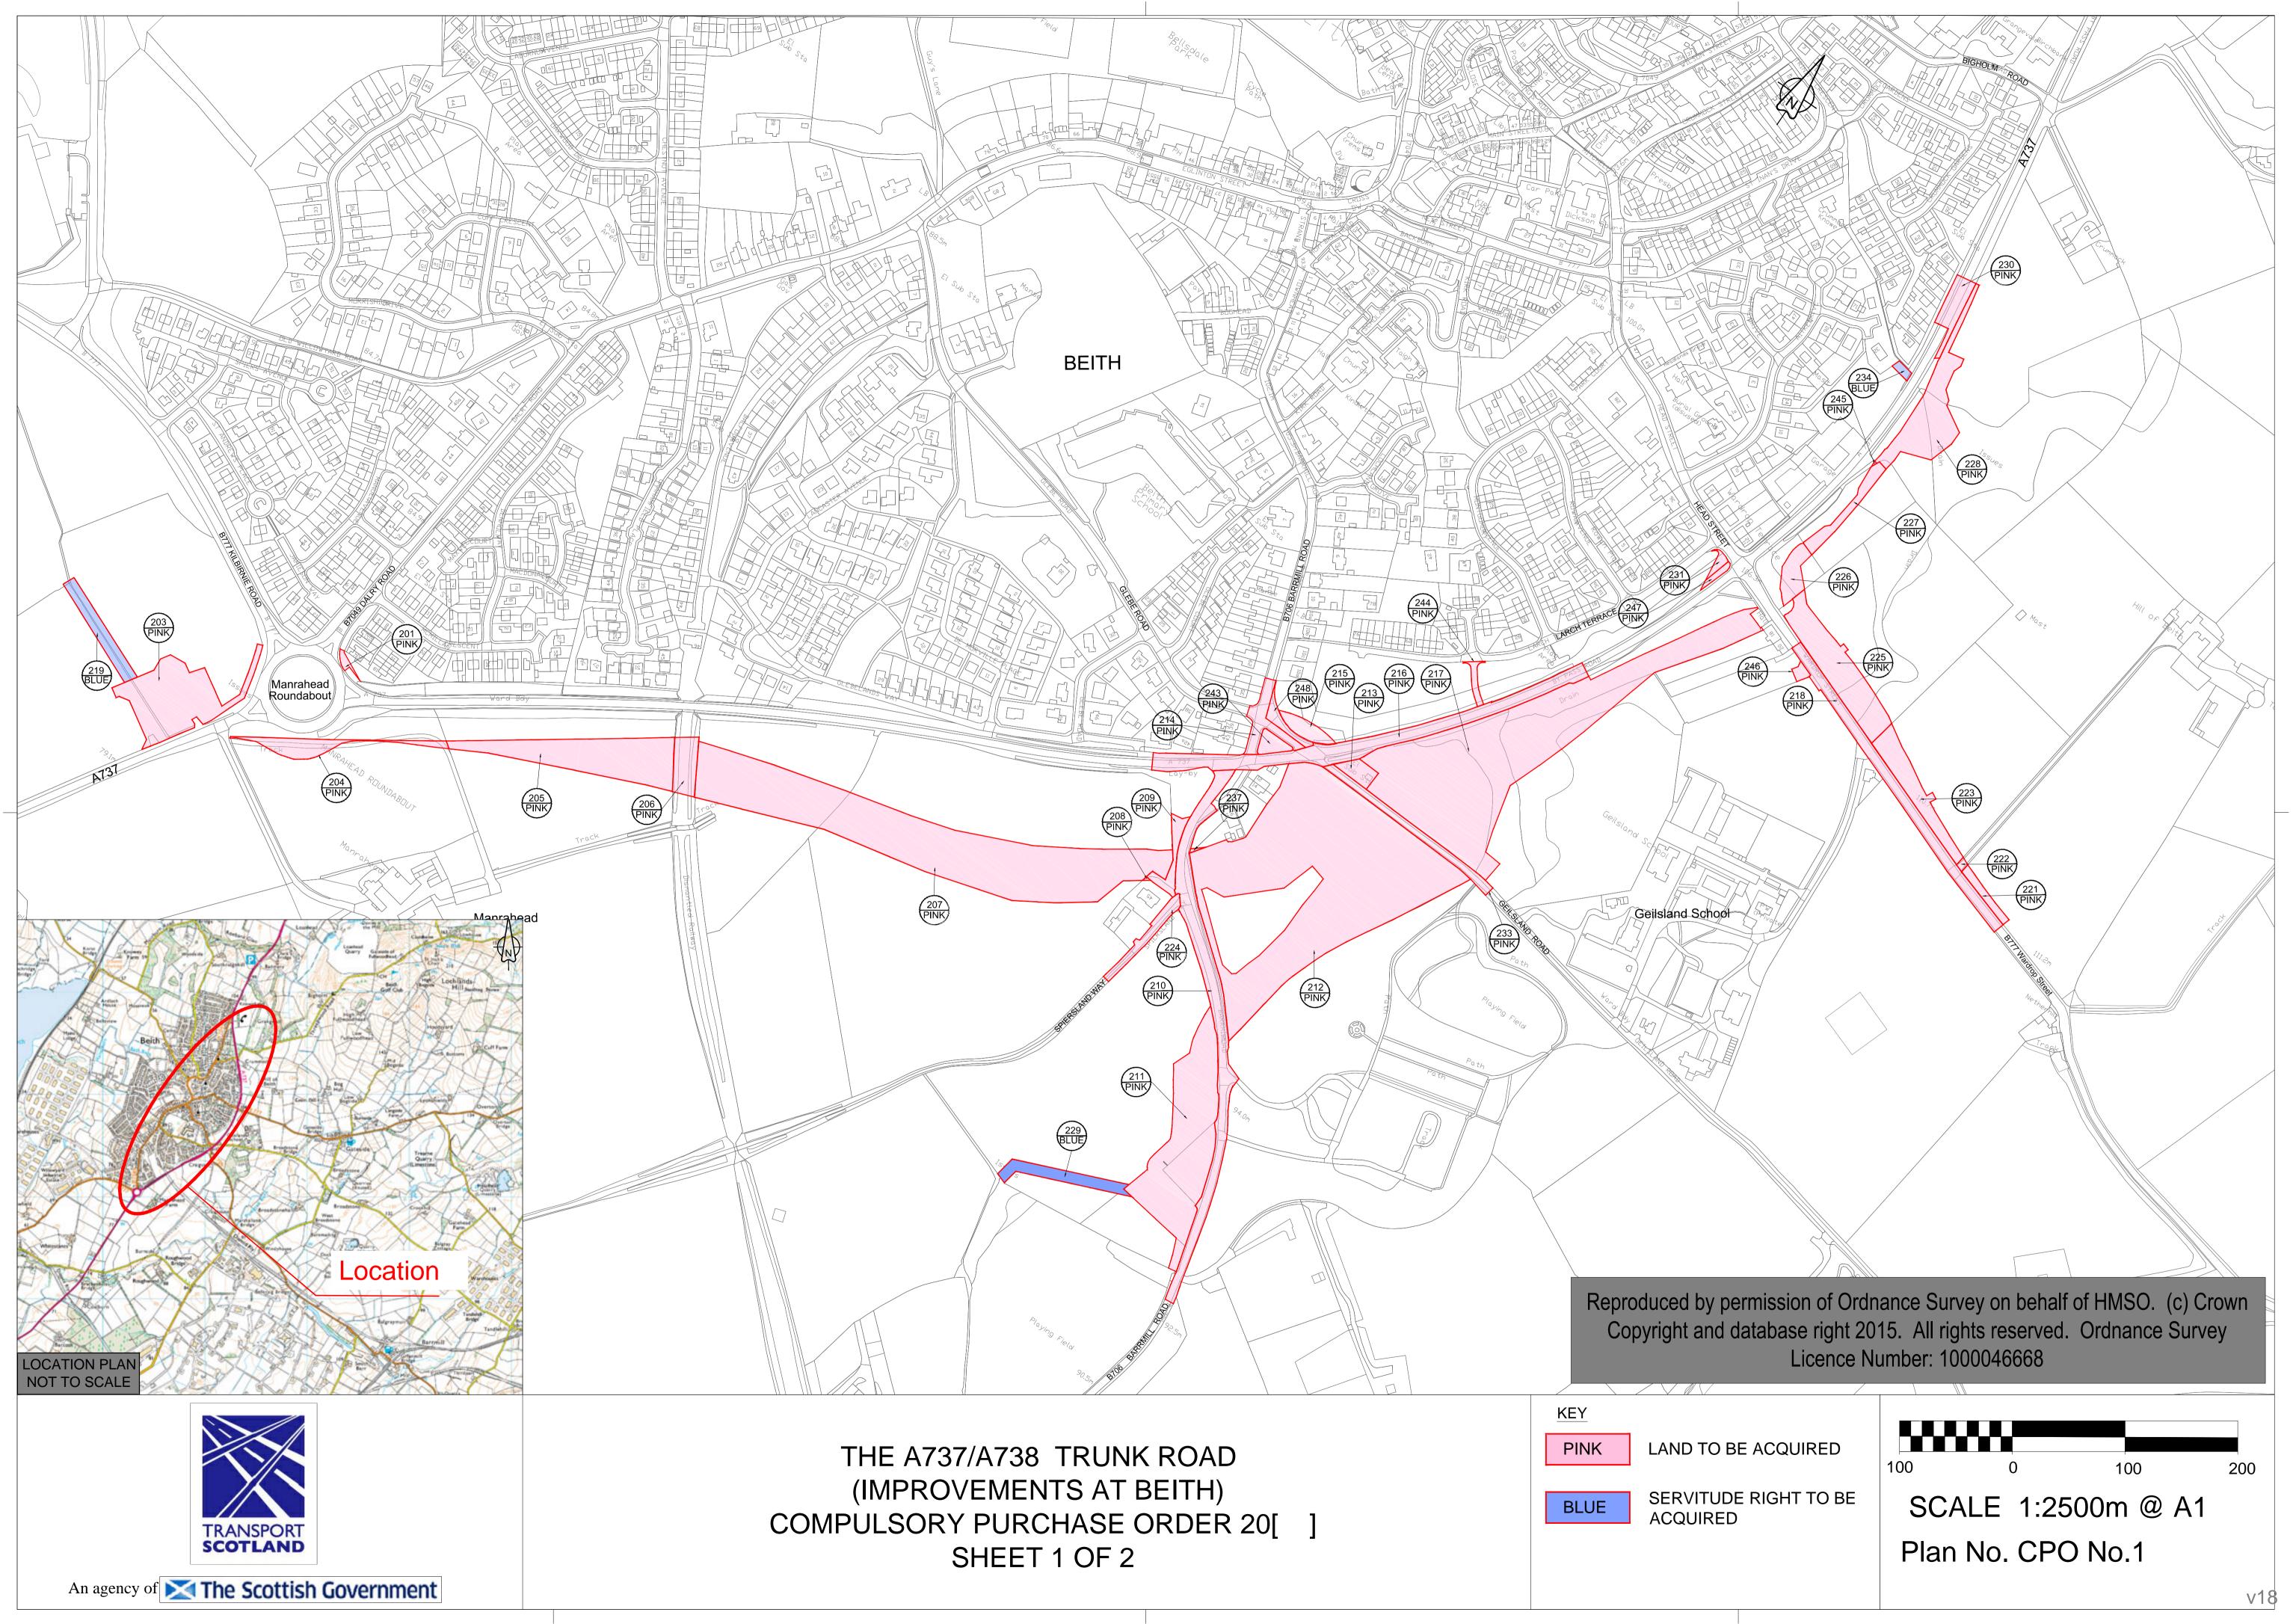


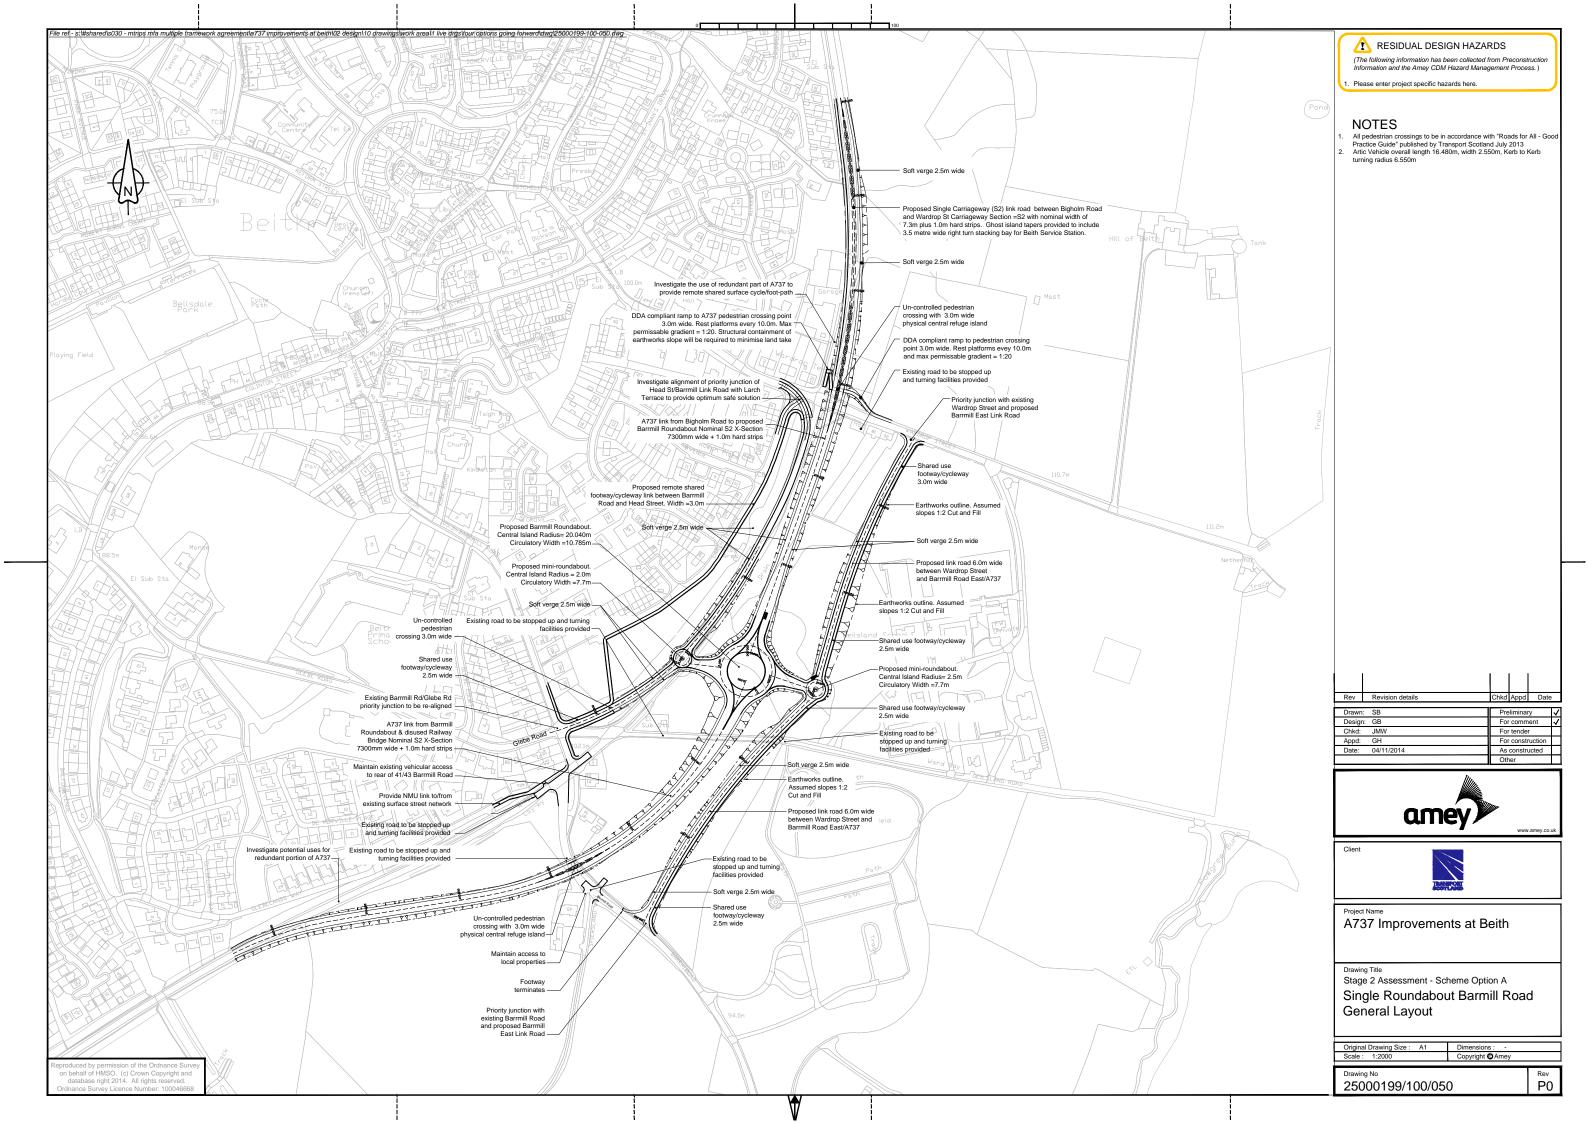


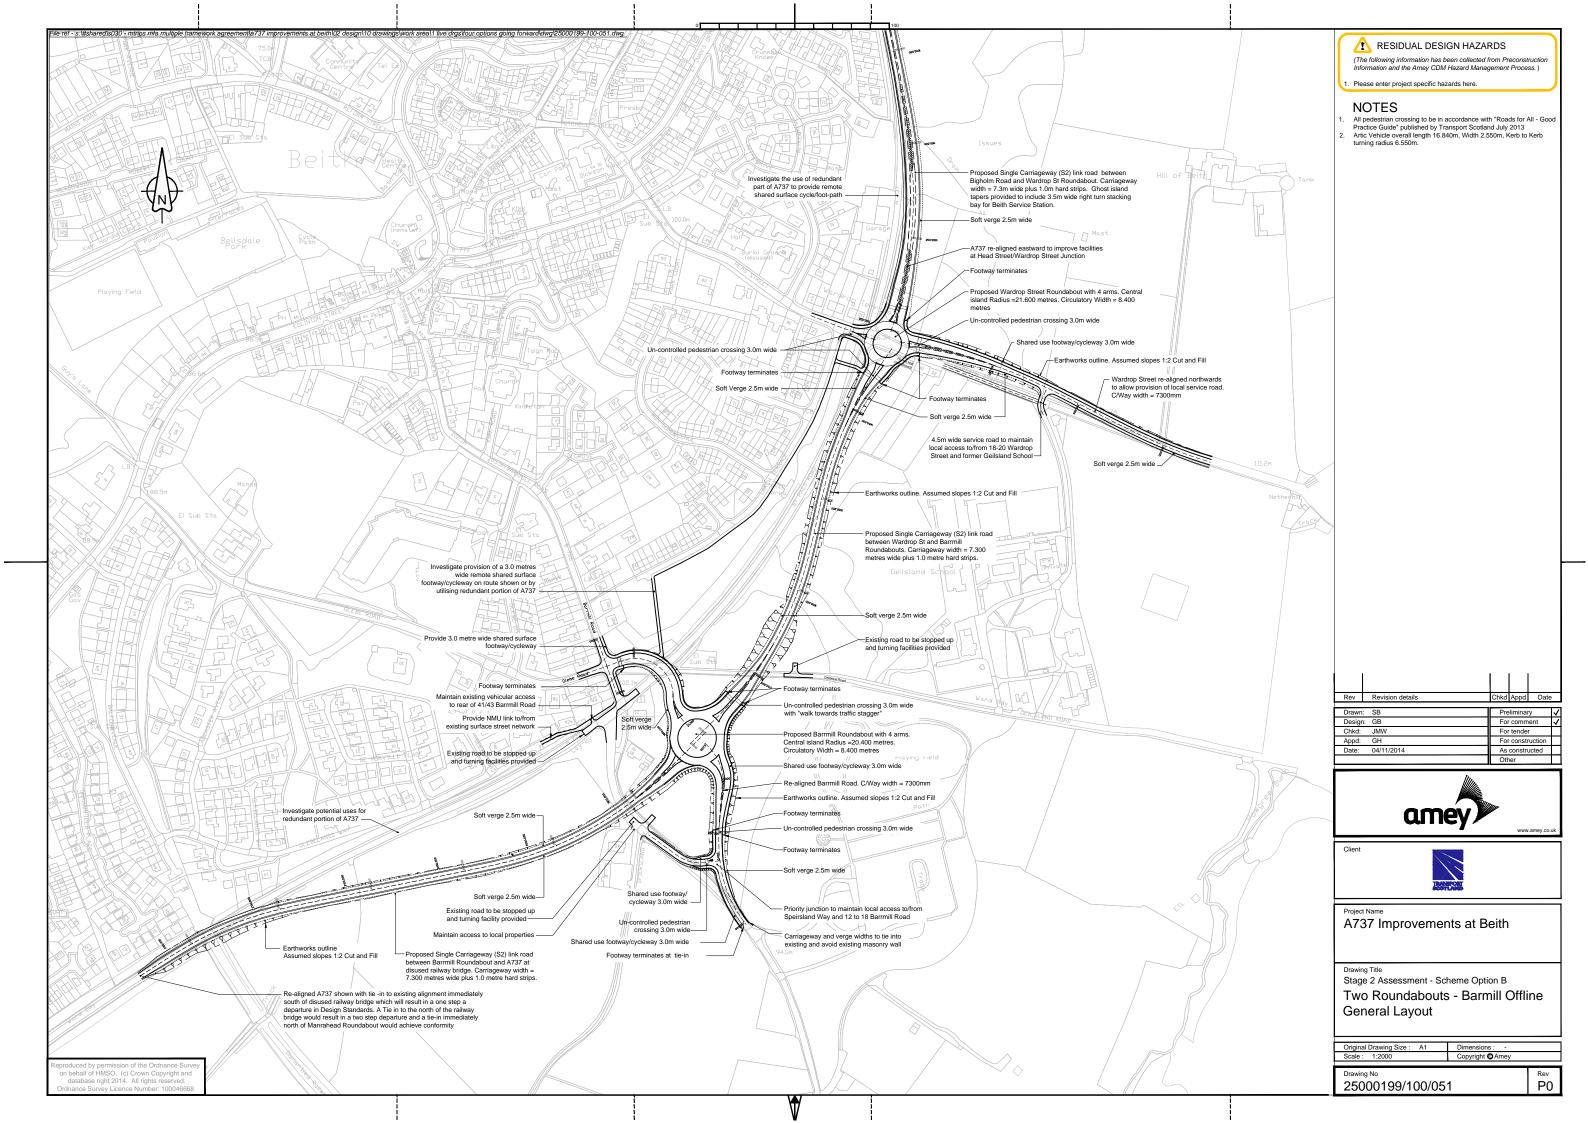

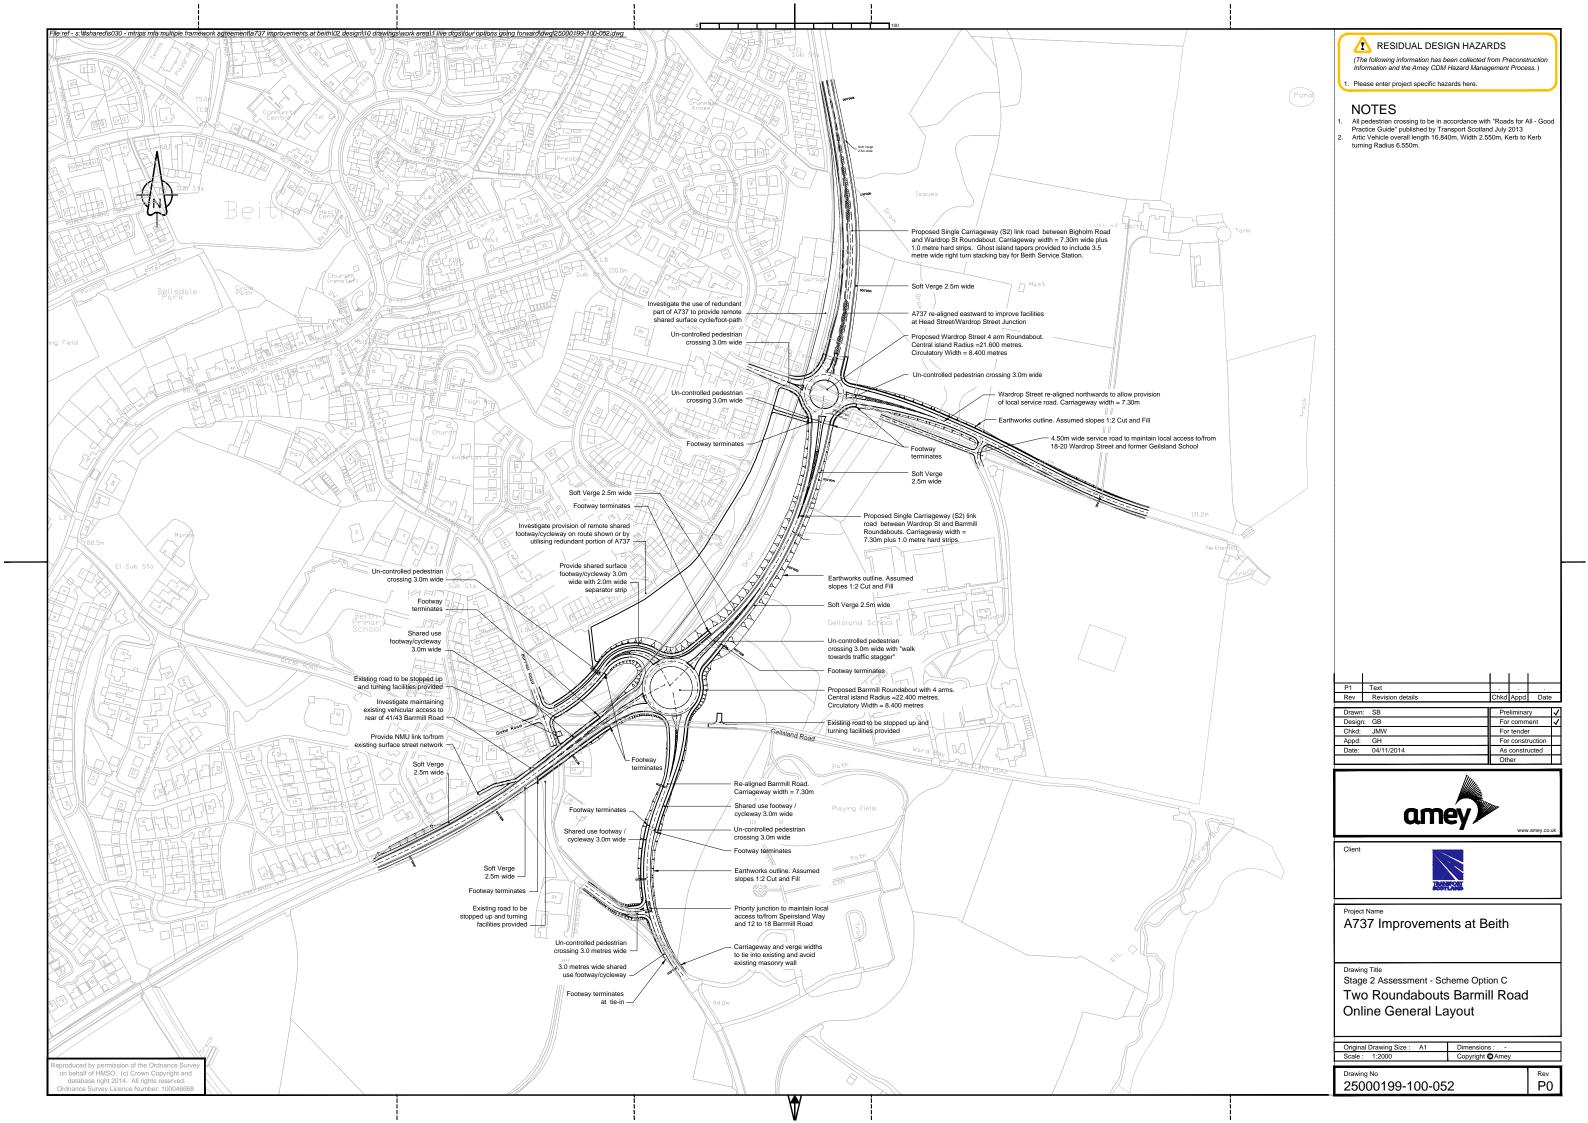

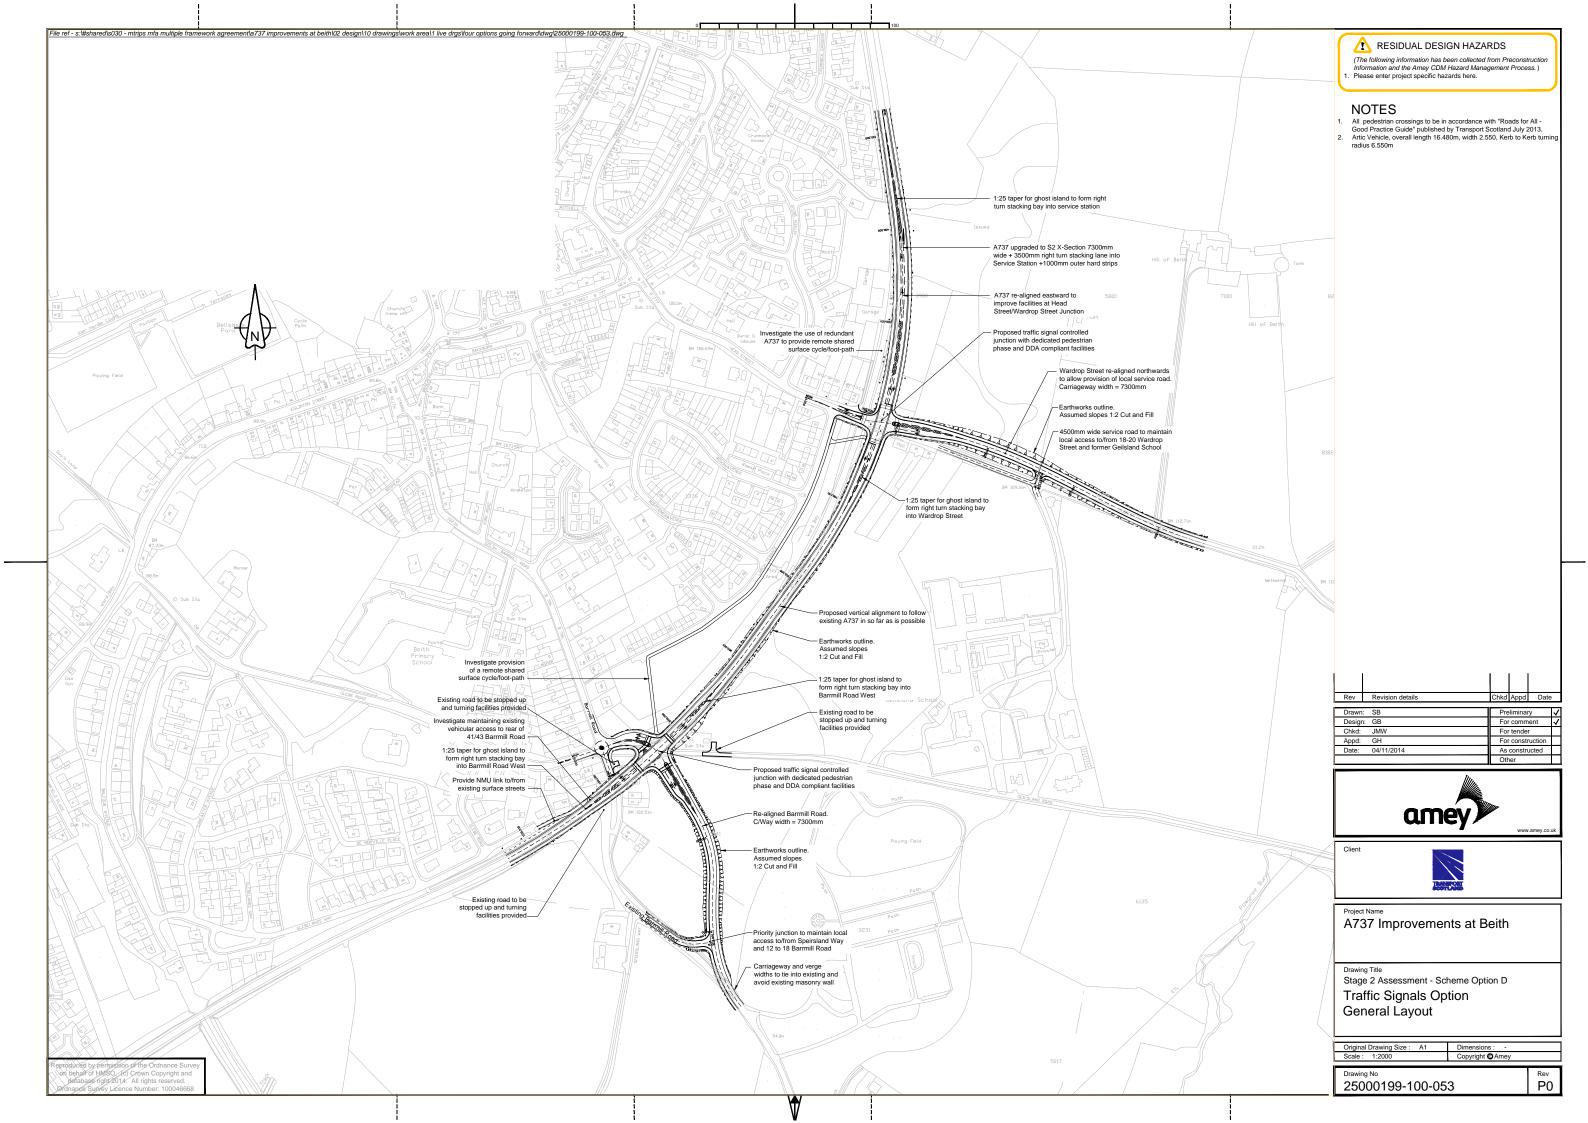

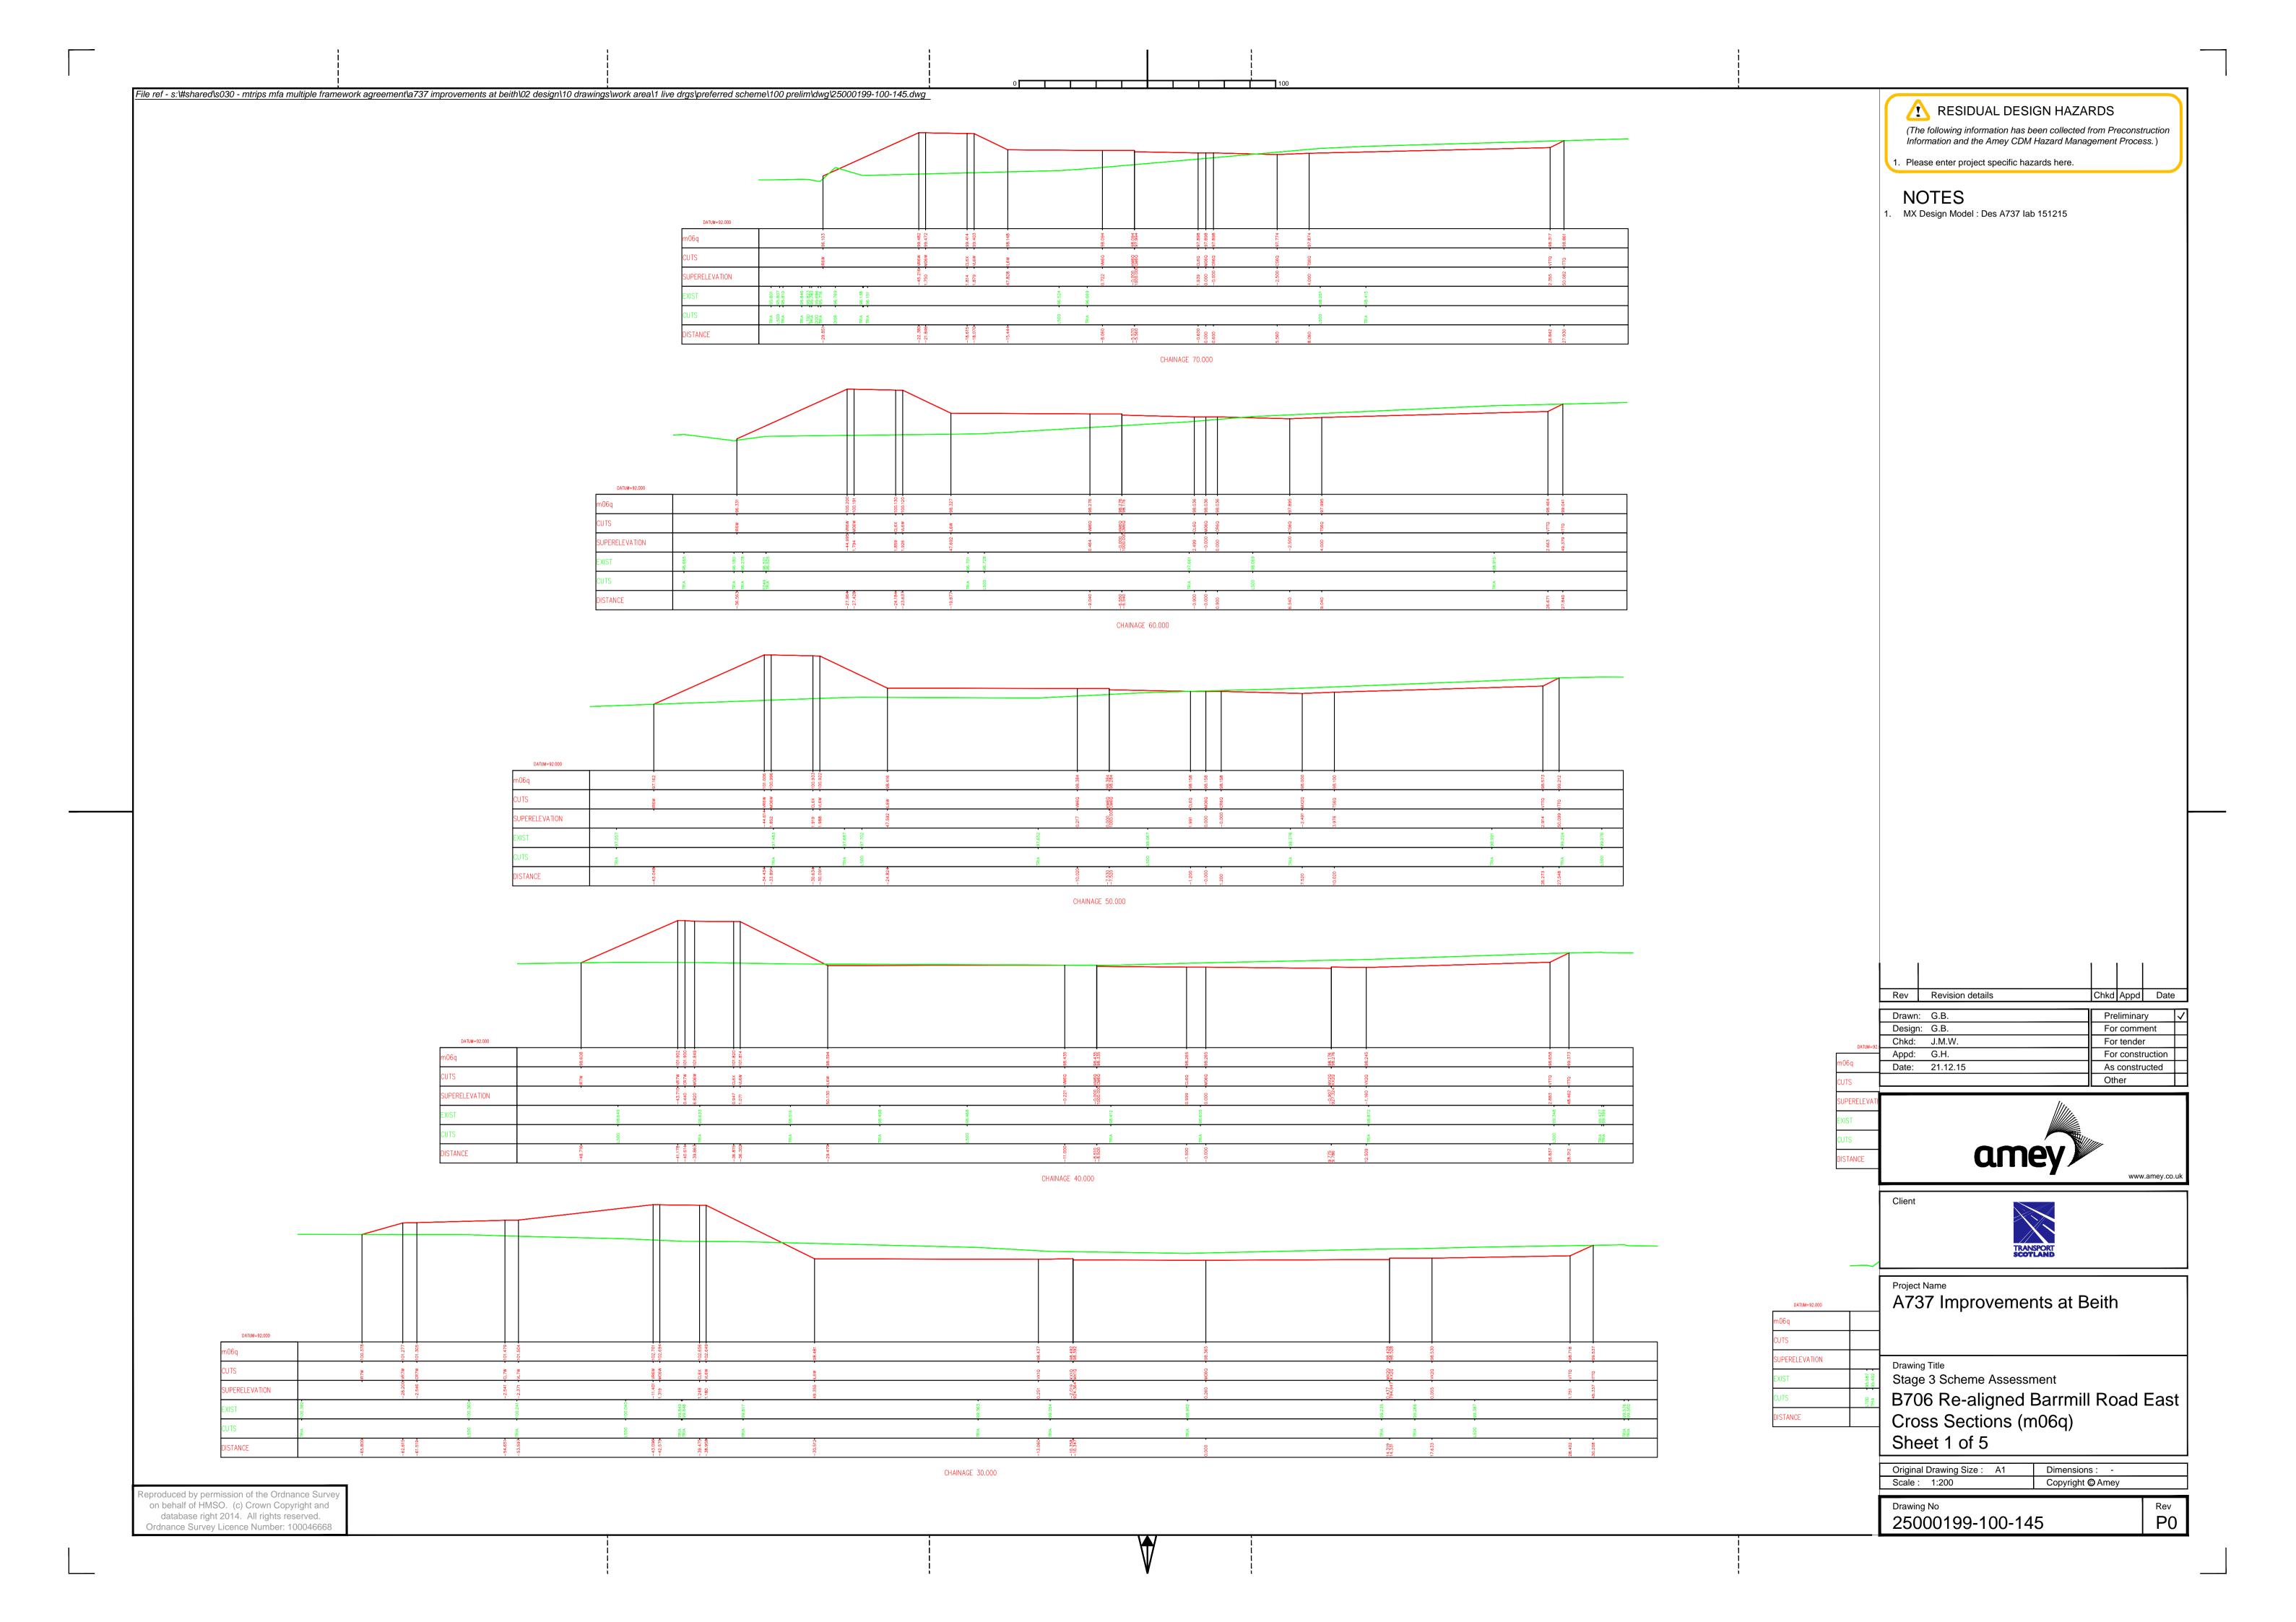

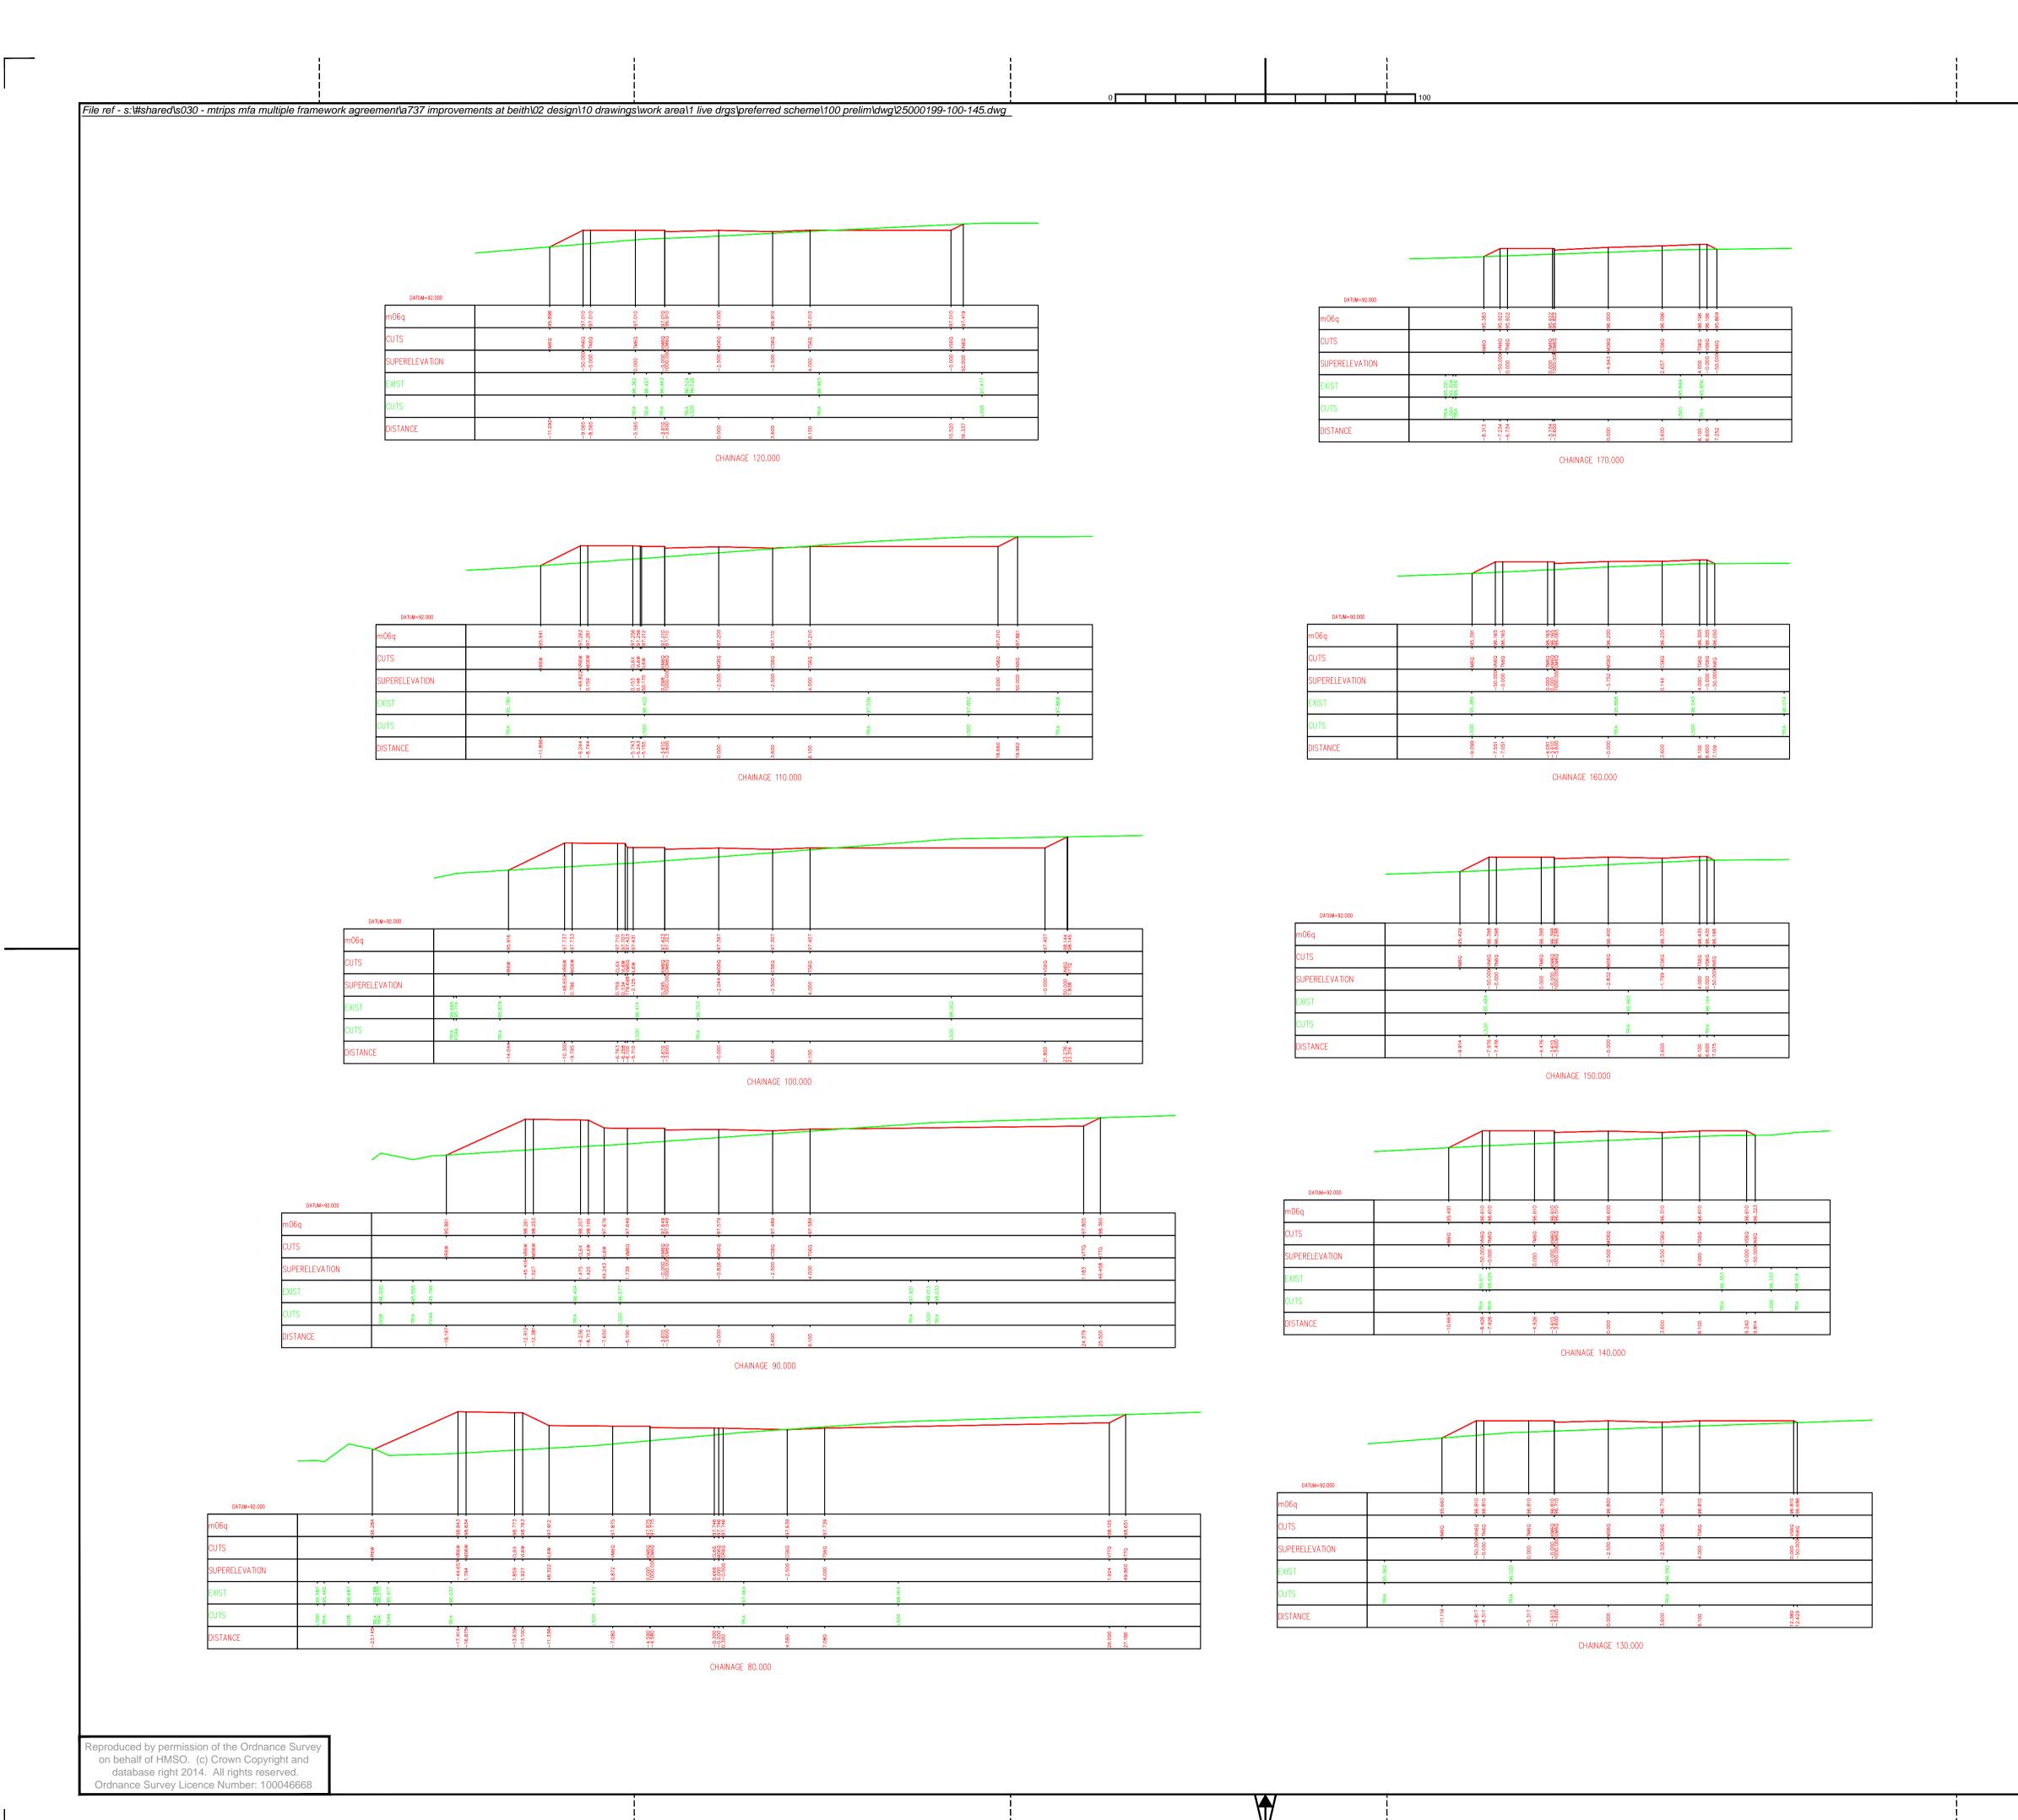

RESIDUAL DESIGN HAZARDS (The following information has been collected from Preconstruction Information and the Amey CDM Hazard Management Process.)

1. Please enter project specific hazards here.

NOTES

MX Design Model : Des A737 lab 151215

Chkd Appd Date Rev Revision details Drawn: G.B.
Design: G.B.
Chkd: J.M.W. Preliminary For comment For tender Appd: G.H. For construction Date: 21.12.15 As constructed Other





Project Name
A737 Improvements at Beith


Drawing Title
Stage 3 Scheme Assessment


B706 Re-aligned Barrmill Road East Cross Sections (m06q)

Sheet 2 of 5

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	Scale: 1:200	Copyright © Amey	
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Rev P0 Drawing No 2500199-100-146



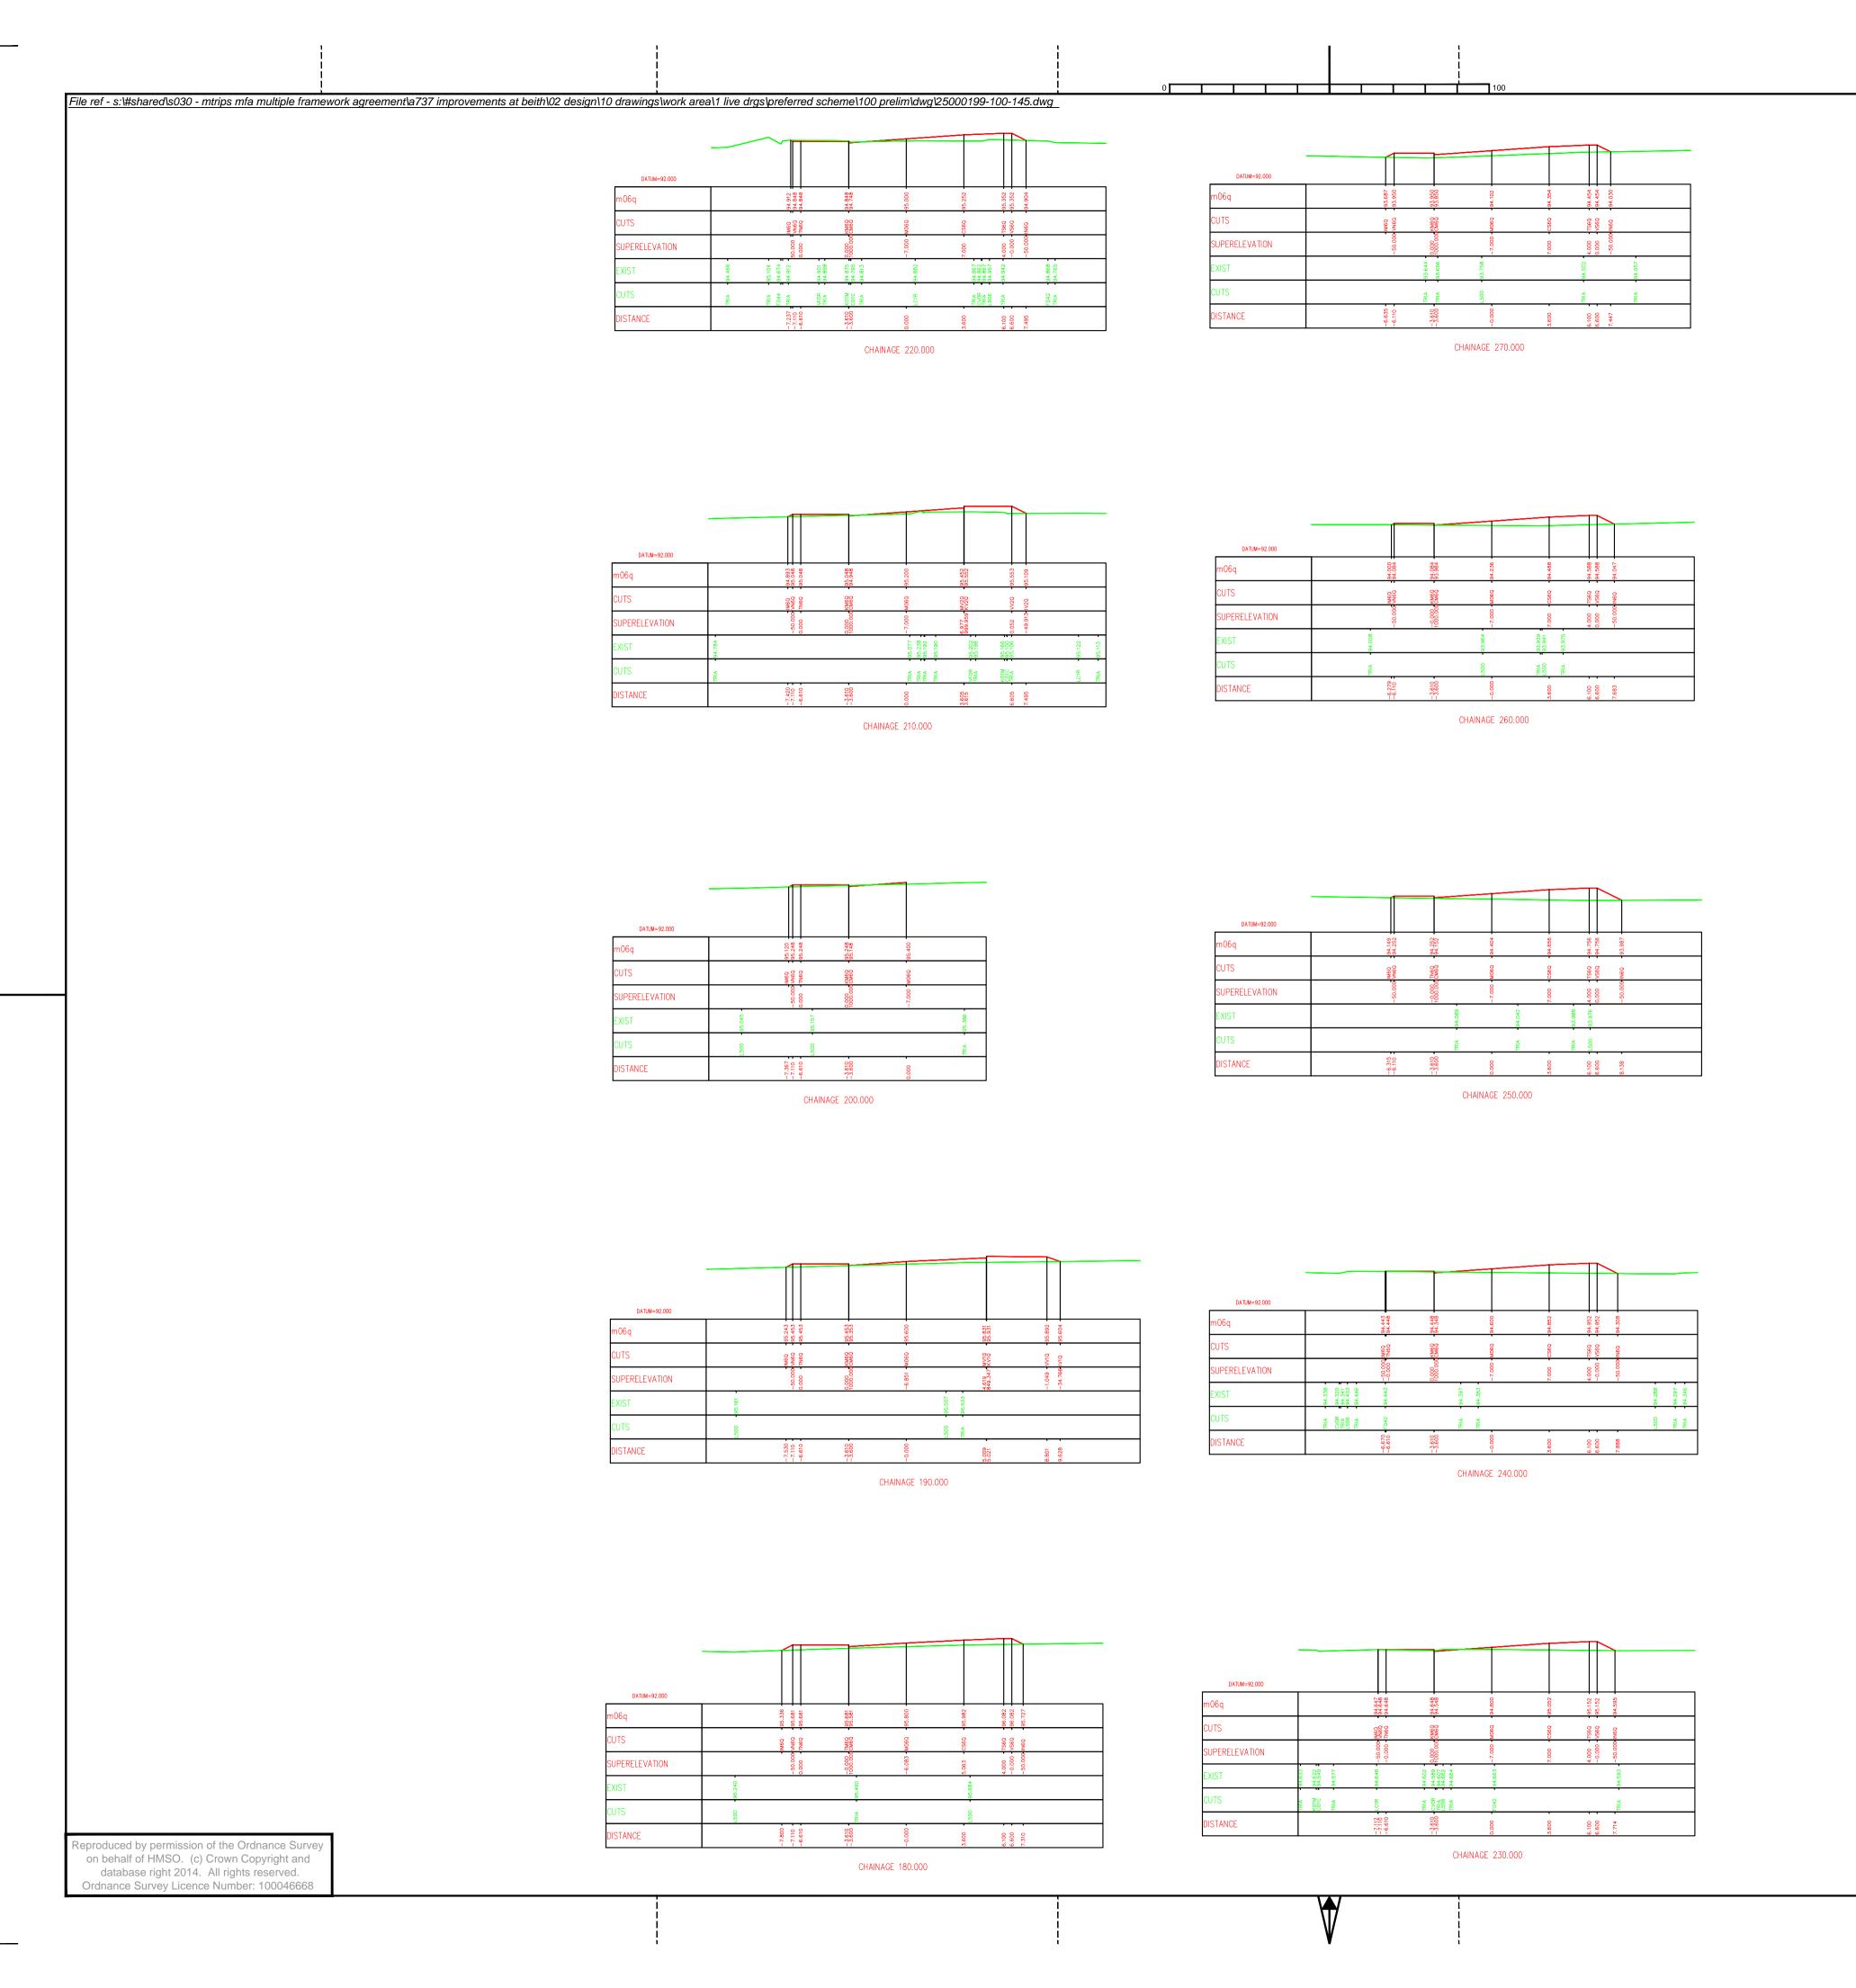

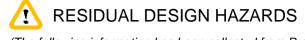(The following information has been collected from Preconstruction Information and the Amey CDM Hazard Management Process.)

1. Please enter project specific hazards here.

## NOTES

. MX Design Model : Des A737 lab 151215

Chkd Appd Date Rev Revision details Drawn: G.B.
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For comment For tender Appd: G.H. Date: 21.12.15 For construction As constructed



Other



Project Name
A737 Improvements at Beith


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Stage 3 Scheme Assessment


B706 Re-aligned Barrmill Road East Cross Sections (m06q)


Sheet 3 of 5


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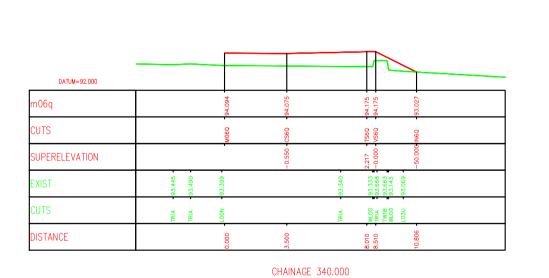
Rev P0 Drawing No 2500199-100-147



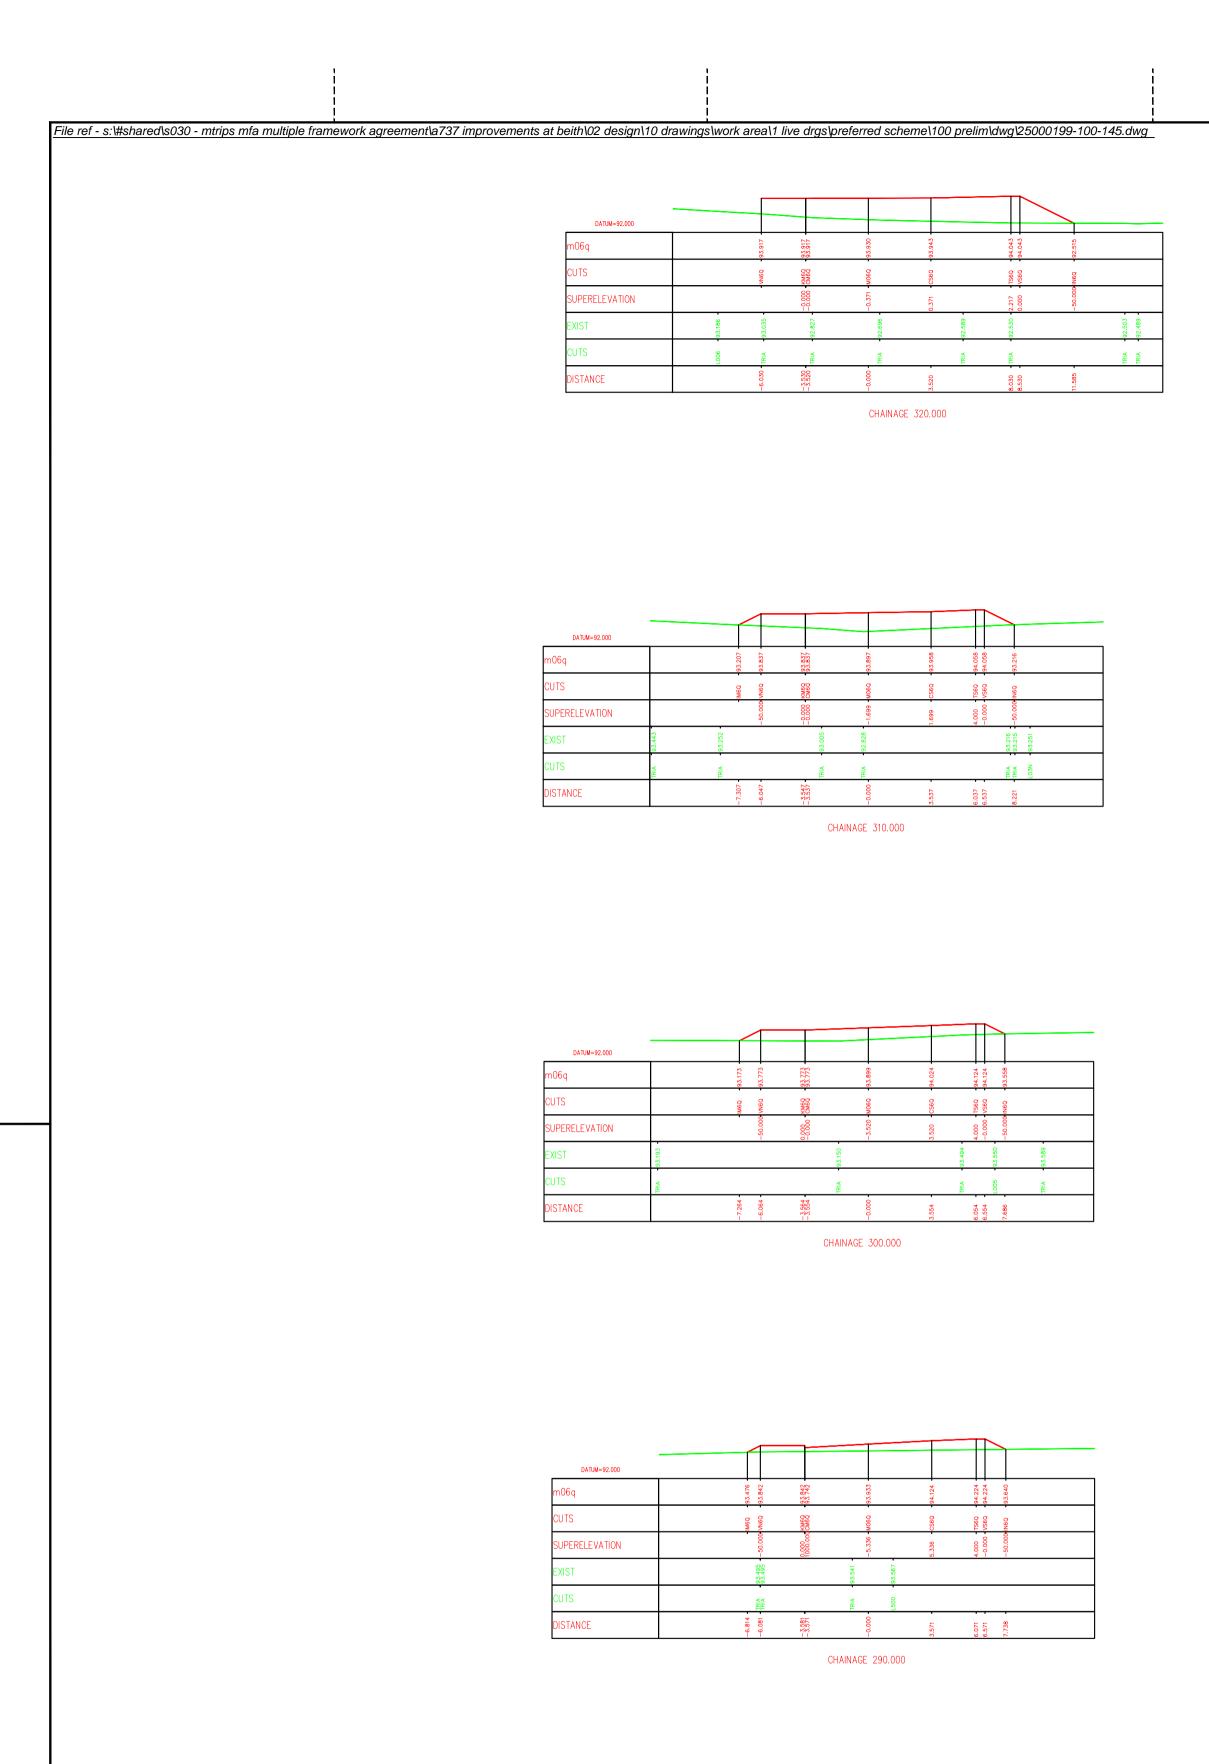

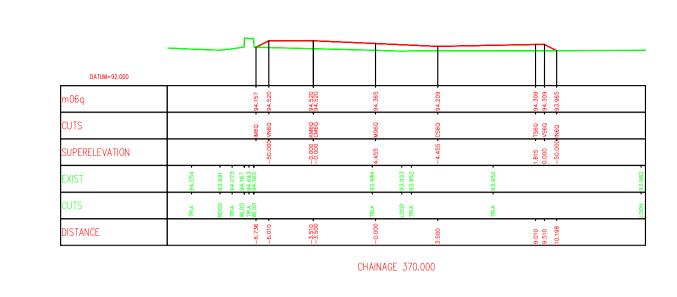

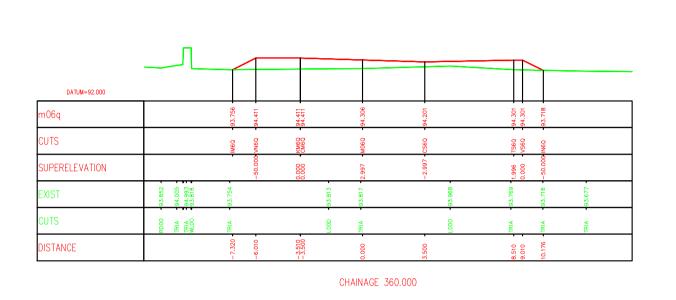

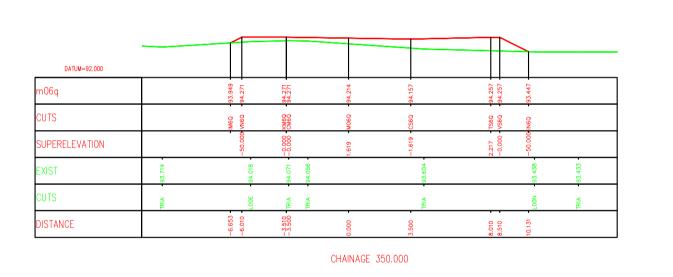

DATUM=92.000			$\perp$					
m06q			93.995				93.994	
CUTS			M06Q				- 0983	
SUPERELEVATION			ľ				-0.021 -	
EXIST	93.392 93.913 93.884 93.167	93.023		92.816	92.774	92.717		
CUTS	WL00 TRIA TWIB WL00	TRIA		TRIA	TRIA	L004	_	
DISTANCE			0.000				3.503	

Rev	Revision details	Chkd	Appd	Date	;
Drawn	: G.B.	Pre	limina	ry	<b>√</b>
Desigr	n: G.B.	For	comm	nent	
Chkd:	J.M.W.	For	tende	r	
Appd:	G.H.	For	const	ruction	
Date:	21.12.15	As	constr	ucted	
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. MX Design Model : Des A737 lab 151215

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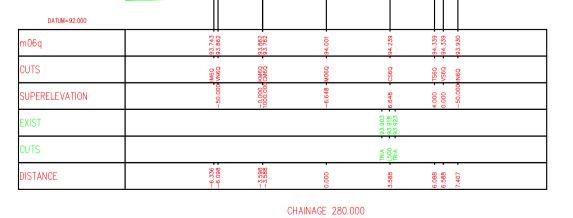


Project Name
A737 Improvements at Beith

Drawing Title
Stage 3 Scheme Assessment

B706 Re-aligned Barrmill Road East Cross Sections (m06q) Sheet 4 of 5


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Drawing No 2500199-100-148		Rev P0










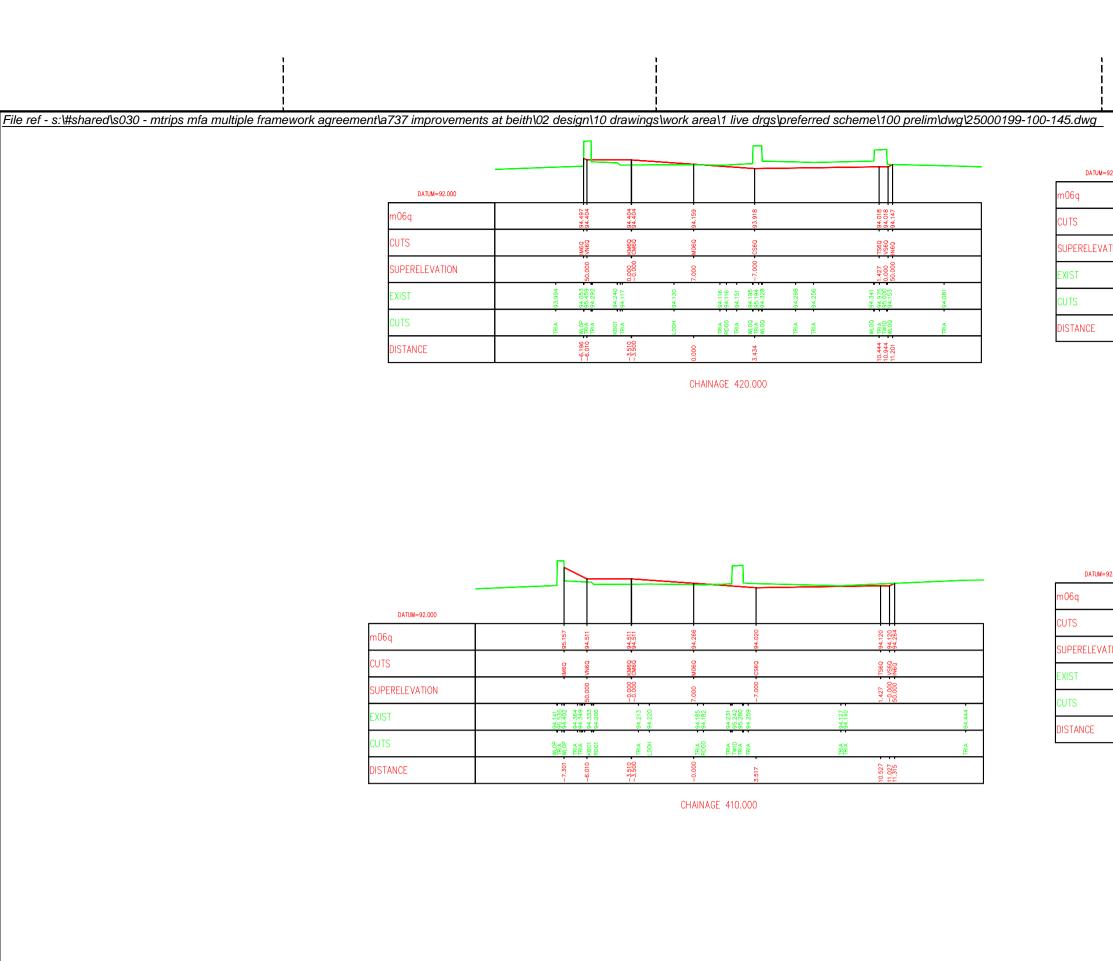


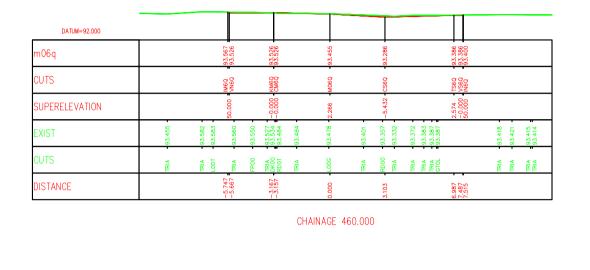


CHAINAGE 470.000

DATUM=92.000


PERELEVATION

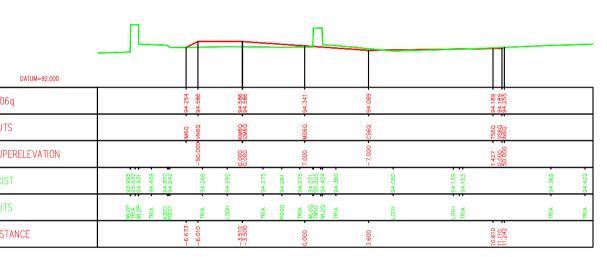

CHAINAGE 400.000

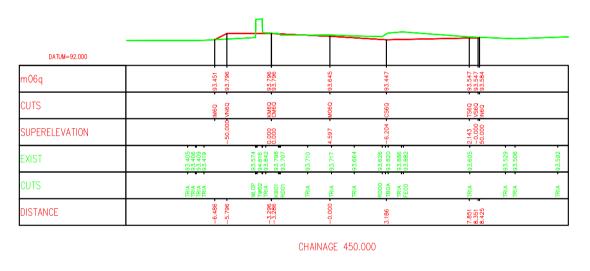

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CUTS	NN60	CW60 CW60	- Ф90М	- 0953	1560 V560 IN60	
SUPERELEVATION	50.000	0.000	0.960	-5.000 -	3.322 -0.000 50.000	
EXIST	93.367 - 93.432 -	93.283	93.254	93.099	93.394 93.382	93.119
CUTS	FE04	TRIA RD01	TRIA	RD00 TRIA	FE05 TRIA	TRIA
DISTANCE	-5.689 -5.522	-3.022	0.000	3.010	6.020 6.682 6.682	

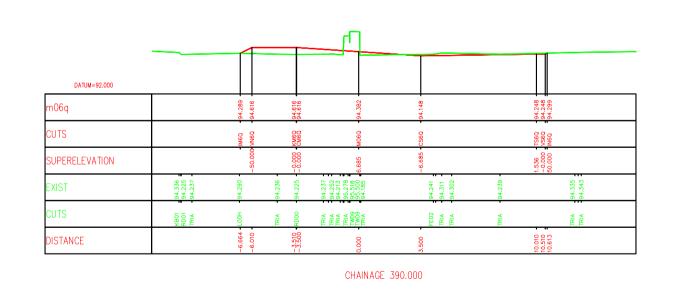

DATUM=92.000						
m06q		93.711	94.067	93.843	93.619	93.719 • 93.781 • 93.781
CUTS		M6Q	OWW OWW OWW OWW OWW OWW OWW OWW OWW OWW	- 090W	- 09SC	1560 - NS60 - NS
SUPERELEVATION		-50.000	000	6.570	- 6.858 -	50.000
EXIST	93.547 -		93.799 94.043 94.007 93.928 93.892 93.894	93.907 -	0 0 0 0 0 0 0 0 0 0 0 0 0 0 0 0 0 0 0	93.803 - 93.776 - 93.782 -
CUTS	L00V -		WLOP TRIA WLOP TRIA RD01		TEGO TRIA TWIE WLOR	TRIA
DISTANCE		-6.638 -	-3.426 -3.416	-0.000 -	3.268	8.716 9.216 9.339

DATUM=92.000															
m06q					94.592	94.592 94.592	94.390 -	94.188 -			94.288 94.288 94.091				
CUTS				Мбо	NNOC	00 999 WX	- МОБФ	• 09SO			TS6Q VS6Q IN6Q				
SUPERELEVATION				,	-20.000	0.0000	5.761	-5.761 -			1.664 0.000 -50.000				
EXIST	- 94.174 -	94.204	94.160	100	94.136	94.165 95.252 94.120		94.090	94.092	94.084		94.093	94.117	94.123	94 126
DUTS	TRIA	- H007	TRIA	9	TRIA	WL00 TRIA WL00		TRIA	NOON	TRIA		TRIA	TRIA	FE02 .	ě
DISTANCE				6 6	- 010.9-	-3.500 -3.500	-0.000 -	3.500			9.510 10.010 10.405				

					Γ		
DATUM=92.000							
m06q		93.786	94.262	94.017	93.783	93.883	
CUTS		- NNGQ -	MW 60 0	- 090W	- 0983	TS6Q - IN6Q -	
SUPERELEVATION		-50.000-	00	7.000	-7.000 -	1.606	
EXIST	93.633 -	93.848		94.012 -	94,008 94,009 94,042 94,018 93,972	94,062 94,102 94,043 94,033 94,033	
CUTS	LOOV -	WLOP TRIA		LOOH •	RD00 TRIA TRIA TRIA TRIA	MLOR WLOR TRIA TRIA TRIA TRIA	
DISTANCE		-6.964 -	-3.500	0.000	3.351	9.580 -	

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CHAINAGE 380.000

DATUM=92.000								
m06q		93.786 -	94.262	94.017	93.783	93.883		
CUTS		- Neg	KW60 OM60	- 090м	- 0950	TS6Q • VS6Q • IN6Q •		
SUPERELEVATION		-20.000	00	7.000	-7.000 -	1.606 - 50.000 - 50.000 -		
EXIST	93.633 -	93.848 95.848		94.002 -	94.008 94.009 94.042 94.018 95.014	94.102 <b>9</b> 94.088 <b>9</b> 94.043 <b>9</b>		
CUTS	LOOV -	WLOP TRIA		LOOH -	RD00 TRIA TRIA TRIA WLOR	MLOR • MLOR • TRIA • TRIA • TRIA		
DISTANCE		-6.964 -	-3.500	0.000	3.351	9.580 • 10.371		

CHAINAGE 430.000

(The following information has been collected from Preconstruction Information and the Amey CDM Hazard Management Process.)

RESIDUAL DESIGN HAZARDS

1. Please enter project specific hazards here.

NOTES

I. MX Design Model: Des A737 lab 151215

Rev	Revision details		Chkd	Appd	Date	;
Drawn	: G.B.		Preliminary		ry	Ī
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Chkd:	J.M.W.		For	tende	r	Ī
Appd:	G.H.		For	const	ruction	Γ
Date:	21.12.15		As	constr	ucted	Ι
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Project Name
A737 Improvements at Beith


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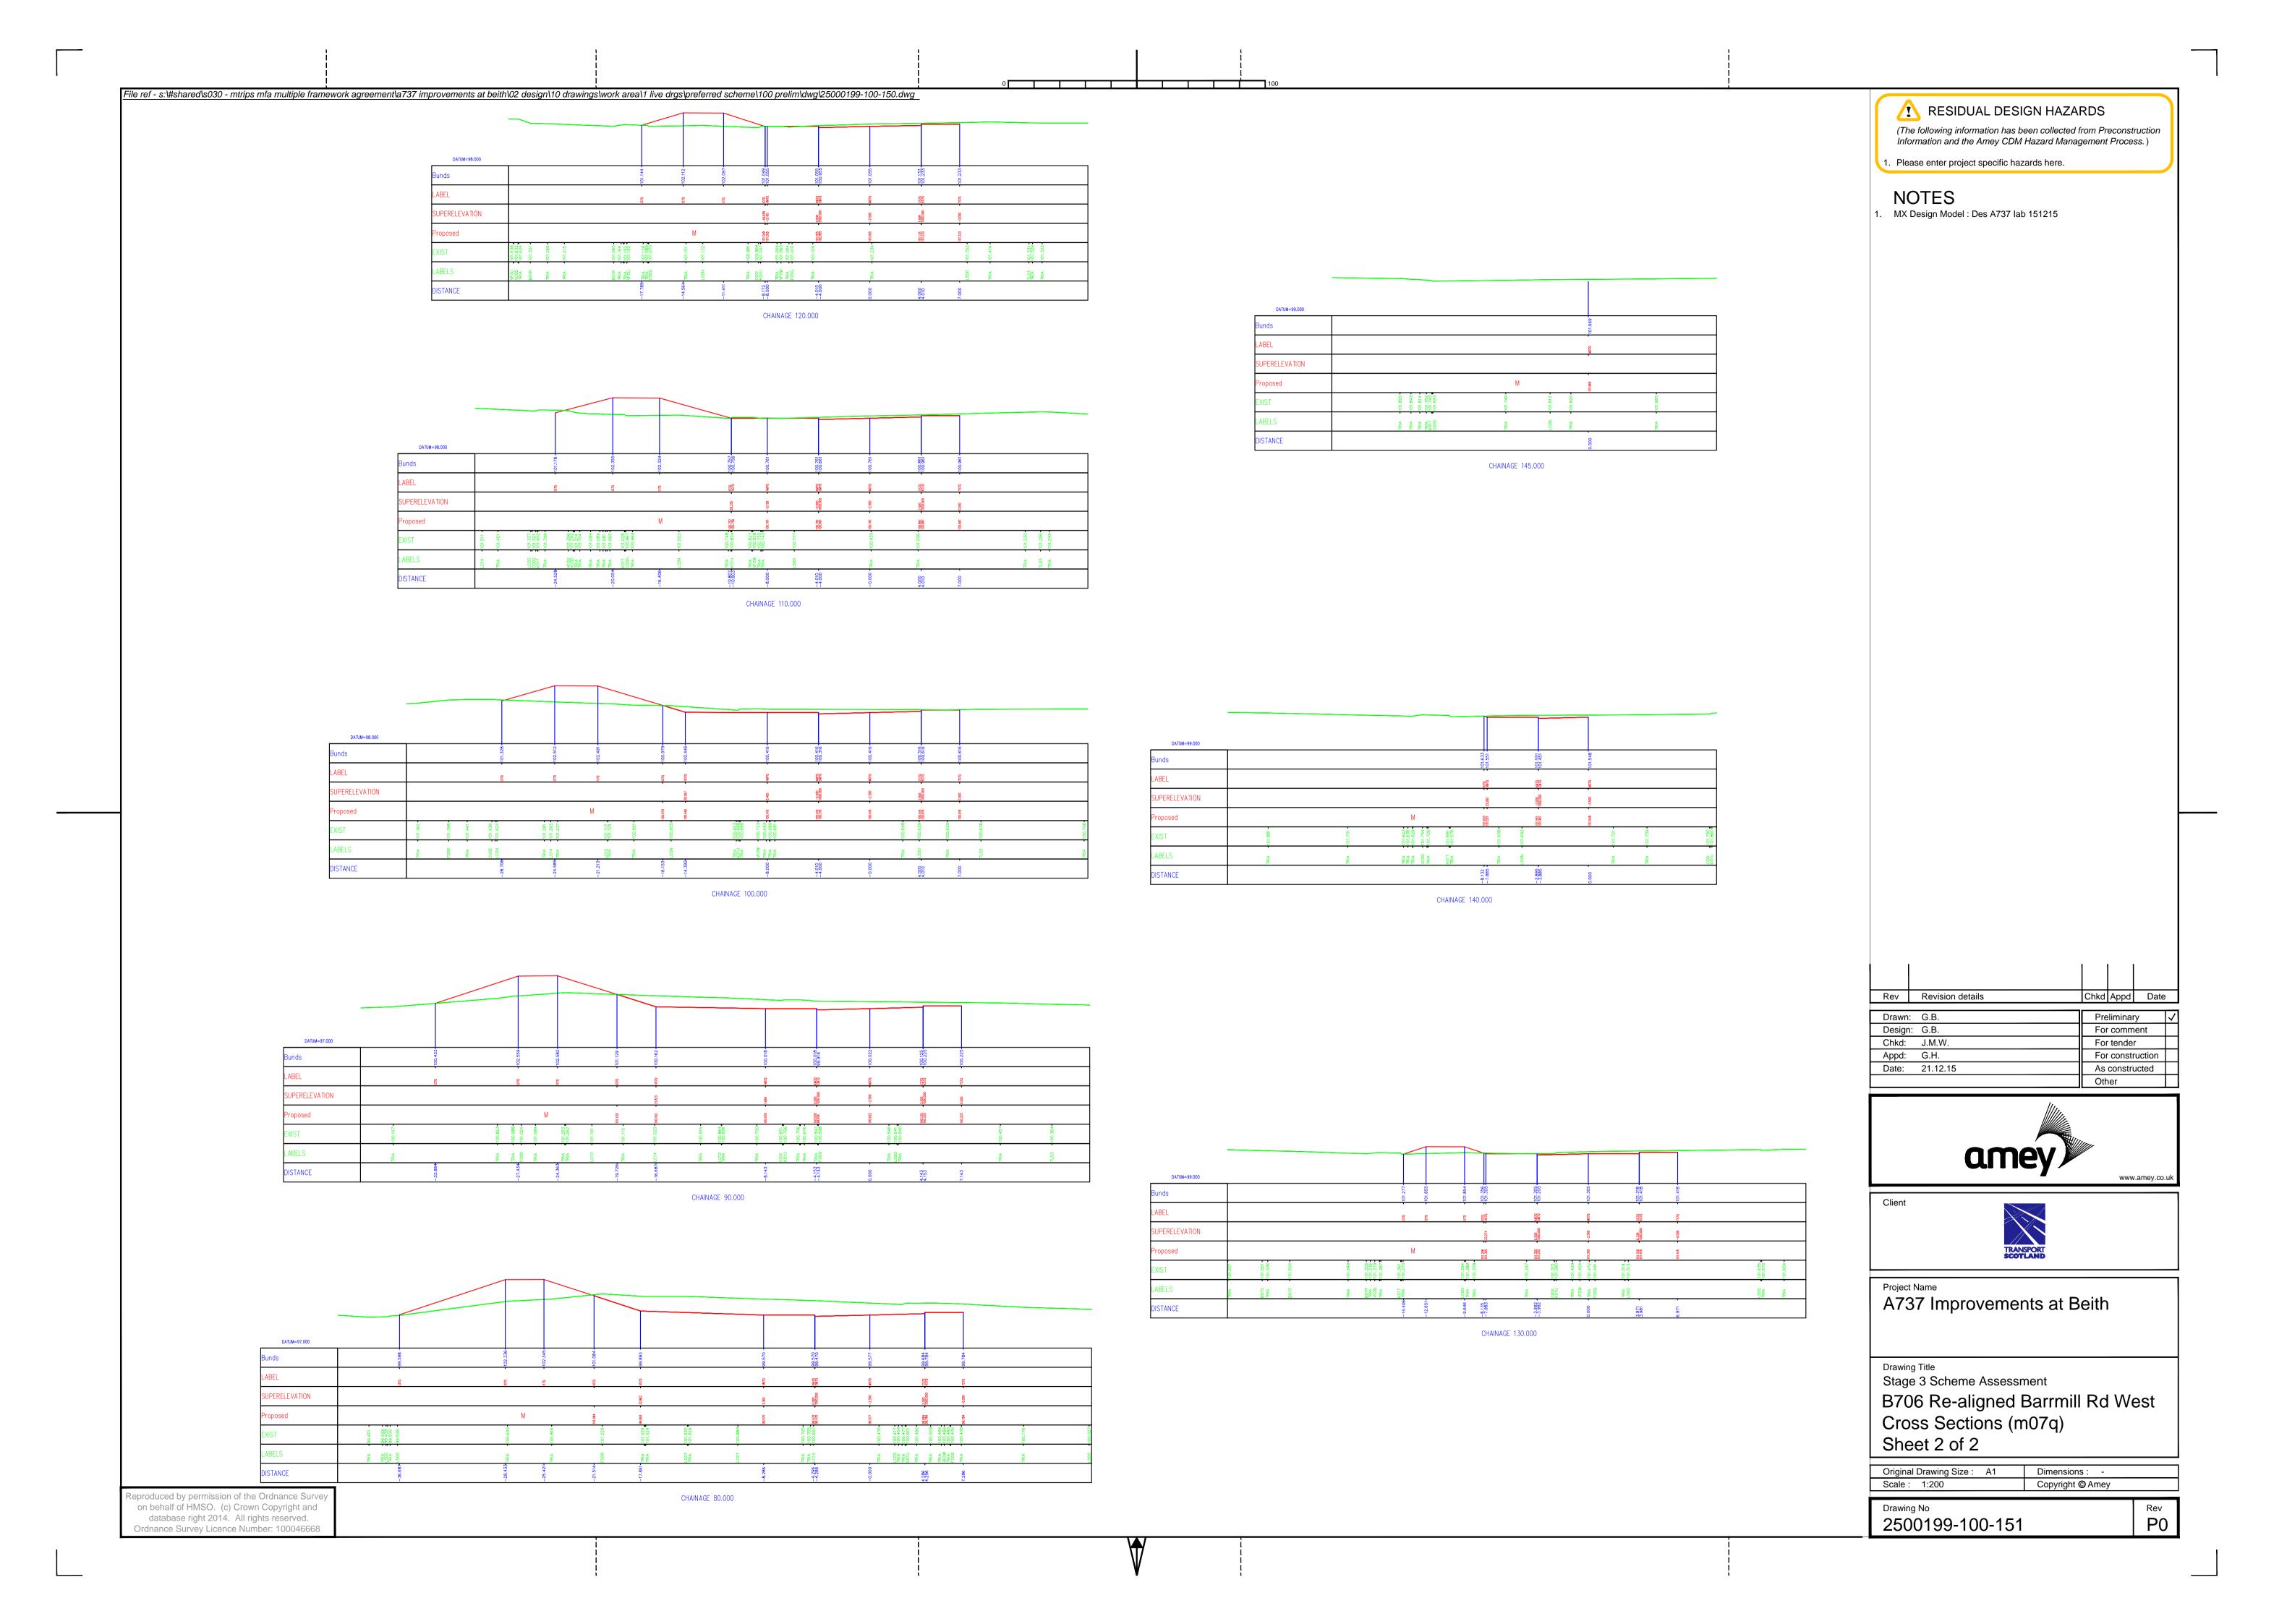
B706 Re-aligned Barrmill Road East Cross Sections (m06q)


Sheet 5 of 5


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Scale: 1:200	Copyright © Amey	
Drowing No.		Day

Drawing No 2500199-100-149 Rev P0



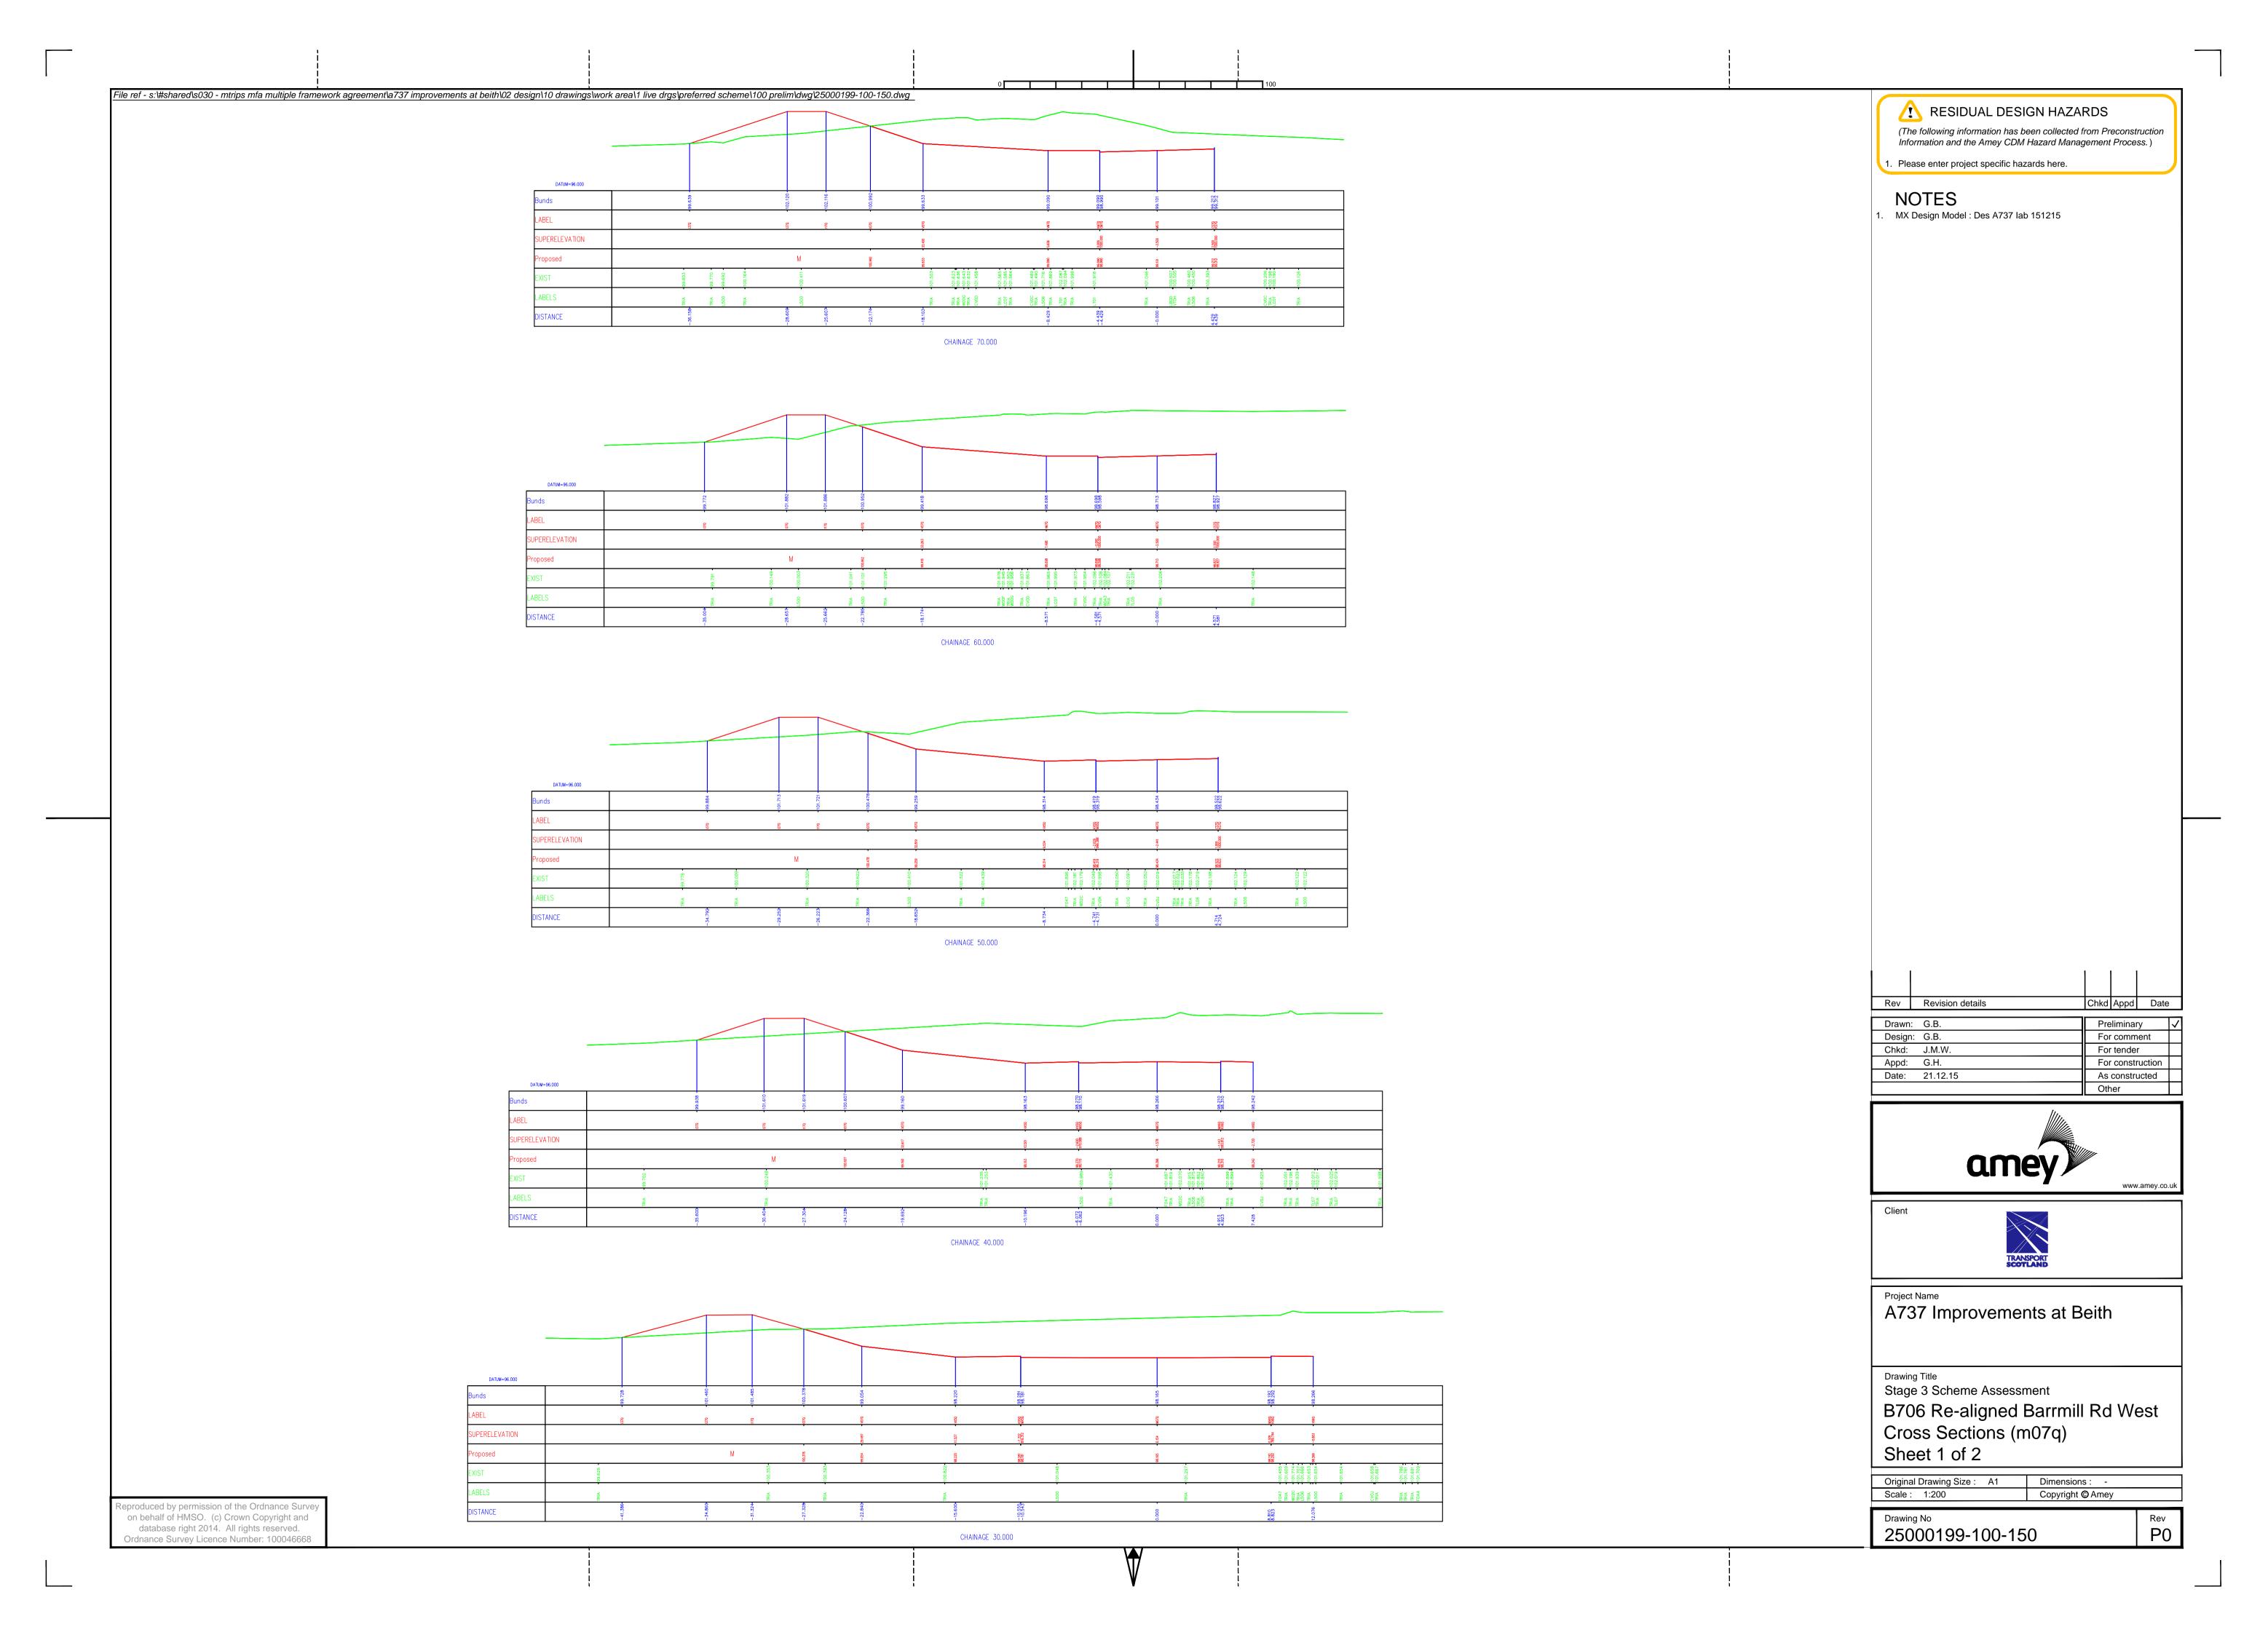

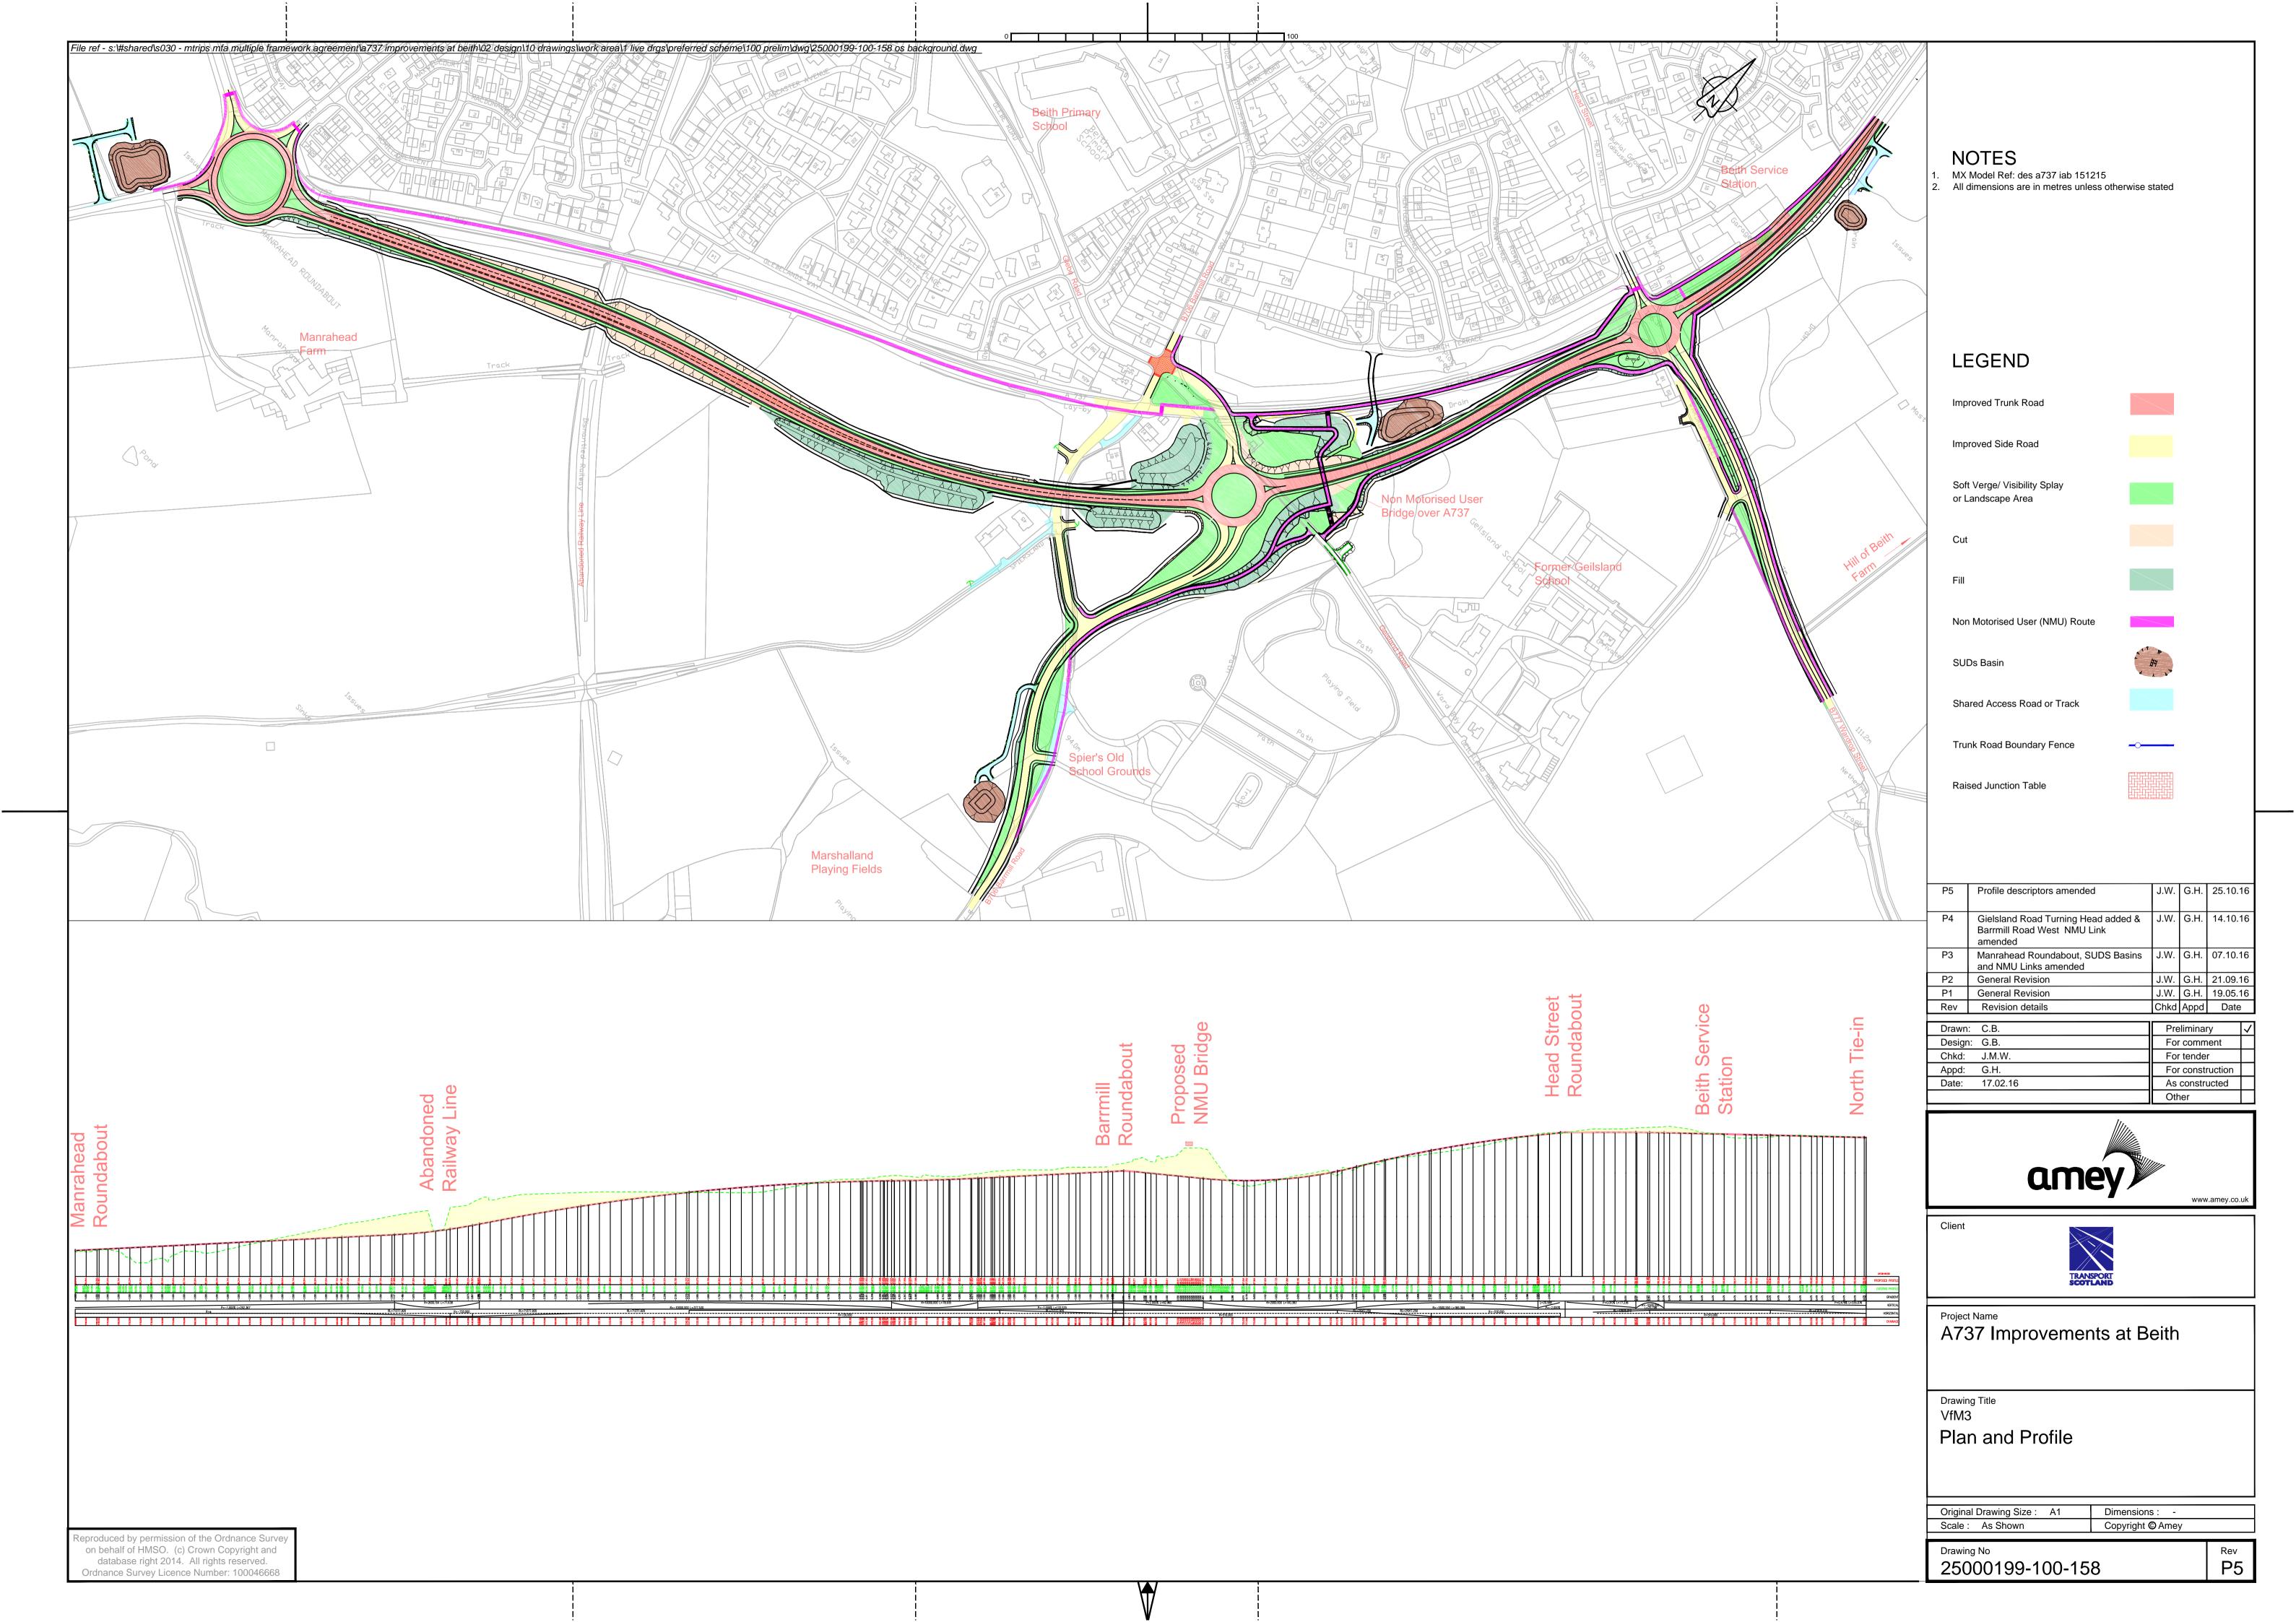

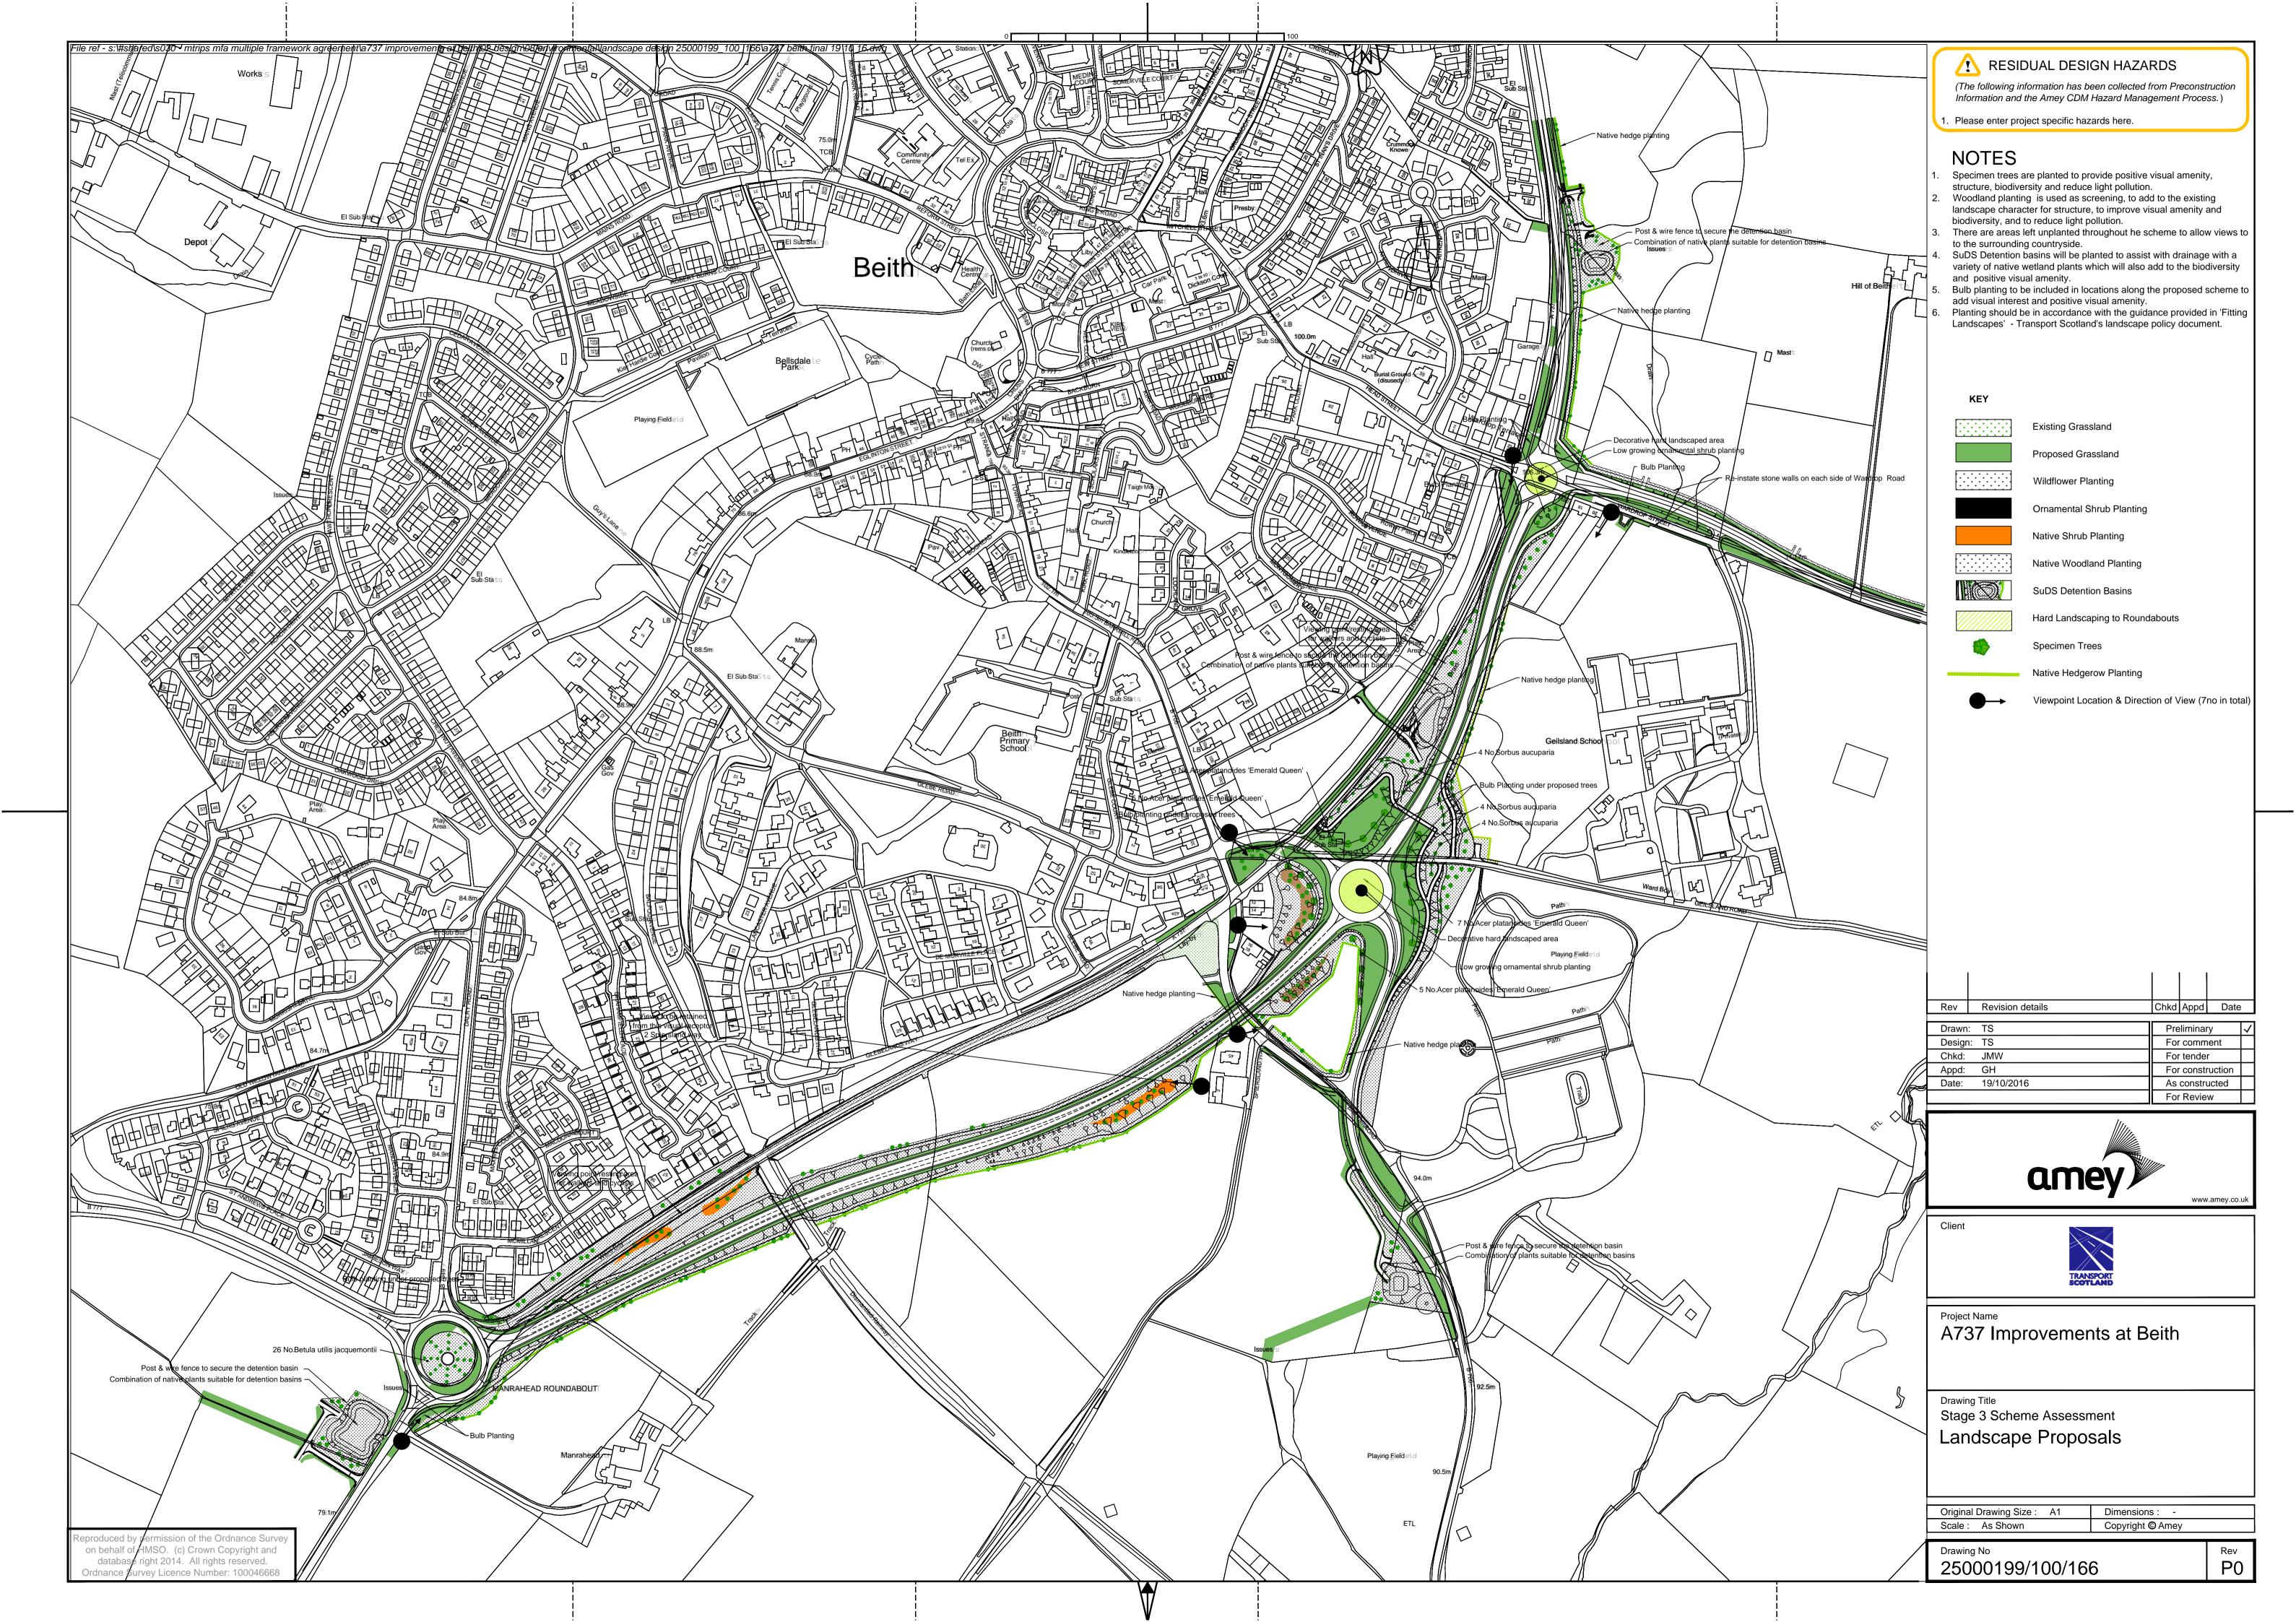



Viewpoint 4: Existing

Viewpoint 5: Existing (HGV Superimposed)

Version 6: Exisitng (HGV Superimposed)

Viewpoint 4: Prior to Planting

Viewpoint 5: Prior to Planting

Viewpoint 6: Prior to Planting



Viewpoint 1: Year 1

Viewpoint 2: Year 1



Viewpoint 1: Year 15

Viewpoint 2: Year 15









**NOTES** 

- Seven viewpoints are shown within this drawing. Location and direction of views are shown in the Landscape Proposals Drawing No. 25000199-100-166. Details of the location and direction of the views are provided below.
- 2. All viewpoints have the existing view prior to construction; views after construction but prior to mitigation, view after mitigation (Year 1) and after construction (Year 15). Viewpoints 1, 3, 5 & 7 also have the exisitng views which include an HGV to provide a sense of scale.

**Photomontage Details** 

Sony DSLR-A230 Date/Time Created: 24th August 2016 Sunny/Bright Weather: Height of camera above ground: 1.5m in all instances

Viewpoint 1: Adjacent 11-12 Head Street looking south east 28mm lens, 46 degrees field of view (FOV) Co-ordinates: 235317,653876 Direction of view: south east

Viewpoint 2: West of 20 Wardrop Street looking south west 30mm lens,67 degrees FOV Co-ordinates: 235410, 653823


Direction of view: south west Viewpoint 3: B706 Barrmill looking east 35mm lens,37 degrees FOV; adjusted to 30.87mm, 42 degrees FOV


Co-ordinates: 235410, 653823 Direction of view: east

**Viewpoint 4:** Between 14 & 16 B706 Barrmill looking east 28mm lens,46 degrees FOV Co-ordinates: 235072, 653451 Direction of view: east Notes: HGV not visible

Viewpoint 5: 45 Barrmill Road looking north east 28mm lens,46 degrees FOV Co-ordinates: 235062, 653338 Direction of view: north east

**Viewpoint 6:** 2 Spiersland Way looking west 28mm lens,46 degrees FOV Co-ordinates: 235037, 653292 Direction of view: west

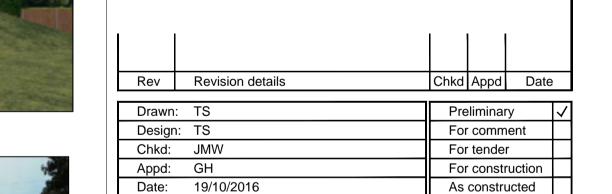

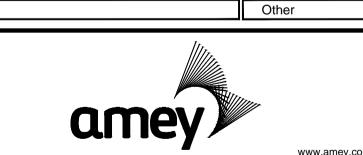



Client




Project Nar	ne
A737	Improvements at Beith

Drawing Title
Stage 3 Scheme Assessment Photomontages

Original Drawing Size: A1	Dimensions : -
Scale: Not to Scale	Copyright © Amey

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Viewpoint 6: Year 1

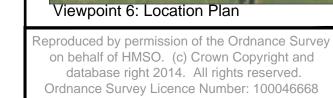